55.7± ACRES

WATER SUPPLY: EAST BAY MUNICIPAL UTILITY DISTRICT FIRE PROTECTION: CITY OF OAKLAND SEWAGE DISPOSAL: CITY OF OAKLAND STORM DRAIN: CITY OF OAKLAND

ELECTRIC: COMMUNICATION:

(ROW) PUBLIC RIGHT OF WAY (SDE) STORM DRAIN EASEMENT

(PUE) PUBLIC UTILITY EASEMENT

VESTING TENTATIVE TRACT MAP NO. 8562

HOWARD TERMINAL

CITY OF OAKLAND, ALAMEDA COUNTY, CALIFORNIA

GENERAL NOTES

VESTING TENTATIVE TRACT MAP: THIS VESTING TENTATIVE TRACT MAP IS BEING FILED IN ACCORDANCE SECTION 66452 OF THE SUBDIVISION MAP ACT.

MULTIPLE FINAL MAPS: PURSUANT TO SECTION 66463.1 OF THE SUBDIVISION MAP ACT. THE DEVELOPER RESERVES THE RIGHT TO FILE MULTIPLE FINAL MAPS. ONLY THE IMPROVEMENTS REQUIRED TO SUPPORT THE LEVEL OF DEVELOPMENT, AS DETERMINED BY THE CITY, OF EACH PARTICULAR FINAL MAP NEEDS TO BE COMPLETED OR BOUNDED.

SOURCE OF TOPOGRAPHY: EXISTING TOPOGRAPHY SHOWN IS BASED ON AN AERIAL TOPOGRAPHY SURVEY PREPARED FOR BKF ENGINEERS BY 360 AERIAL SURVEYS, COMPLETED

<u>UTILITIES:</u> UNDERGROUND UTILITIES PLOTTED HEREON WERE PLOTTED FROM A COMBINATION OF FIELD SURVEY, OBSERVED SURFACE EVIDENCE (CONDITIONS PERMITTING) AND RECORD INFORMATION OBTAINED FROM THE RESPECTIVE UTILITY COMPANIES, AND ARE NOT INTENDED TO REPRESENT THEIR ACTUAL LOCATIONS. ALL UTILITIES MUST BE VERIFIED WITH RESPECT TO SIZE, HORIZONTAL, AND VERTICAL LOCATIONS BY THE OWNER AND/OR CONTRACTOR PRIOR TO DESIGN OR CONSTRUCTION. NO RESPONSIBILITY IS ASSUMED BY THE ENGINEER FOR THE LOCATION AND CAPACITY OF SAID UTILITIES. ALL UTILITIES SHALL BE INSTALLED ACCORDING TO THE APPLICABLE STANDARDS AND REQUIREMENTS OF THE CITY OF OAKLAND. PROPOSED UTILITY SIZING AND LOCATIONS ARE SUBJECT TO FINAL ENGINEERING DESIGN.

SITE GRADES: SITE GRADES, INCLUDING PADS AND STREETS, AND LOT DIMENSIONS ARE SUBJECT TO FINAL ENGINEERING DESIGN.

FEMA DESIGNATED FLOOD ZONE: ZONE X AND ZONE AE.

ENGINEER'S STATEMENT

SURVEYOR'S STATEMENT

SIMON R. NORTH

P.E. #64657

P.L.S. #6868

BKF ENGINEERS

BKF ENGINEERS

PRINCIPAL/VICE PRESIDENT

PRINCIPAL/VICE PRESIDENT

BASIS OF BEARINGS

ZONE X: AREAS OF 0.2% ANNUAL CHANCE FLOOD: ALSO AREAS OF 1% ANNUAL CHANCE FLOOD WITH AVERAGE DEPTH LESS THAN 1 FOOT OR WITH DRAINAGE AREAS LESS THAN 1 SQUARE MILE. INFORMATION PER FLOOD INSURANCE RATE MAP (FIRM), NO. 06001C0066G, COMMUNITY NO. 065048 (CITY OF OAKLAND), PANEL 0066. EFFECTIVE

DATE AUGUST 3, 2009 FROM FEDERAL EMERGENCY MANAGEMENT AGENCY (FEMA) 6.2. ZONE X: AREAS OF MINIMAL FLOOD HAZARD PER FIRM, NO. 06001C0066G, COMMUNITY NO. 065048 (CITY OF OAKLAND), PANEL 0066, SUFFIX G. EFFECTIVE DATE AUGUST 3, 10. COMMERCIAL CONDOMINIUM UNITS: THERE IS NO UNIT-BASED LIMIT ON

6.3. ZONE AE: BASE FLOOD ELEVATION 10 FEET NAVD88 (4.23 COD) PER FIRM, NO. 06001C0067G, COMMUNITY NO. 065048 (CITY OF OAKLAND), PANEL 0066, SUFFIX G, EFFECTIVE DATE AUGUST 3, 2009 FROM FEMA.

DEDICATIONS, EASEMENTS, AND RIGHT OF ENTRY: ADDITIONAL AND SPECIFIED DEDICATION OF PROPERTY RIGHTS AND RIGHTS OF ENTRY AS NECESSARY TO ACCOMMODATE ALL DRAINAGE FACILITIES, SEWER FACILITIES, PUBLIC UTILITY EASEMENTS, AND OTHER EASEMENTS AS MAY BE NECESSARY TO PROPERLY SERVE THE LOTS CREATED SHALL BE DEDICATED AS PART OF THE FILING OF FUTURE FINAL MAPS.

TOTAL AUTHORIZED DWELLING UNITS: THE WATERFRONT BALLPARK DISTRICT PROJECT THAT WAS THE SUBJECT OF CITY COUNCIL RESOLUTION ______ (ADOPTING ENVIRONMENTAL FINDINGS PURSUANT TO THE CALIFORNIA ENVIRONMENTAL QUALITY ACT)

INCLUDES UP TO 3,000 RESIDENTIAL DWELLING UNITS WITHIN THE SUBDIVISION (HEREAFTER

THE "TOTAL AUTHORIZED DWELLING UNITS"). THE PROPOSED PARCELIZATION SUMMARY TABLE 1A ON SHEET [11] IDENTIFIES LOTS [2, 3, 4, 5, 6, 7, 9, 10, 11 AND 12. AS THE 12. CEQA.THE FINAL ENVIRONMENTAL IMPACT REPORT FOR THE WATERFRONT MIXED USE LOTS WITHIN THE SUBDIVISION ON WHICH RESIDENTIAL CONDOMINIUM PROJECTS MAY BE DEVELOPED (THE "RESIDENTIAL CONDOMINIUM BLOCKS"). THE NUMBER OF TOTAL RESIDENTIAL CONDOMINIUM UNITS PER RESIDENTIAL CONDOMINIÚM BLOCK REPRESENTS THE ANTICIPATED NUMBER OF RESIDENTIAL CONDOMINIUM UNITS PER

THIS VESTING TENTATIVE TRACT MAP SUBMITTAL HAS BEEN PREPARED BY ME

THIS VESTING TENTATIVE TRACT MAP SUBMITTAL HAS BEEN PREPARED BY ME

OR UNDER MY DIRECTION IN ACCORDANCE WITH STANDARD SURVEYING PRACTICE.

BEARINGS SHOWN HEREON ARE BASED ON THE CALIFORNIA COORDINATE SYSTEM (NAD 83)

ZONE 3., EPOCH 1968, PER FAST STATIC GPS TIES TO POINTS 1007, 1033, AND 1061 AS

SHOWN ON THE RECORD OF SURVEY MAP PREPARED BY CROSS LAND SURVEYING IN 1993,

FILED IN BOOK 18 OF SURVEYS, AT PAGES 50 THROUGH 60 (A.K.A. RS 990) HOLDING THE

ELEVATIONS SHOWN HEREON ARE BASED ON THE PORT OF OAKLAND BENCHMARK KNOWN

POTOMAC YACHT SOUTHWEST OF THE INTERSECTION OF CLAY STREET AND WATER STREET.

ELEVATION = 9.39 FEET (NAVD88). FOR THIS PROJECT, THIS VALUE HAS BEEN CONVERTED

AS "PORT 1", AN NGS FIRST ORDER, CLASS I BENCHMARK, PID HT0654, A BRASS DISC

("USC&GS, PORT 1") SET IN CONCRETE WALK AT F.D.R. PIER AND ENTRANCE TO THE

TO CITY OF OAKLAND DATUM BY SUBTRACTING 5.77 FEET, RESULTING IN AN

OR UNDER MY DIRECTION IN ACCORDANCE WITH STANDARD ENGINEERING PRACTICE.

09/23/2022

09/23/2022

No. 64657

No. 6868

RESIDENTIAL CONDOMINIUM BLOCK WITHIN THE SUBDIVISION PURSUANT TO WHICH SUBDIVIDER MAY SEEK APPROVAL THROUGH PHASED FINAL MAPS. EACH PHASED FINAL MAP SHALL INCLUDE AN ACCOUNTING OF THE TOTAL RESIDENTIAL UNITS ONSITE. THE UNIT COUNTS IDENTIFIED IN TABLE 1A FOR THE RESIDENTIAL CONDOMINIUM BLOCKS DO NOT REPRESENT THE MAXIMUM NUMBER OF RESIDENTIAL CONDOMINIUM UNITS THAT MAY BE APPROVED ON A FINAL MAP FOR A PARTICULAR RESIDENTIAL CONDOMINIUM BLOCK. THE TOTAL NUMBER OF RESIDENTIAL CONDOMINIUMS WILL NOT EXCEED 3,000 UNITS. SUBDIVIDER MAY UI TIMATELY SEEK FINAL MAP APPROVAL OF. AND/OR CONSTRUCT, GREATER OR FEWER THAN THE ANTICIPATED NUMBER OF RESIDENTIAL CONDOMINIUM UNITS DESCRIBED HEREIN ON ONE OR MORE RESIDENTIAL CONDOMINIUM BLOCKS, BUT MAY NOT SEEK FINAL MAP APPROVAL AND OR CONSTRUCT GREATER THAN THE TOTAL AUTHORIZED DWELLING UNITS WITHOUT AMENDING THE SUBMISSION OF A NEW SUBDIVISION MAP APPLICATION. FOR EACH FINAL MAP BASED ON THIS VESTING TENTATIVE TRACT MAP, SUBDIVIDER SHALL PROVIDE A NOTATION INDICATING THE ACTUAL NUMBER OF RESIDENTIAL CONDOMINIUM UNITS TO BE APPROVED WITHIN EACH RESIDENTIAL CONDOMINIUM BLOCK PURSUANT TO SUCH FINAL MAP. ANY RESIDUAL RESIDENTIAL CONDOMINIUM UNITS ANTICIPATED FOR A RESIDENTIAL CONDOMINIUM BLOCK BUT NOT SOUGHT FOR APPROVAL ON A FINAL MAP SHALL NOT BE COUNTED AGAINST THE TOTAL AUTHORIZED DWELLING UNITS AND SUCH RESIDENTIAL DWELLING UNITS MAY BE CONSTRUCTED ELSEWHERE WITHIN

AMENDMENT: IN THE CASE WHERE SUBDIVIDER OBTAINS FINAL MAP APPROVAL AUTHORIZING A GIVEN NUMBER OF RESIDENTIAL CONDOMINIUM UNITS, AND SUCH SUBJECT FINAL MAP PURSUANT TO GOVERNMENT CODE \$ 66469 SO AS TO REDUCE THE NUMBER OF RESIDENTIAL CONDOMINIUM UNITS COMMENSURATE WITH THE AS-BUILT DEVELOPMENT. ANY RESIDENTIAL CONDOMINIUM UNIT OR UNITS NOT BUILT AND WHICH ARE THE SUBJECT OF SUCH AN AMENDMENT SHALL NOT BE COUNTED AGAINST THE TOTAL AUTHORIZED DWELLING UNITS AND SUCH ADDITIONAL RESIDENTIAL DWELLING UNITS MAY BE CONSTRUCTED ELSEWHERE WITHIN THE SUBDIVISION.

NON-RESIDENTIAL DEVELOPMENT PURSUANT TO CITY COUNCIL RESOLUTION NO. (BY CITY COUNCIL APPROVAL OF THE VESTING TENTATIVE TRACT MAP). "TOTAL COMMERCIAL CONDOMINIUM UNITS" IN TABLE 1A INCLUDES BOTH RETAIL AND OTHER COMMERCIAL UNITS. THE COMMERCIAL CONDOMINIUM UNITS DESCRIBED HEREIN ARE SEPARATE FROM. AND DO NOT COUNT AGAINST. THE TOTAL AUTHORIZED DWELLING UNITS. THE UNIT COUNTS IDENTIFIED IN TABLE 1A FOR COMMERCIAL CONDOMINIUM UNITS REPRESENT THE MAXIMUM NUMBER OF COMMERCIAL CONDOMINIUM UNITS THAT MAY BE APPROVED ON A FINAL MAP FOR A PARTICULAR DEVELOPMENT BLOCK WITHOUT SUBMISSION OF AN APPLICATION FOR A NEW SUBDIVISION MAP.

11. HOA/CFD/IFD: ONE OR MORE HOMEOWNER ASSOCIATIONS AND/OR COMMUNITY FACILITIES DISTRICTS MAY BE FORMED WITHIN THE SUBDIVISION DEPICTED ON THIS VESTING TENTATIVE TRACT MAP. THIS PROPERTY IS ANTICIPATED TO BE INCLUDED WITHOUT THE BOUNDARIES OF AN INFRASTRUCTURE FINANCING DISTRICT.

BALLPARK DISTRICT PROJECT ('FEIR") WHICH WAS PREPARED PURSUANT TO THE CALIFORNIA ENVIRONMENTAL QUALITY ACT, WAS CERTIFIED AS ADEQUATE, ACCURATE AND OBJECTIVE BY THE OAKLAND CITY COUNCIL ON

202X BY RESOLUTION NO. DEVELOPMENT PROPOSED IN THIS VESTING TENTATIVE TRACT MAP IS CONSISTENT WITH THE PROJECT AND WAS EVALUATED IN THE FEIR.

MAPPING STATEMENT

THIS PROJECT WILL BE A MERGER OF 16 PARCELS INTO 18 DEVELOPMENT PARCELS, 5 OPEN SPACE PARCELS, 4 PUBLIC RIGHT OF WAY PARCELS, 1 CITY-OWNED PARCEL FOR A FIRE STATION, AND 2 REMAINDER PARCELS. A SUMMARY OF THE EXISTING AND PROPOSED PARCELIZATION IS SHOWN ON SHEET 10.


THE PROJECT IS PROPOSING TO VACATE THE EXISTING PUBLIC RIGHT-OF-WAY ON THE SITE FOR A PORTION OF JEFFERSON STREET.

3. THE TOTAL NUMBER OF RESIDENTIAL CONDOMINIUMS WILL NOT EXCEED 3,000 UNITS. THE TOTAL NUMBER OF COMMERCIAL CONDOMINIUMS WILL

4. THE FILING OF EACH PHASED FINAL MAP MAY EXTEND THE TERM OF THIS VESTING TENTATIVE TRACT MAP PURSUANT TO CALIFORNIA GOVERNMENT CODE SECTION 66452.6 IF COSTS FOR OFFSITE PUBLIC IMPROVEMENTS MEET OR EXCEED THE MINIMUM REQUIREMENTS DESCRIBED THEREIN.

PROJECT DESCRIPTION

THE PROJECT IS PROPOSING TO CONSTRUCT A NEW MAJOR LEAGUE BASEBALL (MLB) BALLPARK, AS WELL AS RESIDENTAL AND COMMERICAL (MIXED-USE) DEVELOPMENT, CREATING A NEW OAKLAND WATERFRONT BALLPARK DISTRICT. THE PROJECT SITE PROPOSED FOR DEVELOPMENT INCLUDES THE CHARLES P. HOWARD TERMINAL LOCATED AT THE PORT OF OAKLAND, AND ADJACENT PROPERTIES. THE PROJECT SITE IS LOCATED ON THE OAKLAND WATERFRONT, NORTH OF AND ACROSS THE OAKLAND-ALAMEDA ESTUARY FROM THE CITY OF ALAMEDA; JUST WEST OF THE SAN FRANCISCO BAY FERRY'S OAKLAND TERMINAL AND JACK LONDON SQUARE: AND IMMEDIATELY SOUTH OF THE UNION PACIFIC RAILROAD CORRIDOR ALONG EMBARCADERO WEST. THE PROJECT SITE MEASURES APPROXIMATELY 55.7 ACRES.

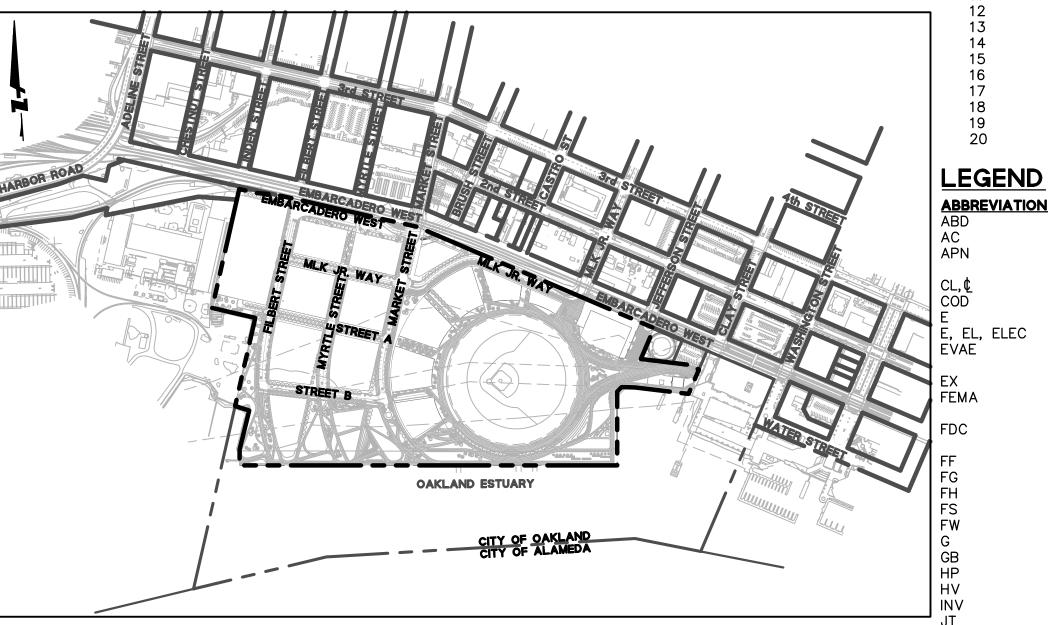

LOCATION MAP 1"=500'

VACATION OF EXISTING ONSITE EASEMENTS IS ALSO PROPOSED.

NOT EXCEED 215 UNITS.

San Pablo RICHMOND - PROJECT VICINITY MAP

PROJECT DATA

APPLICANT: THE OAKLAND ATHLETICS 7000 COLISEUM WAY OAKLAND, CA 94621 PHONE: (510) 638-4900

THE CITY OF OAKLAND, THROUGH THE PORT OF OAKLAND 530 WATER STREET OAKLAND, CA 94607 TEL: (510) 638-4900

THROUGH DYNERGY 6555 SIERRA DRIVE IRVING, TX 75039 TEL: (214) 875-8004

CIVIL ENGINEER: BKF ENGINEERS 255 SHORELINE DRIVE, SUITE 200 REDWOOD CITY, CA 94065 TEL: (650) 482-6300

CONTACT: SIMON NORTH

TEL: (925) 944-5411

COASTAL ENGINEER: MOFFATT AND NICHOL ENGINEERS 2185 N. CALIFORNIA BLVD, SUITE 500 WALNUT CREEK, CA 94596

DESIGN CONSULTANT:

SHEET INDEX

DESCRIPTION

TITLE SHEET

SITE PLAN

SITE PLAN

SITE PLAN

SITE PLAN

FIRE ACCESS PLAN

FIRE ACCESS PLAN

GRADING PLAN

GRADING PLAN

SHEET INDEX PLAN

EXISTING CONDITIONS

EXISTING CONDITIONS

EXISTING CONDITIONS

EXISTING CONDITIONS

EXISTING CONDITIONS

EXISTING PARCELIZATION

PROPOSED PARCELIZATION

LANDS SUBJECT TO PUBLIC TRUST

PARCELIZATION DATA TABLES

DESCRIPTION

ABANDONED

NUMBER

CENTERLINE

ELECTRICAL

EXISTING

ASPHALT CONCRETE

ASSESSOR PARCEL

CITY OF OAKLAND

EMERGENCY VEHICLE

FEDERAL EMERGENCY

MANAGEMENT AGENCY

FIRE DEPARTMENT

FINISHED FLOOR

FINISHED GRADE

FIRE HYDRANT

FIRE SERVICE

GRADE BREAK

HIGH VOLTAGE

JOINT TRENCH

LANDSCAPING

NORTH AMERICAN VERTICAL DATUM

NORTH AMERICAN DATUM WV

LOW POINT

MANHOLE

NORTH

MONUMENT

FIRE WATER

HIGH POINT

INVERT

CONNECTION

ACCESS EASEMENT

PARCELIZATION SUMMARY

BJARKE INGELS GROUP 45 MAIN STREET, FLOOR 9 BROOKLYN, NY 11201 TEL: (347) 549-4141

GEOTECHNICAL ENGINEER: ENGEO 1630 SAN PABLO AVE, SUITE 200 OAKLAND, CA 94612

TEL: (510) 451-1255 LANDSCAPE ARCHITECT: JAMES CORNER FIELD OPERATIONS 633 BATTERY STREET, SUITE 118 SAN FRANCISCO, CA 94111

TEL: (415) 943-9197 TRANSPORTATION ENGINEER: FEHR & PEERS

2201 BROADWAY, SUITE 602 OAKLAND, CA 94612 TEL: (510) 834-3200

VESTING TENTATIVE TRACT MAP NO.:

SSMH

ASSESSOR PARCEL NO.:

018-0405-001, 018-0405-002-00, 018-0405-003-01 018-0405-003-02. 018-0405-004, 018-0410-001-04 018-0410-001-05, 018-0410-003, 018-0410-004, 018-0410-005, 018-0410-006-01, 018-0410-006-02, 018-0410-007-00

DESCRIPTION

GRADING PLAN

GRADING PLAN

UTILITY PLAN

UTILITY PLAN

UTILITY PLAN

UTILITY PLAN

(MARKET ST)

STREET SECTIONS

STREET SECTIONS

STREET SECTIONS

PLAN & PROFILE

VARIANTS

<u>ABBREVIATION</u>

OC

INTERSECTION DETAILS

PROJECT ALTERNATIVES AND

MARITIME RESERVATION SCENARIO

DESCRIPTION

ON CENTER

OVERHEAD

EASEMENT

EASEMENT

PROPOSED

SOUTH

PARCEL

PUBLIC ACCESS

PROPERTY LINE

PUBLIC UTILITY

RIM ELEVATION

RIGHT OF WAY

STORM DRAIN

SQUARE FEET

STREETLIGHT STANDPIPE

MANHOLE

TELEPHONE

TYPICAL

WEST

SANITARY SEWER

SANITARY SEWER

DOMESTIC WATER

WATER METER

WATER VALVE

TOP OF CURB

RECLAIMED WATER

STORM DRAIN MANHOLE

STORM DRAIN EASEMENT

POINT OF BEGINNING

NUMBER

BRUSH ST OVERPASS

M.R.S. UTILITY PLAN

FIRE STATION VARIANT

UTILITY PLAN AND PROFILE

UTILITY PLAN AND PROFILE (MLK)

EXISTING ZONING:

IG (GENERAL INDUSTRIAL) M-40 (HEAVY INDUSTRIAL)

EXISTING LAND USE:

COMMERCIAL BUSINESSES, PORT DISTRICT FRONTAGE PARCEL, PORT DISTRICT CONTAINER STORAGE FACILITIES & CITY FIRE DEPARTMENT, CITY OF OAKLAND PARKING LOT, DYNERGY ENERGY PRODUCTION FACILITIES.

PROPOSED ZONING: WATERFRONT BALLPARK ZONING DISTRICT

PROPOSED LAND USE:

BASEBALL STADIUM, MIXED-USE RESIDENTIAL AND COMMERCIAL, HOTEL, OPEN SPACE AND PARK, PUBLIC RIGHT OF WAY.

PROPOSED PROJECT AREA:

UTILITIES:

PACIFIC GAS & ELECTRIC PACIFIC GAS & ELECTRIC COMCAST, AT&T

PUBLIC DEDICATIONS:

(FOR STREET AND UTILITY PURPOSES)

Drawing Number:

of **39**

DATUM SUMMARY


BENCHMARK

PROJECT DATUM: CITY OF OAKLAND BENCHMARK ELEVATION = 3.62' (CITY OF OAKLAND) CITY OF OAKLAND = NAVD88 - 5.77'

ELEVATION = 3.62 FEET (CITY OF OAKLAND DATUM)

1986 EPOCH VALUES OF SAID POINTS PER SAID MAP.

Drawing Number:

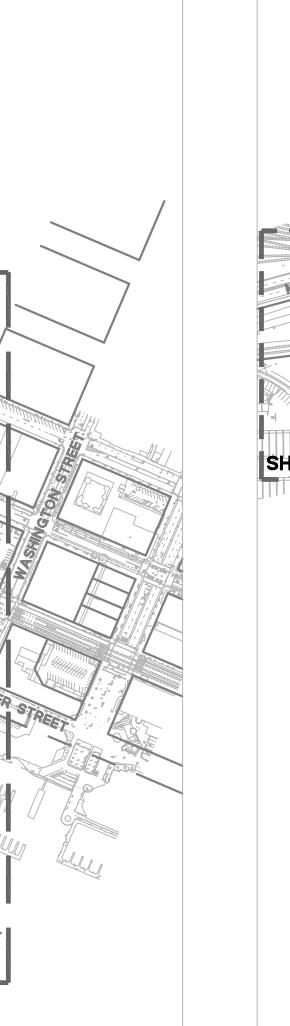

SHEET 6

SHEET 7


SHEET 3 SHEET 8

EXISTING CONDITIONS AND PARCELIZATION SHEETS SCALE 1"=300'

OAKLAND ESTUARY

SHEET 4

SHEET 5

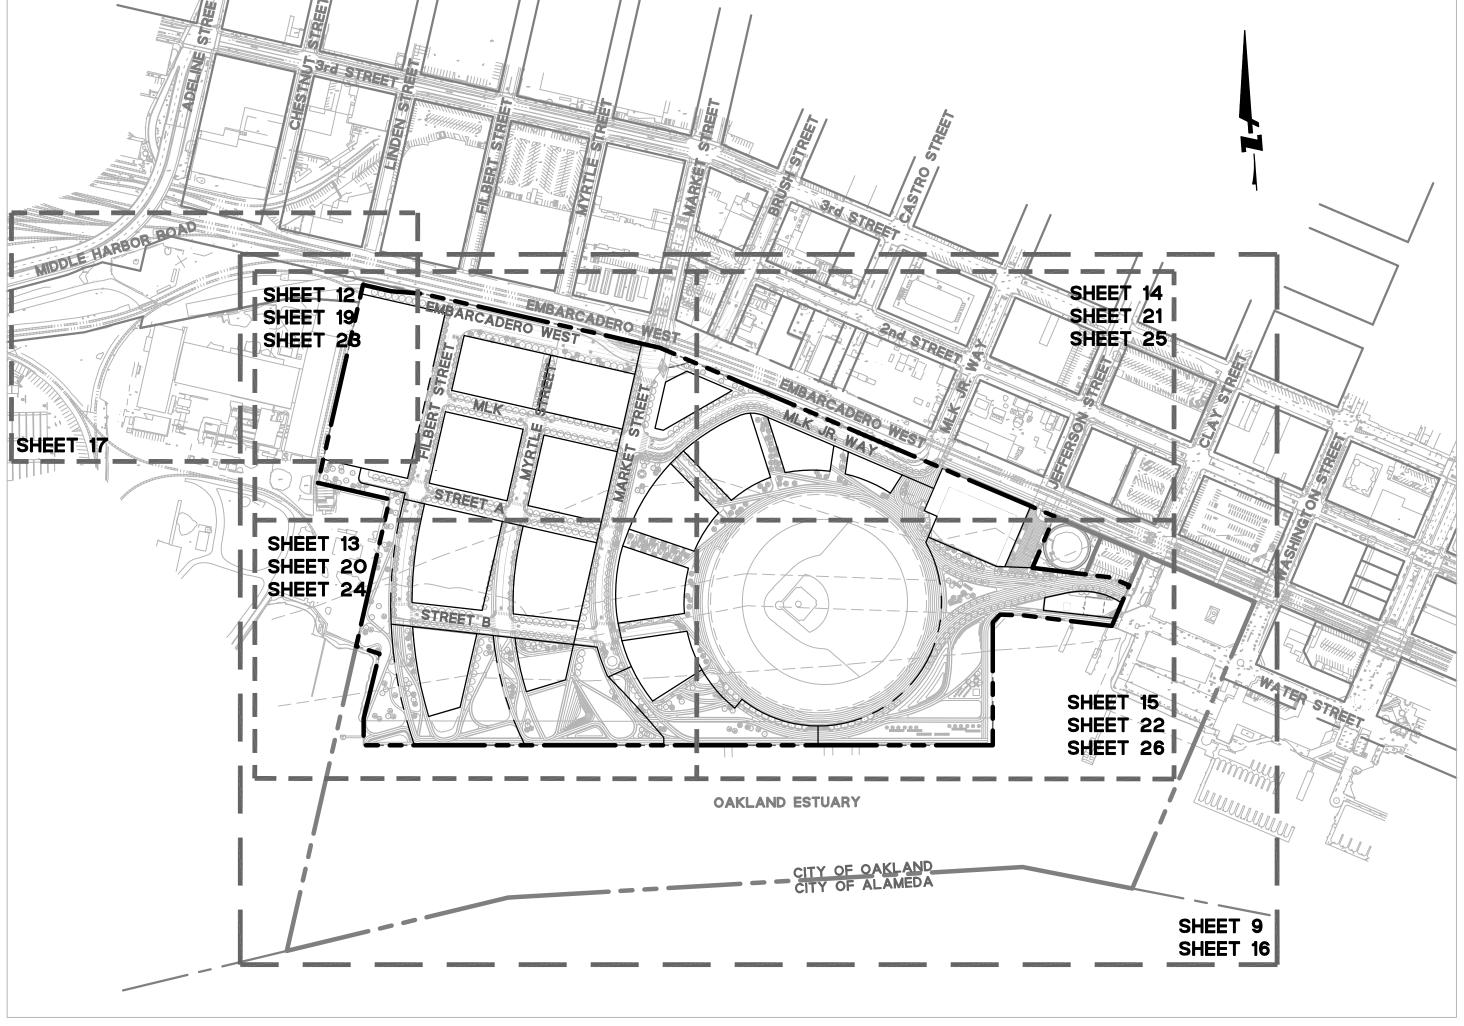

PROPOSED PARCELIZATION, SITE PLAN, GRADING, AND UTILITY SHEETS

SCALE 1"=300'

SHEET INDEX

SHEET NO	<u>DESCRIPTION</u>
1	TITLE SHEET
2	SHEET INDEX PLAN
3-7	EXISTING CONDITIONS
8	EXISTING PARCELIZATION
9	PROPOSED PARCELIZATION
10	PARCELIZATION SUMMARY
11	LANDS SUBJECT TO PUBLIC TRUST
12-15	SITE PLAN
16	FIRE ACCESS PLAN
17	FIRE ACCESS PLAN

17 FIRE ACCESS PLAN
18 PARCELIZATION DATA TABLES
19-22 GRADING PLAN
23-26 UTILITY PLAN

SHEET NO **DESCRIPTION**27-29 UTILITY PLAN AND PROFILE (MARKET ST) 30 UTILITY PLAN AND PROFILE (MLK)
31–33 STREET SECTIONS
34 INTERSECTION DETAILS BRUSH ST OVERPASS — PLAN & PROFILE PROJECT ALTERNATIVES AND VARIANTS MARITIME RESERVATION SCENARIO M.R.S. UTILITY PLAN FIRE STATION VARIANT

NOTES

1. EXISTING CONDITIONS, PROPOSED SITE PLAN, GRADING, AND UTILITY PLANS ARE PRESENTED AT 50 SCALE.

EXISTING LAND TITLE CONDITIONS, EXISTING PARCELIZATION, AND PROPOSED PARCELIZATION PLANS ARE PRESENTED AT 100 SCALE.

DRAWING_NAME: K:\2017\170324_Oakland_Due_Diligence\ENG\03-TM\SHEETS\09-HTTM

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	, o N				
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Drawing Number:

10 of 39

CITY OF OAKLAND BY AND THROUGH THE PORT OF OAKLAND. 6. OPEN SPACE PARCELS FOR WATERFRONT PARK (PARCELS A, B, C, D, E) TO BE OWNED BY THE CITY OF OAKLAND BY AND THROUGH THE PORT OF OAKLAND.

7. PARCEL O IS A REMAINDER PARCEL. PARCEL O IS NOT A DEVELOPMENT PARCEL.

EXISTING PARCELS D, E, AND J. REFER TO EXISTING

2. PARCELS A THROUGH K OWNED BY CITY OF OAKLAND ARE UNDER THE JURISDICTION OF THE BOARD OF PORT

3. THE TOTAL NUMBER OF RESIDENTIAL CONDOMINIUMS SHALL NOT

4. THE TOTAL NUMBER OF COMMERCIAL CONDOMINIUMS SHALL NOT

5. PARCELS 1, 7, 8, 13, 14, 15, 16, 17 ARE TO BE OWNED BY THE

DEVELOPMENT PARCEL.

COMMISSIONERS.

EXCEED 3,000 UNITS.

EXCEED 215 UNITS.

PARCELIZATION SUMMARY TABLE ON SHEET 10, AND EXISTING PARCELIZATION PLAN ON SHEET 8. PARCEL Z IS NOT A

8. PARCEL N IS NOT A PART OF MAP AND SHOWN FOR REFERENCE

9. THE CONFIGURATION OF PARCEL PPP (AND LOCATION OF ASSOCIATED ADJACENT NO-BUILD EASEMENTS) IS PRELIMINARY AND MAY INCREASE OR DECREASE IN SQUARE FOOTAGE SUBJECT TO THE FOLLOWING:

1) THE FINAL EXTENT OF DEMOLITION OF A PORTION OF THE

WESTERN BUILDING WING; AND 2) THE PROPOSED ATHLETICS WAY EASEMENT.

	PCL 17 PCL 17 PCL 15 PCL 15 PCL 16 PCL 16	Tall Policy Poli	PCL 6	5	CL 3 PCL 3	PCL STREET BURGERS BUR	PCL K EXISTING JEFFERSON PUBLIC ROW TO REMAIN	A PART OF MAP
				PCL Z				
CIT	Y OF OAKLAND -		FINAL	PARCELIZATION SCALE: 1"=2"	CONFIGURATION	CITY OF OAKL	AND EDA	
ADOE:			D PARCELIZATION		MAY COMPERCIAL	NOTES: 1. PARCEL Z	IS A REMAINDER PARCEL.	IT IS A PORTION OF
ARCEL	DESCRIPTION	PPROXIMATE	OWNER	MAX RESIDENTIAL	MAX COMMERCIAL		APCELS D E AND I PEE	

		EXISTING PARCELIZ	ZATION SUN	MARY	
KEYNOTE	ASSESSOR'S PARCEL NUMBER	OWNER	APPROXIMATE AREA (ACRES)		APPLICABLE PARCEL NUMBERS
Α	018-0405-001	CITY OF OAKLAND	16.19±	NCS-900257-4	
В	018-0405-004	CITY OF OAKLAND	1.80±	NCS-900257-7	
0	018-0405-002-00	OLTY OF OAKLAND	7.011	NCS-900257-5	PCL 1, 4
С	018-0410-001-05	CITY OF OAKLAND	3.61±	NCS-900257-9	PCL 8, 15
D	018-0405-002-00	CITY OF OAKLAND	11.81±	NCS-900257-5	PCL 2, 3
E	018-0410-003	CITY OF OAKLAND	2.74±	NCS-900257-10	PCL 1, 2
F	018-0410-004	CITY OF OAKLAND	0.23±	NCS-900257-11	
G	018-0410-005	CITY OF OAKLAND	0.57±	NCS-900257-11	
Н	018-0410-006-02	CITY OF OAKLAND	1.58±	NCS-900257-14	
1	018-0410-006-01	CITY OF OAKLAND	3.72±	NCS-900257-13	
J	018-0410-001-05	CITY OF OAKLAND	45.90±	NCS-900257-9	PCL 2, 3, 4, 5, 7, 9, 10, 11, 12, 13, 14, 16
K	MLK JR. WAY	CITY OF OAKLAND	0.90±	NCS-900257-17	
L	018-0410-007-00	DYNERGY OAKLAND LLC	1.82±	NCS-900257-15	
М	JEFFERSON STREET	CITY OF OAKLAND	0.65±	NCS-900257-9	PCL 5
N	018-0410-008	DYNERGY OAKLAND LLC, SEE NOTE 6	_	NCS-900257-16	
0	018-0410-001-04		0.471	NCS-900257-8	
Ο	018-0410-001-05	CITY OF OAKLAND	0.43±	NCS-900257-9	PCL 7, 9
Р	018-0405-003-02	CITY OF OAKLAND	0.06±	NCS-900257-28	PCL 1
Q	018-0405-003-01	CITY OF OAKLAND	0.11±	NCS-900257-6	

EXISTING PARCELIZATION CONFIGURATION

OAKLAND ESTUARY

- EXISTING PORTION
OF JEFFERSON ST
PUBLIC ROW TO

PORTION OF PUBLIC ROW
 TO BE VACATED,
 UNDERLYING FEE OWNER IS
 CITY OF OAKLAND

CITY OF ALAMEDA

THE AREA DESIGNATED BY KEYNOTE C IS REPRESENTED ON MULTIPLE PRELIMINARY TITLE REPORTS. SEE NCS-900257-5 AND NCS 900257-9.


- 2. THE AREA DESIGNATED BY KEYNOTE O IS REPRESENTED ON MULTIPLE PRELIMINARY TITLE REPORTS. SEE NCS-900257-8 AND NCS-900257-9.
- OF OAKLAND LIMIT.


3. THE AREA DESIGNATED BY KEYNOTES D, E, AND J EXTEND SOUTHWARDS, INTO THE ESTUARY, TO THE CITY

- 5. THE PUBLIC RIGHT-OF-WAYS OVER PARCELS E AND K, WHICH COVER THE PORTIONS OF MARKET ST. AND MLK JR. WAY SOUTHERLY OF THE SOUTHERLY LINE OF EMBARCADERO, WERE PREVIOUSLY VACATED BY ORDINANCE NO. 11641 C.M.S., RECORDED NOVEMBER 9, 1993.
- 6. PARCEL N IS NOT A PART OF MAP AND SHOWN FOR REFERENCE ONLY.

PARCEL NAME 1 2 3	DESCRIPTION BALLPARK	APPROXIMATE AREA (ACRES)	SED PARCELIZATIO	MAX RESIDENTIAL	MAY COMPROIN
2	BALLPARK	AMEA MOMES	OWNER	CONDO UNITS	MAX COMMERCIAL CONDO UNITS
	Brief ritit	13.1±	CITY (THROUGH PORT)		
3	MIXED-USE	0.2±	PRIVATE	82	10
	MIXED-USE	0.5±	PRIVATE	252	10
4	MIXED-USE	1.0±	PRIVATE	492	10
5	MIXED-USE	1.0±	PRIVATE	552	10
6	MIXED-USE	1.0±	PRIVATE	492	10
7	MIXED-USE NON-RESIDENTIAL	0.8±	CITY (THROUGH PORT)	0	0
8	MIXED-USE NON-RESIDENTIAL	0.5±	CITY (THROUGH PORT)	0	0
9	MIXED-USE	0.5±	PRIVATE	222	10
10	MIXED-USE	1.1±	PRIVATE	702	10
11	MIXED-USE	1.2±	PRIVATE	752	10
12	MIXED-USE	1.4±	PRIVATE	552	10
13	MIXED-USE NON-RESIDENTIAL	1.1±	CITY (THROUGH PORT)	0	30
14	MIXED-USE NON-RESIDENTIAL	1.3±	CITY (THROUGH PORT)	0	40
15	MIXED-USE NON-RESIDENTIAL	1.7±	CITY (THROUGH PORT)	0	25
16	MIXED-USE NON-RESIDENTIAL	0.9±	CITY (THROUGH PORT)	0	0
17	MIXED-USE NON-RESIDENTIAL	3.3±	CITY (THROUGH PORT)	0	20
PPP	COMMERCIAL/INDUSTRIAL	1.5±	PRIVATE	0	10
Α	OPEN SPACE	4.9±	CITY OF OAKLAND		
В	OPEN SPACE	1.8±	CITY OF OAKLAND		
С	OPEN SPACE	2.3±	CITY OF OAKLAND		
D	OPEN SPACE	1.8±	CITY OF OAKLAND		
E	OPEN SPACE	1.7±	CITY OF OAKLAND		
F	PUBLIC STREET	0.4±	CITY OF OAKLAND		
G	PUBLIC STREET	4.3±	CITY OF OAKLAND		
Н	PUBLIC STREET	4.7±	CITY OF OAKLAND		
J	PUBLIC STREET	2.0±	CITY OF OAKLAND		
К	CITY FIRE STATION	0.3±	CITY OF OAKLAND		
N	NOT A PART OF MAP	_	DYNERGY OAKLAND LLC SEE NOTE 8		_
0	REMAINDER	0.4±	SEE NOTE 7		_
Z	REMAINDER	36.0±	SEE NOTE 1	-	_

4. PARCELS P AND Q ARE EXISTING CITY OF OAKLAND PARCELS TO BE MERGED INTO OVERALL DEVELOPMENT. THESE PORTIONS OF LAND WILL BE DEDICATED AS PART OF THE GREATER EMBARCADERO WEST PUBLIC RIGHT-OF-WAY ON THE NORTH SIDE OF THE PROJECT.

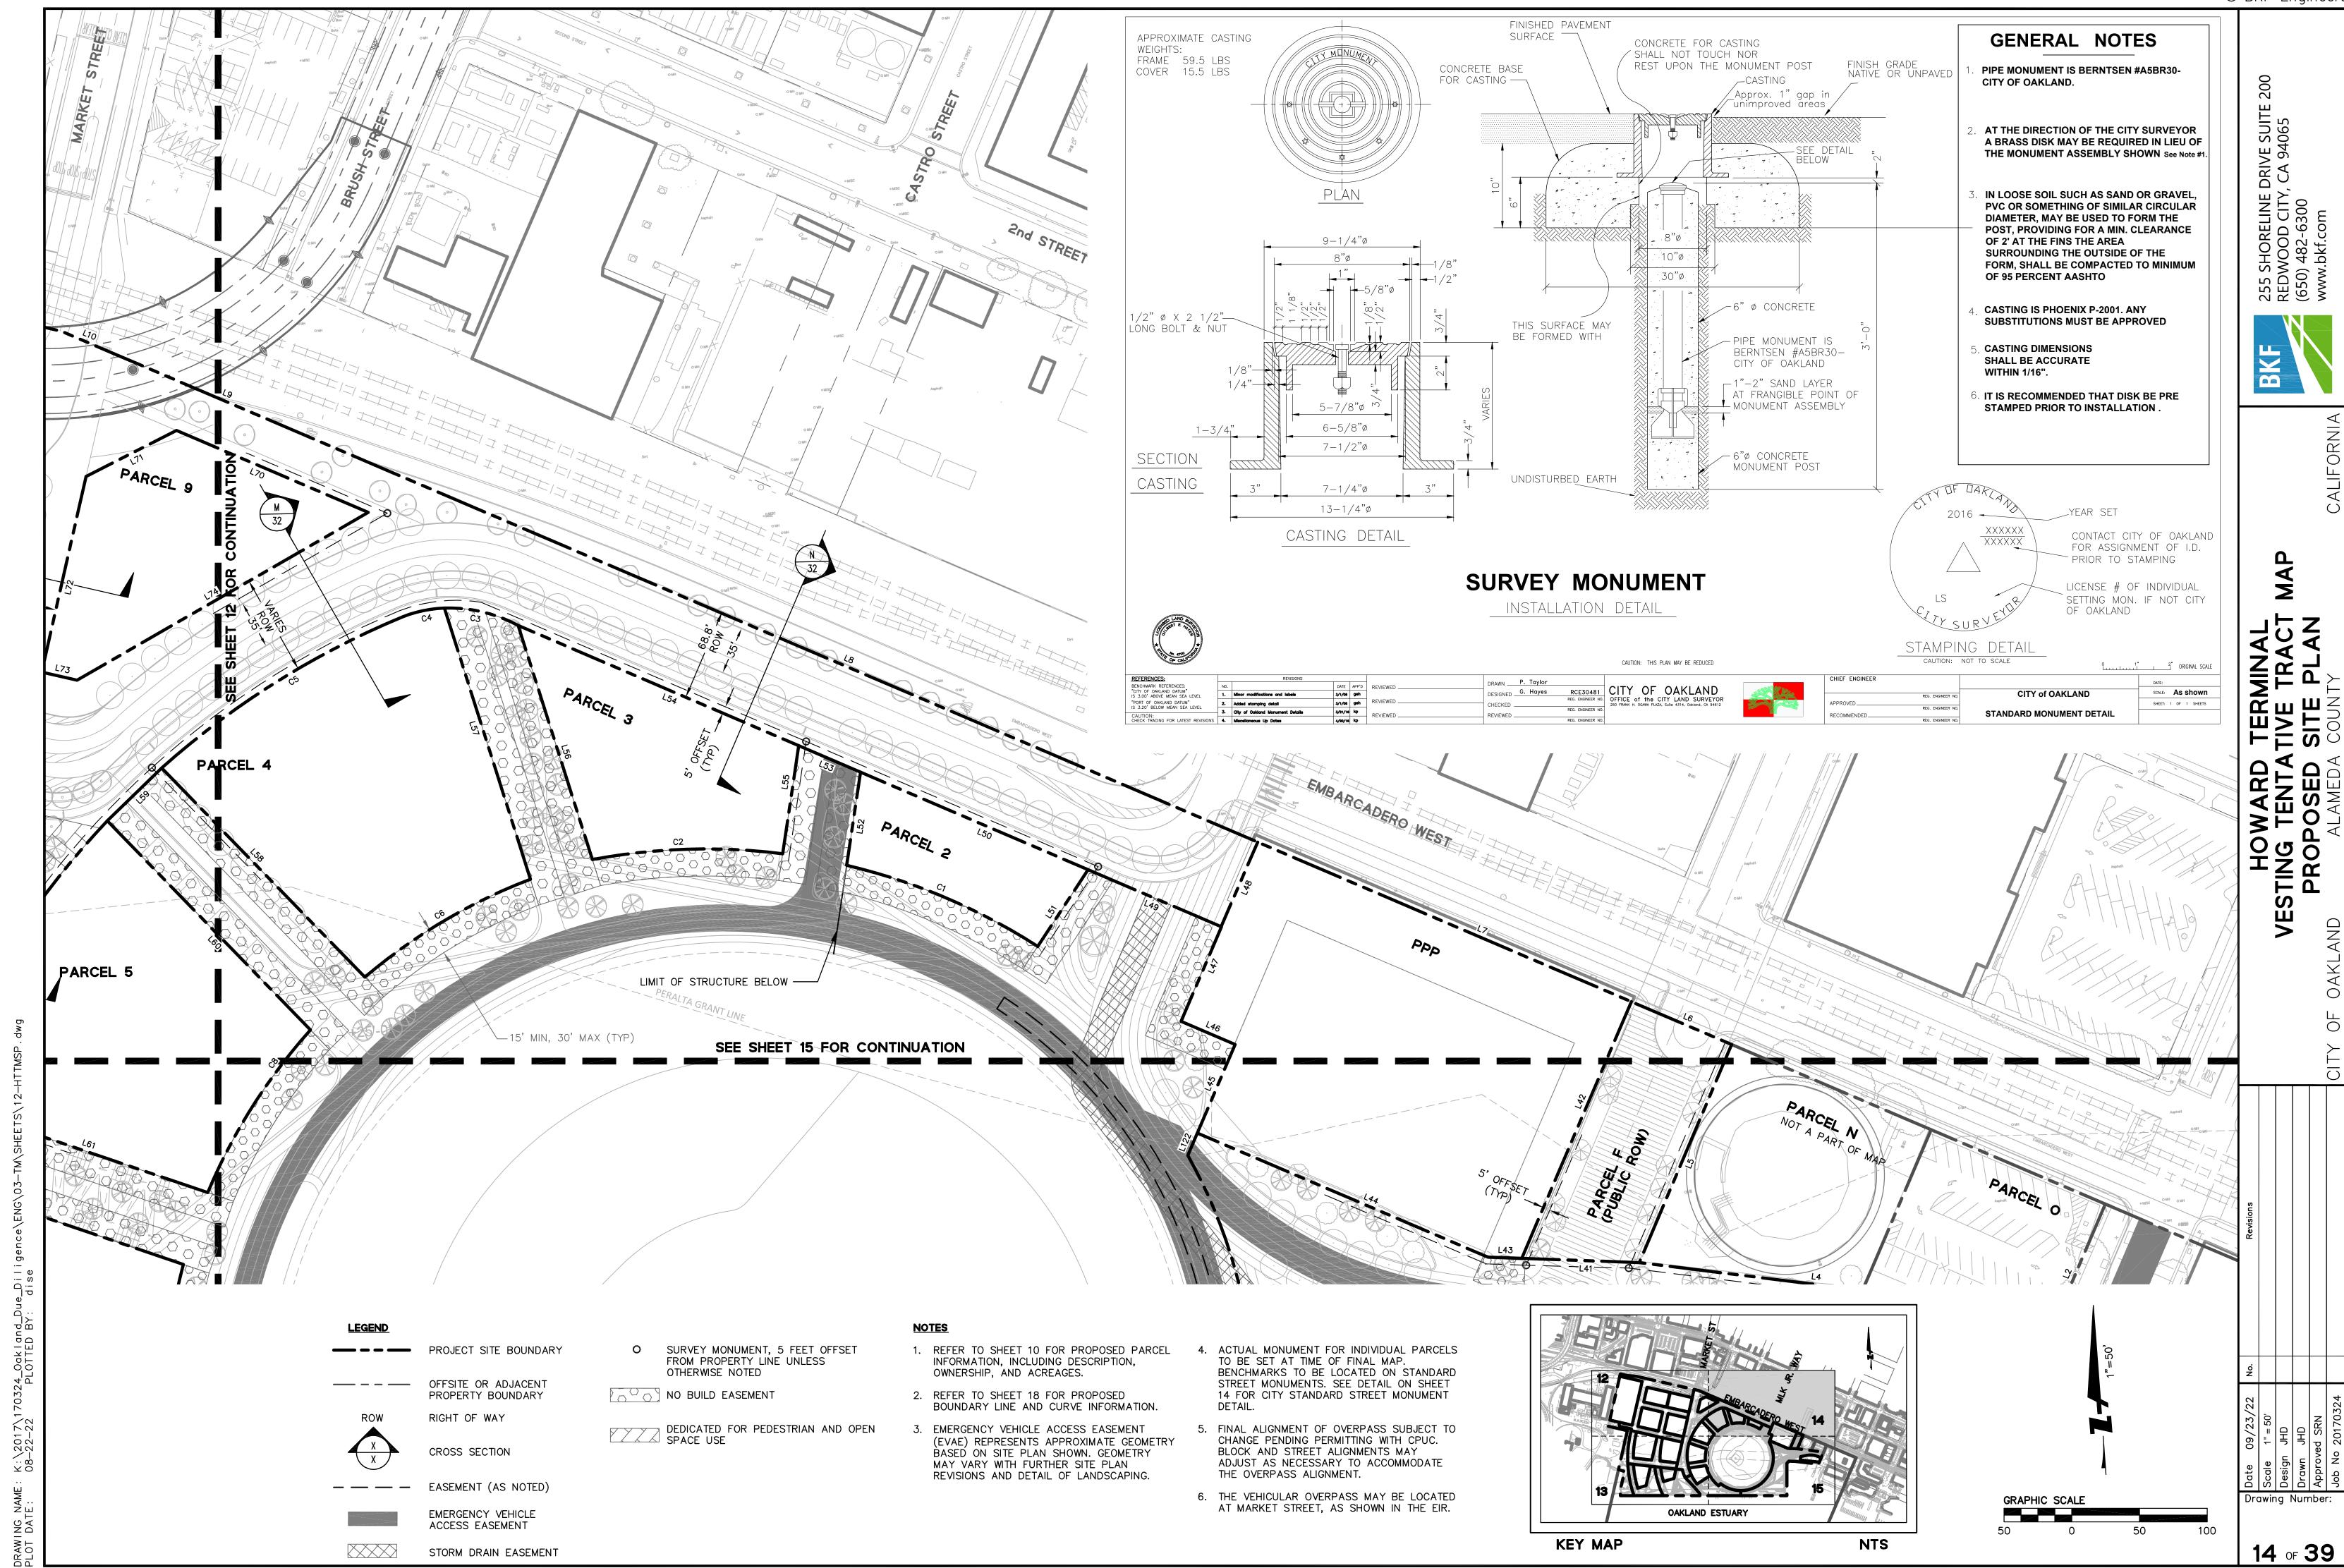

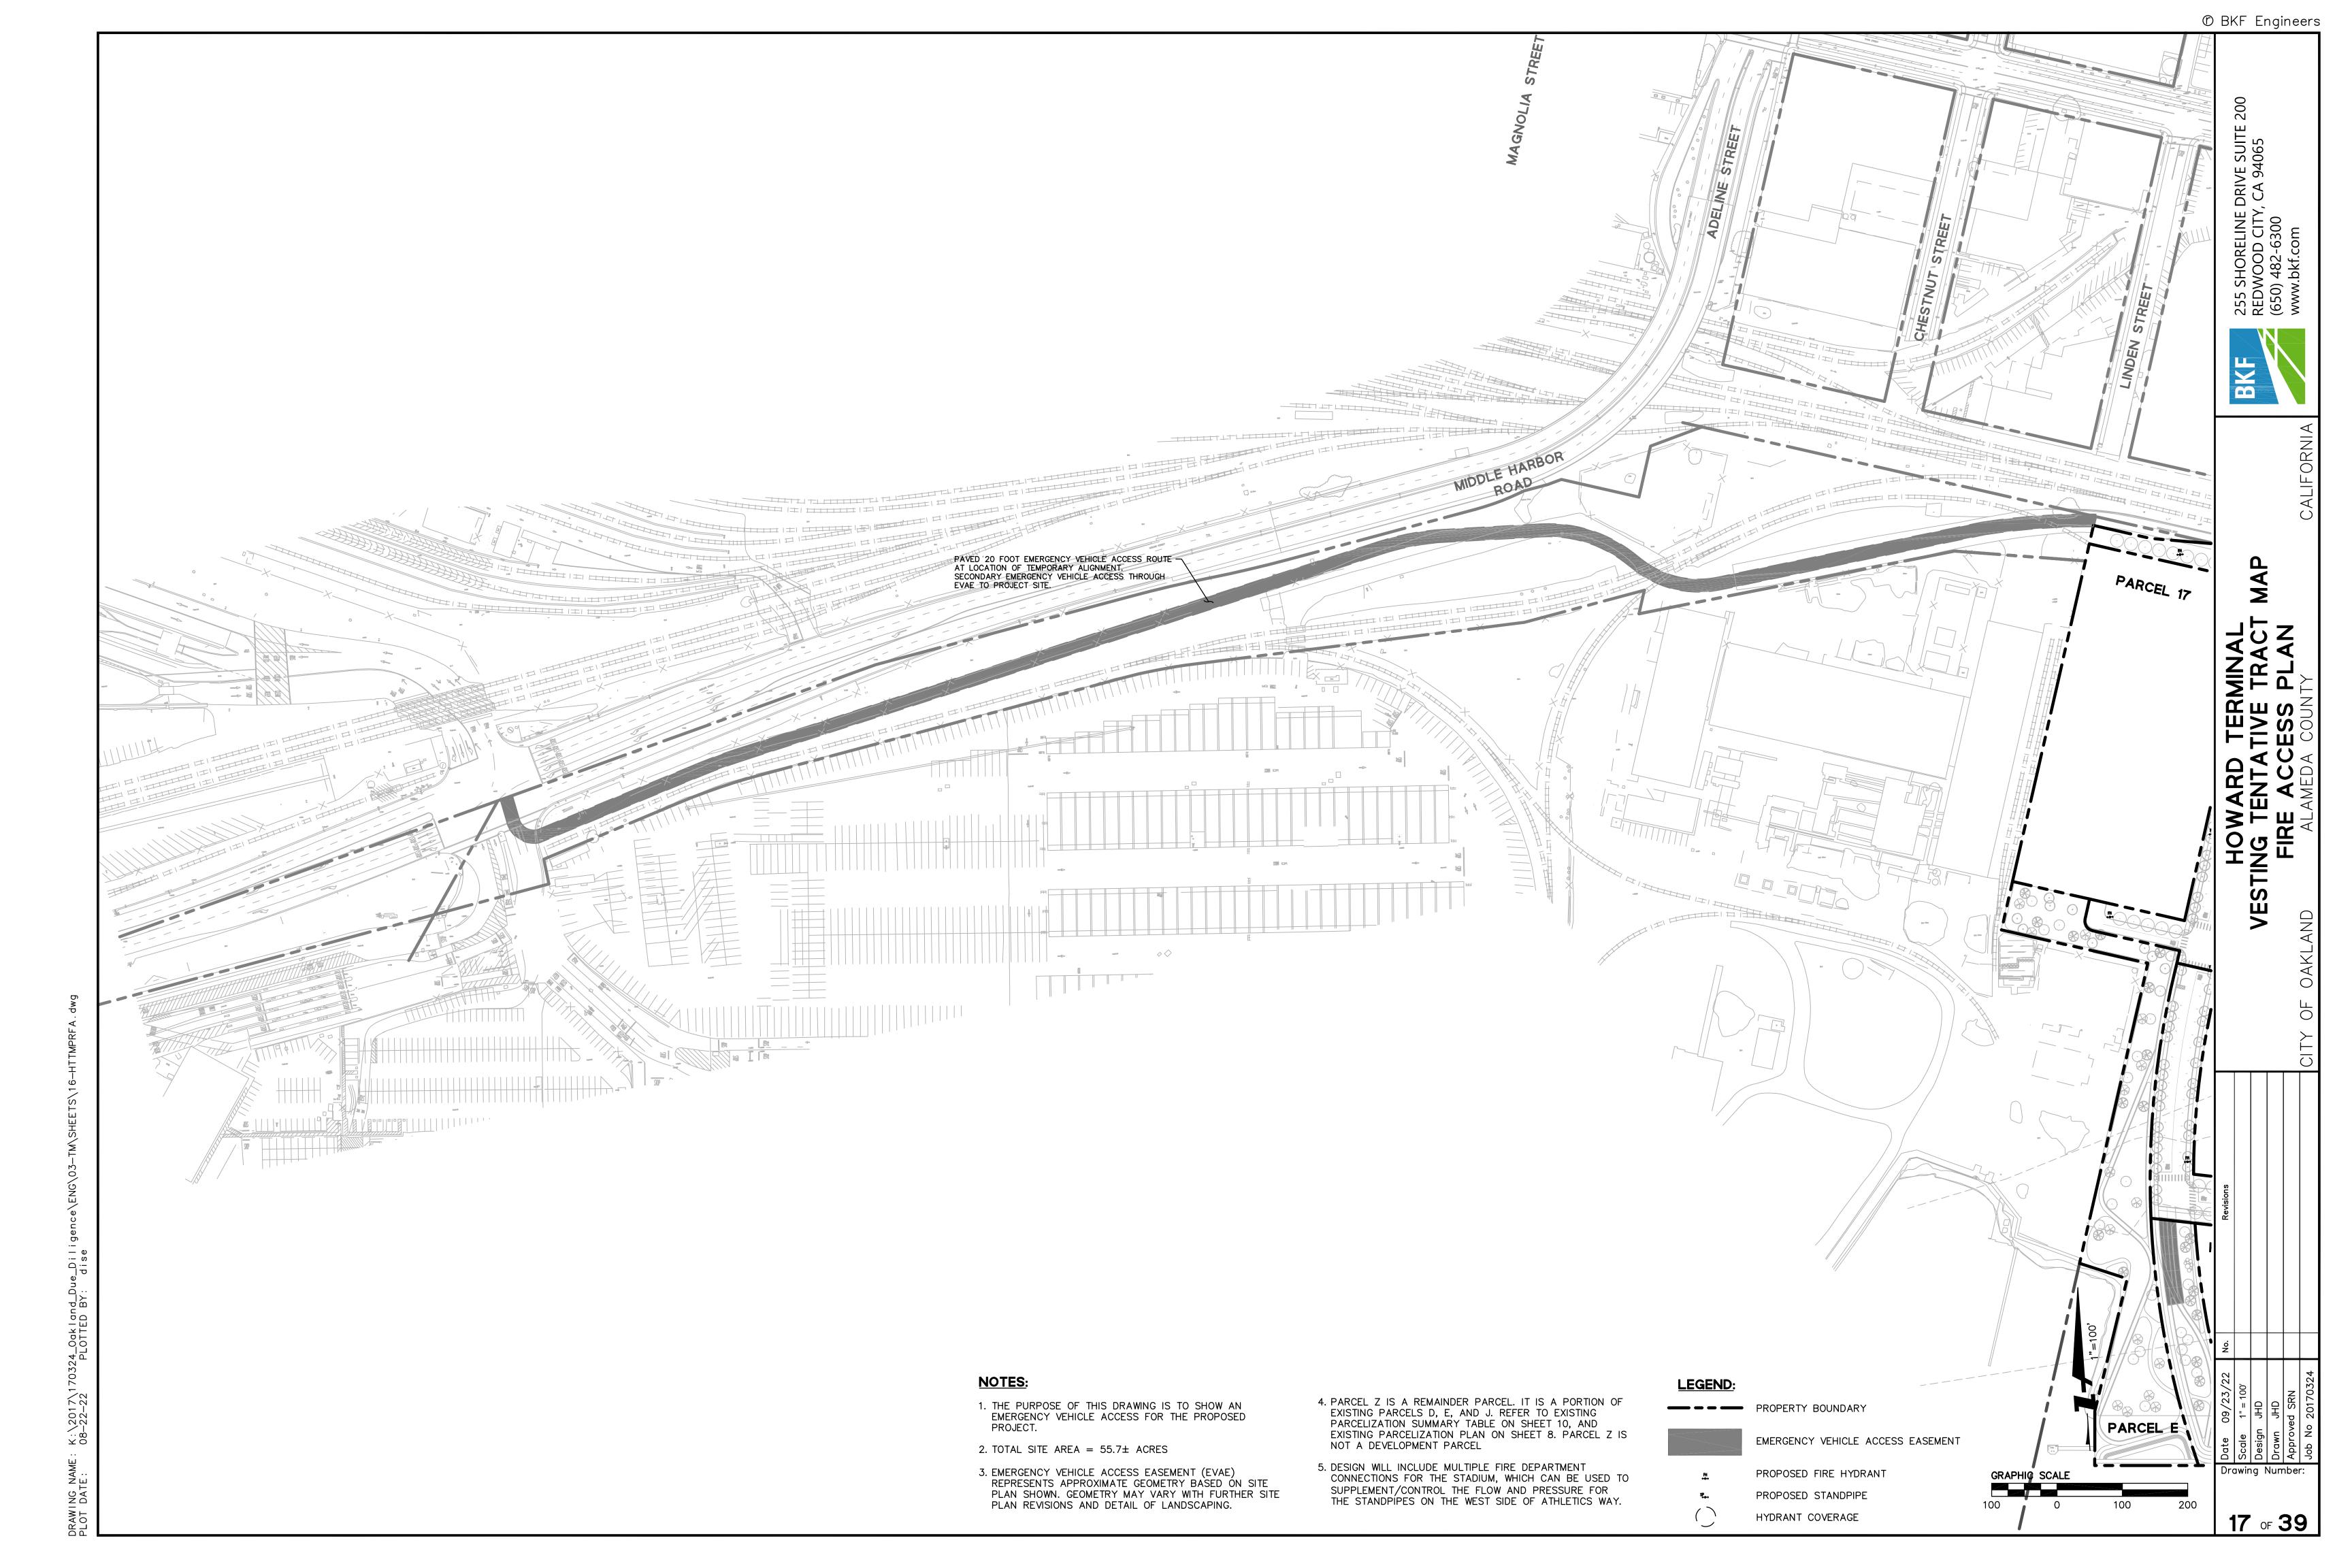

PROPOSED	PARCELIZ.	ATION	LINE	AND	CURVE	TABLES
	(SE	E SHEET	S 12-1	5)		_

	LINE TAB	LINE TABLE							
NO.	BEARING	LENGTH							
L1	N72 * 53'29"W	90.00'							
L2	N80*51'39"W	100.98							
L3	S72*53'29"E	276.11							
L4	S72*53'29"E	182.70'							
L5	S72*53'29"E	247.26							
L6	S72*53'29"E	51.28'							
L7	S62°35'14"E	29.19'							
L8	S62°35'14"E	163.35							
L9	S62*35'14"E	287.21							
L10	S62*35'14"E	400.37							
L11	S62*35'14"E	80.52							
L12	S62*35'14"E	300.01							
L13	S62*35'14"E	80.50'							
L15	S62*35'14"E	139.85							
L16	S62*35'14"E	380.54							
L17	N27 ' 24'50"E	973.93							
L18	N74°40'20"W	348.70							
L19	N89°06'36"W	1496.78							
L20	N89°06'36"W	83.31'							
L21	N89°06'36"W	30.89							

	LINE TAB	
NO.	BEARING	LENGTH
L22	S80°44'03"W	710.76
L23	N17°06'03"E	821.28'
L24	N17°06'03"E	626.19
L25	S72 ' 53'29"E	229.79
L26	N17'06'12"E	579.18
L27	N17 ° 06 ' 12"E	55.73'
L28	N72 ° 53'29"W	100.71
L29	N79 ° 21'29"W	79.91'
L30	N72 ° 53'29"W	196.00'
L31	S17 ° 06'31"W	5.00'
L32	N17'06'31"E	2.25'
L33	N72 ° 53'29"W	6.10'
L34	N17'06'31"E	2.74'
L35	N50'50'16"W	40.36
L36	S17°05'43"W	55.54'
L37	S17 ° 05'43"W	220.50'
L38	S17*05'43"W	312.98'
L39	S17*05'43"W	191.13'
L40	S72 ' 53'38"E	250.04
L41	N17'05'53"E	312.98'

	LINE TAB	LE
NO.	BEARING	LENGTH
L62	S27°24'15"W	78.75'
L63	S62'35'14"E	245.22'
L64	S27°24'46"W	160.00'
L65	S62'35'14"E	186.29
L66	S27°24'46"W	80.00'
L67	S62'35'14"E	370.46
L68	S27°24'59"W	28.99'
L69	S27°24'59"W	197.39'
L70	N62°35'45"W	40.25
L71	N27°24'54"E	346.76
L72	N88 ' 51'58"E	45.79'
L73	N27°24'46"E	340.39
L74	N27°24'46"E	321.81'
L75	S83'41'08"E	321.57
L76	N27°24'46"E	206.05
L78	N27°24'46"E	174.99
L79	N78'39'14"W	166.67
L80	S27°24'46"W	128.86
L81	S27°24'46"W	5.82'
		i

XISTING	PAR	CEL	IZATION L	INE AND	CUI	RVE	TABLES		
312.98'		L61	N62°35'45"W	436.23		L82	S62°35'49"E	139.85'	
250.04'		L60	S27°24'15"W	63.80'		L81	S27°24'46"W	5.82'	
131.13			1102 00 10 11	101.71			327 21 10 11	120.00	l

(SEE SHEET 8)

	LINE TAB	LE		LINE TAB	LE		LINE TAB	LE			LINE TABI	_E		LINE TAB	LE
NO.	BEARING	LENGTH	NO.	BEARING	LENGTH	NO	BEARING	LENGTH	1	NO.	BEARING	LENGTH	NO.	BEARING	LENGTH
L1	S62°35'14"E	380.54	L26	S18°00'14"W	208.65	L51	N37°32'44"E	67.76'		L76	N72°56'26"W	268.50'	L101	S72*54'07"E	270.00'
L2	N27°24'42"E	106.99	L27	S04°25'06"W	83.06'	L52	S12°42'08"W	69.53'		L77	N17°03'34"E	176.00'	L102	S17°06'12"W	530.00'
L3	N62°35'14"W	63.89'	L28	S85°42'50"E	158.95'	L53	S62*30'59"E	49.64'		L78	S72 ° 56'26"E	268.50'	L103	N72°54'07"W	148.98
L4	N78*39'45"W	245.16'	L29	S85°42'50"E	345.30'	L54	N62°30'59"W	225.37		L79	N17°03'34"E	176.00'	L104	N72°54'07"W	121.02'
L5	N27°14'01"E	174.87'	L30	S85°42'50"E	433.63'	L55	N12'42'08"E	80.68'		L80	N72°56'26"W	278.50'	L105	N17°01'46"E	31.31'
L6	N62'35'14"W	80.50'	L31	S85°42'50"E	482.28'	L56	S13"18'51"E	181.37'		L81	S72 ' 56'26"E	278.50'	L106	N72°46'27"W	136.98'
L7	N62'35'14"W	300.01	L32	S85°42'50"E	546.01'	L57	N13°18'51"W	210.08'		L82	S17°03'34"W	176.00'	L107	N79°21'32"W	67.65
L8	N62'35'14"W	696.33'	L33	N04 ' 17'06"E	384.44'	L58	S39*52'39"E	215.32'		L83	N17°03'34"E	72.00'	L108	N79°21'32"W	201.84
L9	N62'35'14"W	221.89'	L34	N48°24'21"E	32.88'	L59	N50°07'21"E	56.00'		L84	S72 * 56'26"E	235.00'	L109	N17°03'34"E	235.72
L10	N62°35'14"W	42.43'	L35	S83*58'37"E	20.50'	L60	S39*52'39"E	215.32'		L85	S17°03'34"W	226.00'	L110	N78°01'00"E	102.60'
L11	N72*53'29"W	57.27	L36	S83°58'40"E	51.39'	L61	N66*59'15"W	215.32'		L86	N72 * 56'26"W	235.00'	L111	N79°16'27"W	51.29'
L12	N72*53'29"W	700.09	L37	S78 ° 51'16"E	279.20'	L62	S24'51'48"W	56.03'		L87	N17°03'34"E	226.00'	L112	N79'16'27"W	68.64
L13	N80*51'39"W	100.98'	L38	N27°24'46"E	25.74'	L63	S66*59'15"E	217.13'		L88	S72*56'26"E	249.00'	L113	S79'19'38"E	183.94
L14	N72 ° 53'29"W	90.00'	L39	N27 ° 24'46"E	52.30'	L64	S85*54'09"W	209.87		L89	S17°03'34"W	229.00'	L114	S17°03'51"W	113.17
L15	S17°06'12"W	28.88'	L40	N27 ° 24'46"E	59.70'	L65	S08*17'51"E	56.15		L90	N72 * 56'26"W	249.00'	L115	S77*19'21"W	127.62
L16	S17°06'12"W	530.00'	L41	N83'37'44"W	86.84'	L66	N85*54'09"E	205.76		L91	N17°03'34"E	229.00'	L116	S17'03'34"W	74.46
L17	S17°06'13"W	76.03'	L42	N27°24'46"E	206.05	L67	S61°49'45"W	182.54		L92	N17°03'34"E	66.00'	L117	N79°22'20"W	73.92'
L18	S72 ' 53'29"E	229.79'	L43	S83°41'08"E	25.09'	L68	N42°42'41"E	35.00'		L93	N72 * 56'26"W	235.00'	L118	S69°40'13"W	78.42
L19	S17 ° 06'32"W	470.96'	L44	S62°35'14"E	233.18'	L69	S04°17'10"W	60.02'		L94	N17°03'34"E	251.52'	L119	S04°17'10"W	21.15'
L20	N17°06'03"E	976.51	L45	S27°24'46"W	71.17'	L70	N62'34'35"W	153.97		L95	S79'19'38"E	206.17'	L120	N10°40'54"E	40.09
L21	S80°44'03"W	710.76	L46	S62*35'14"E	43.42'	L71	S67"19'53"W	74.94'		L96	S72 * 56'26"E	67.00'	L121	N79'19'06"W	225.13'
L22	N89°06'36"W	1580.09'	L47	S27*24'46"W	75.89'	L72	S17°03'34"W	148.16		L97	N72 * 56'26"W	249.00'	L122	S27°24'46"W	17.89
L23	N74*40'20"W	348.70'	L48	S27'38'41"W	68.03'	L73	S72*56'26"E	26.80'		L98	N17°03'34"E	285.21'			
L24	N27*24'50"E	973.93'	L49	N62'30'59"W	106.90'	L74	N64°20'04"E	248.14'		L99	S79"19'38"E	220.58'			
L25	S67°41'36"E	76.61'	L50	N62°30′59″W	182.77'	L75	S17°03'34"W	98.12'		L100	S72*56'26"E	66.53'			

CURVE TABLE								
NO.	RADIUS	DELTA	LENGTH					
C1	452.61'	19 ° 29'13"	153.94'					
C2	452.61'	17 ° 51'59"	141.13'					
С3	109.17	29'41'10"	56.56'					
C4	97.00'	18*44'42"	31.73'					
C5	633.62'	19°04'08"	210.88					
C6	420.00'	19°27'54"	142.69'					
C7	635.00'	22°03'20"	244.44'					
C8	420.00'	19 ° 27'54"	142.69'					
С9	536.03'	26 ° 06'44"	244.29'					
C10	420.00'	19°27'54"	142.69'					
C11	532.73'	9"12'30"	85.62'					
C12	532.73'	13°41'08"	127.25					
C13	420.00'	4*05'37"	30.01'					
C14	420.00'	17*35'33"	128.96'					
C15	385.00'	38'16'33"	257.20'					
C16	385.00'	119 ° 28'17"	802.79					
C17	919.22	15 ° 00'02"	240.66					
C18	1224.49'	12*53'40"	275.57					
C19	15.00'	89'48'13"	23.51'					
C20	1594.25'	0°41'37"	19.30'					

CURVE TABLE

C1 573.00' 20'47'40" 207.96'

DELTA LENGTH

CURVE TABLE

NO. RADIUS DELTA LENGTH

C21 1594.25' 0°24'28" 11.34'

C22 | 1352.27' | 16'13'01" | 382.75'

C23 | 1166.03' | 1°56'28" | 39.50'

C24 | 1334.05' | 14*54'38" | 347.17'

C25 | 1224.49' | 13°23'02" | 286.03'

C26 986.19' 20'50'57" 358.86'

C27 919.22' 10'43'30" 172.07'

C28 919.22' 10'43'30" 172.07'

C29 616.12' 8'51'49" 95.31'

C30 | 2522.04' | 1°06'45" | 48.97'

C32 221.00' 44'49'55" 172.92'

C33 2467.84' 1'46'05" 76.16'

1.57'07" 85.92'


C31 2522.04'

NO. RADIUS

NGTH		NO.	RADIUS	DE
0.00'		C1	452.61'	19"
0.00'		C2	452.61'	17:
8.98'		С3	109.17	29*
1.02'		C4	97.00'	184
1.31'		C5	633.62'	19*(
6.98'		C6	420.00'	19*2
7.65'		C7	635.00'	22'(
1.84'		C8	420.00'	19*2
5.72'		С9	536.03'	26°
2.60'		C10	420.00'	19*2
1.29'		C11	532.73'	91
3.64'		C12	532.73	134
3.94'		C13	420.00'	4°0
3.17'		C14	420.00'	17*3
7.62'		C15	385.00'	38°
1.46'		C16	385.00'	119
3.92'		C17	919.22'	15*(
3.42'		C18	1224.49'	12:
1.15'		C19	15.00'	89*
0.09'		C20	1594.25	0°4
5.13'	'			
7.89'				
	-			

dwb	
-HTTMEXPA.	
HEETS\08	
:NG\03-TM\S	
Iigence∖EN e	
_Due_Di Y: dis	
0324_Oaklan PLOTTED	
K:\2017\17 08-03-22	
WING NAME: T DATE:	

Drawing Number:

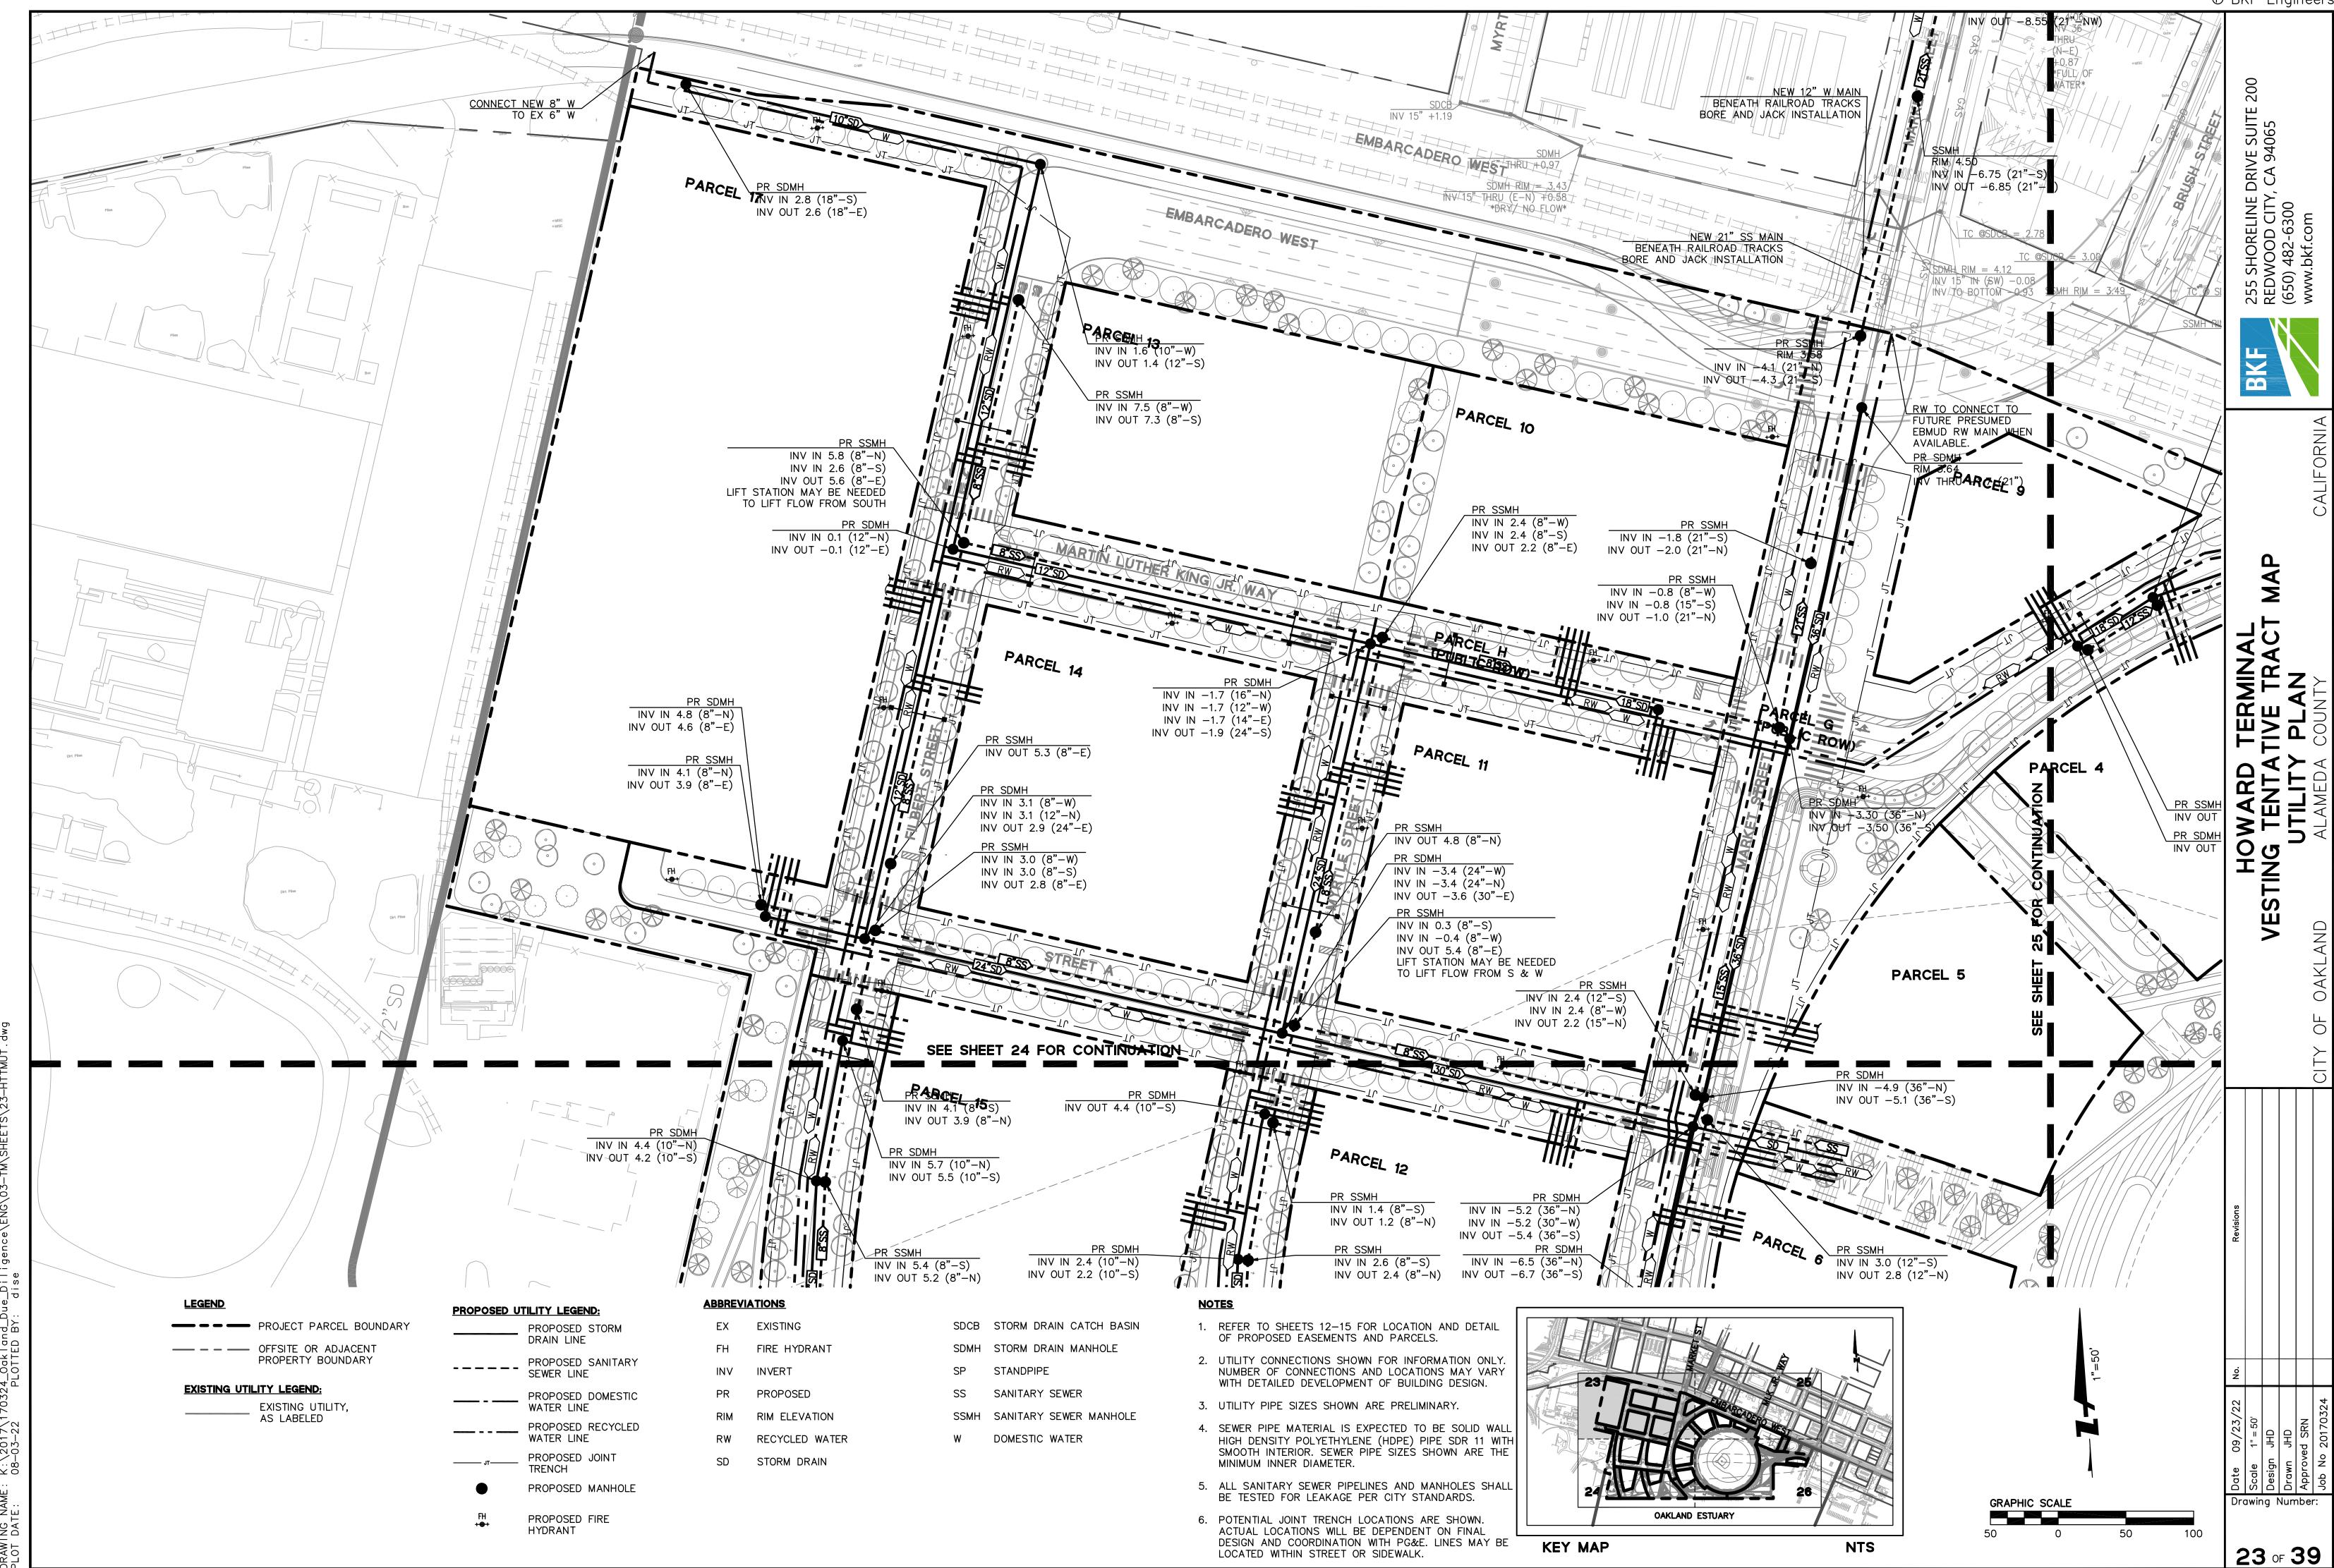

ACTUAL LOCATIONS WILL BE DEPENDENT ON FINAL DESIGN AND COORDINATION WITH PG&E. LINES MAY BE

LOCATED WITHIN STREET OR SIDEWALK.

KEY MAP


NTS


24 of 39


DRAWING NAME: K:\2017\170324_Oakland_Due_Diligence\ENG\03-TM\SHEETS\23-HTTMUT.dwg PLOT DATE: 08-03-22 PLOTTED BY: dise


HYDRANT


GENERAL NOTE:
WHERE LANDSCAPE (L/S) IS ADJACENT TO ROADWAY, LANDSCAPE WIDTH DIMENSION INCLUDES 0.5' FOR THE CURB.

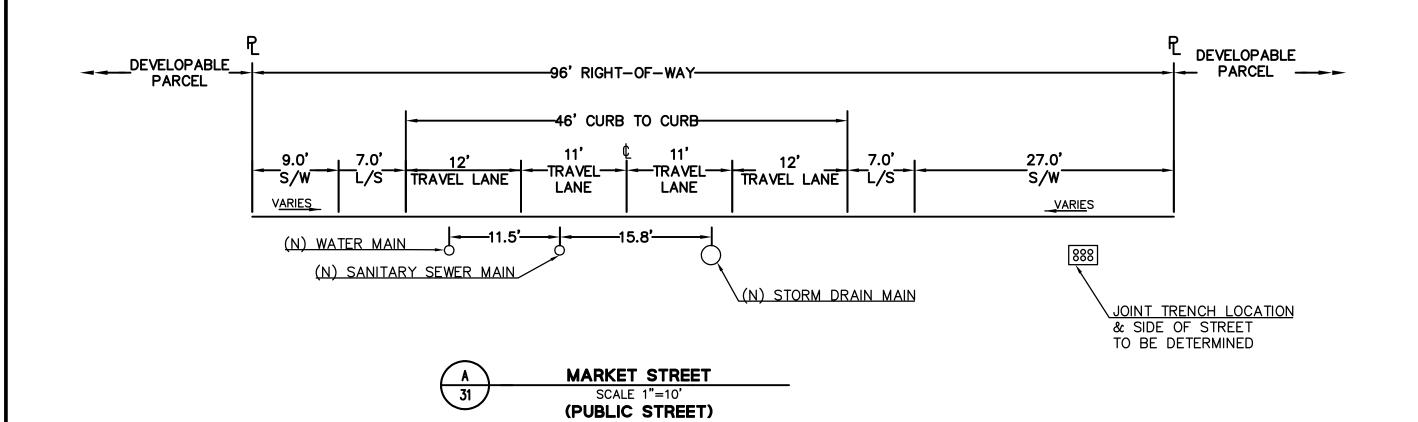

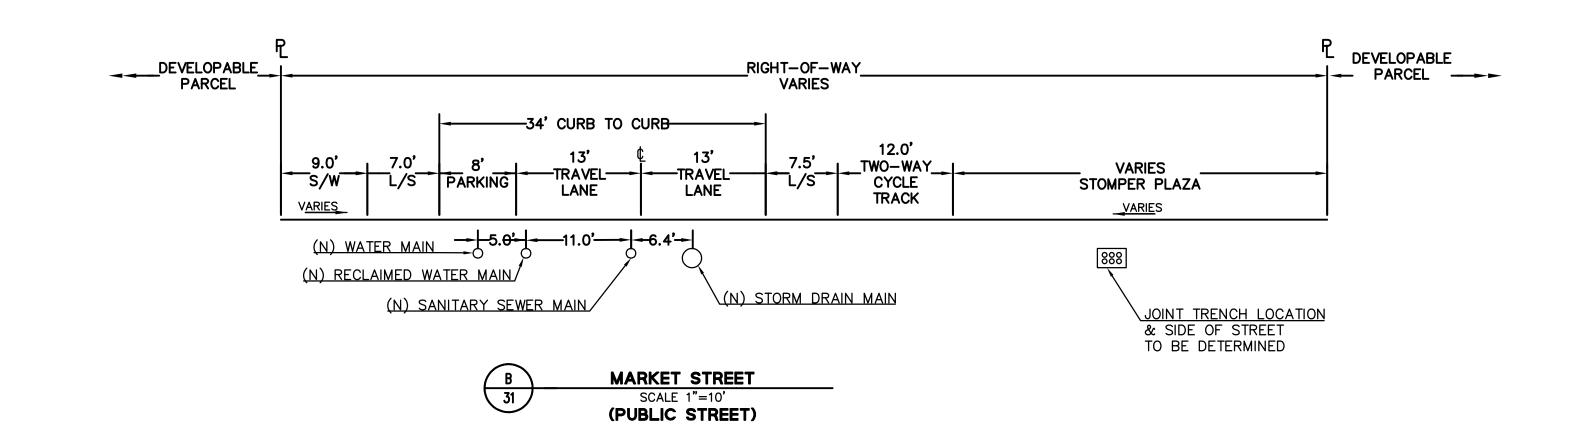

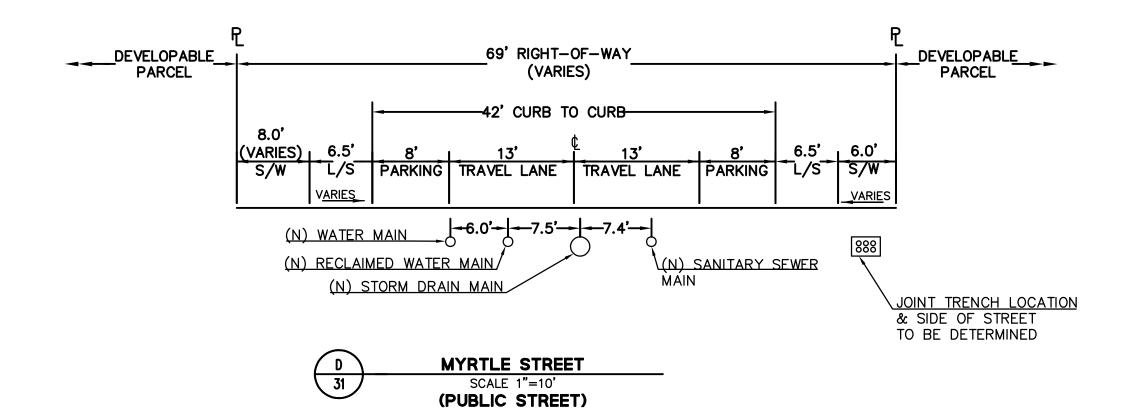

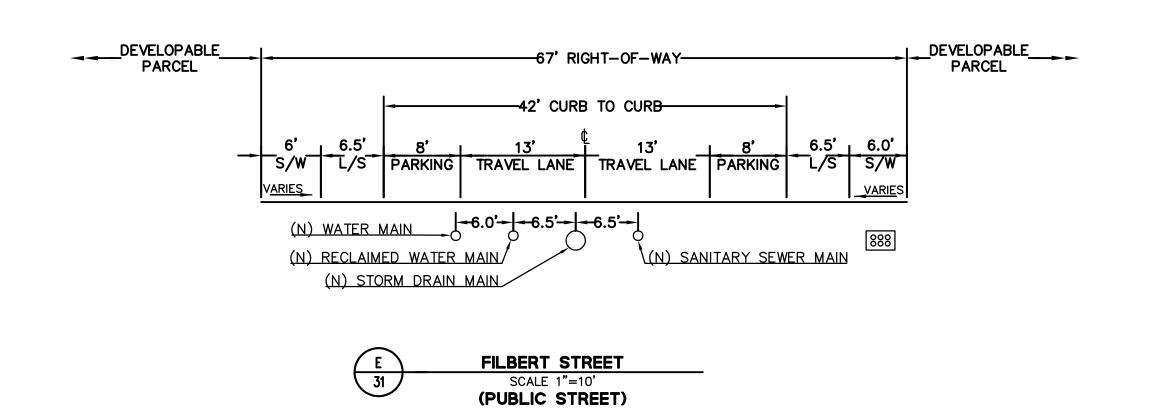

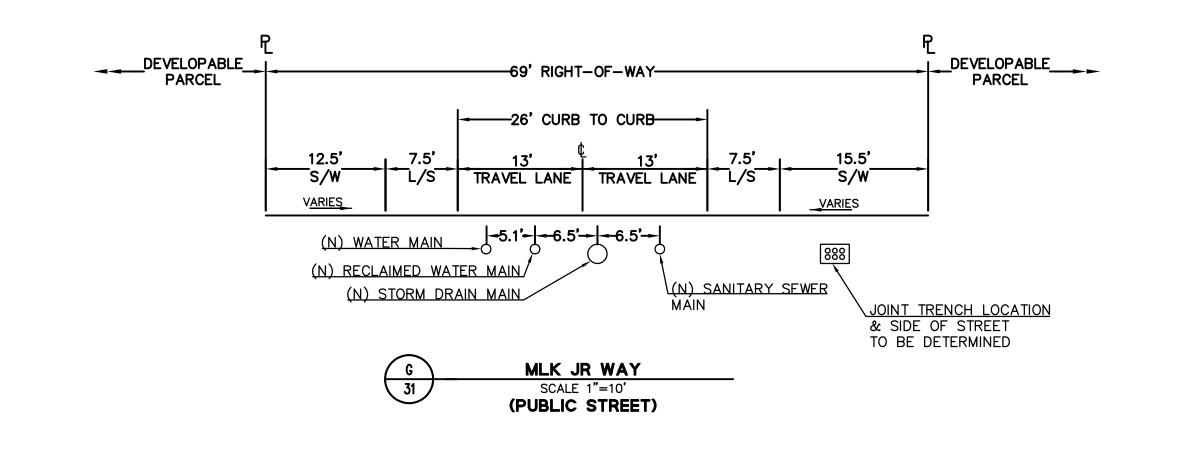

DRAWING NAME: PLOT DATE:

Drawing Number:

255 SHORELINE DRIVE SUITE 2 REDWOOD CITY, CA 94065 (650) 482-6300 www.bkf.com

M X T

HOWARD TERMINAL
VESTING TENTATIVE TRACT MAP
STREET CROSS SECTIONS
ND ALAMEDA COUNTY

31 or 39

33 of 39

37 of 39

GRAPHIC SCALE

A PARCEL 15 A PARCEL 12 PARCEL 6 PARCEL J (PUBLIC ROW) PARCEL 16 PARCEL 7 PARCEL C PARCE PARCEL D PARCEL E OAKLAND ESTUARY

BASELINE SCENARIO PLAN

1" = 100'

VARIANT LANDS AREA 2 MARITIME RESERVATION AREA

(REMAINDER 6.004 AC.) PARCEL B PARCELS 8, 15, 16, J ELIMINATED, AND PARCEL B, C, D, E, 12 ADJUSTED TO ACCOMMODATED MARITIME RESERVATION. _ EDGE OF EXISTING WHARF & _ __<u>OAKLAND PI</u>ER—HEAD <u>LINE</u> _

PARCEL 12

PARCEL 5

OAKLAND ESTUARY


MARITIME RESERVATION SCENARIO PLAN 1" = 100'

OFFSITE OR ADJACENT PROPERTY BOUNDARY


LEGEND: PROJECT BOUNDARY

PARCEL 5

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BASELINE SCENARIO PLAN 1" = 100'

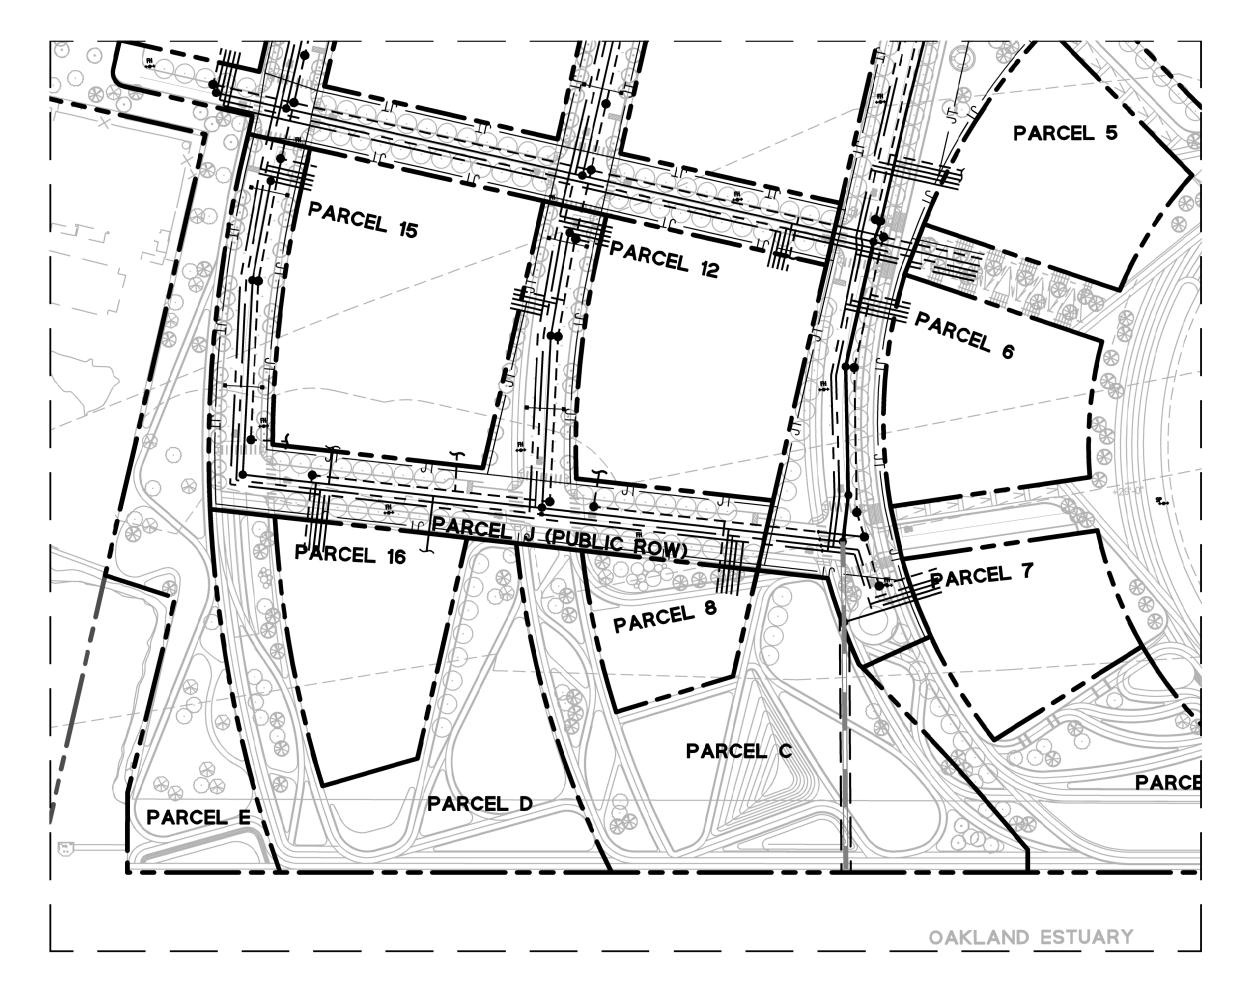

MARITIME RESERVATION SCENARIO PLAN 1" = 100'
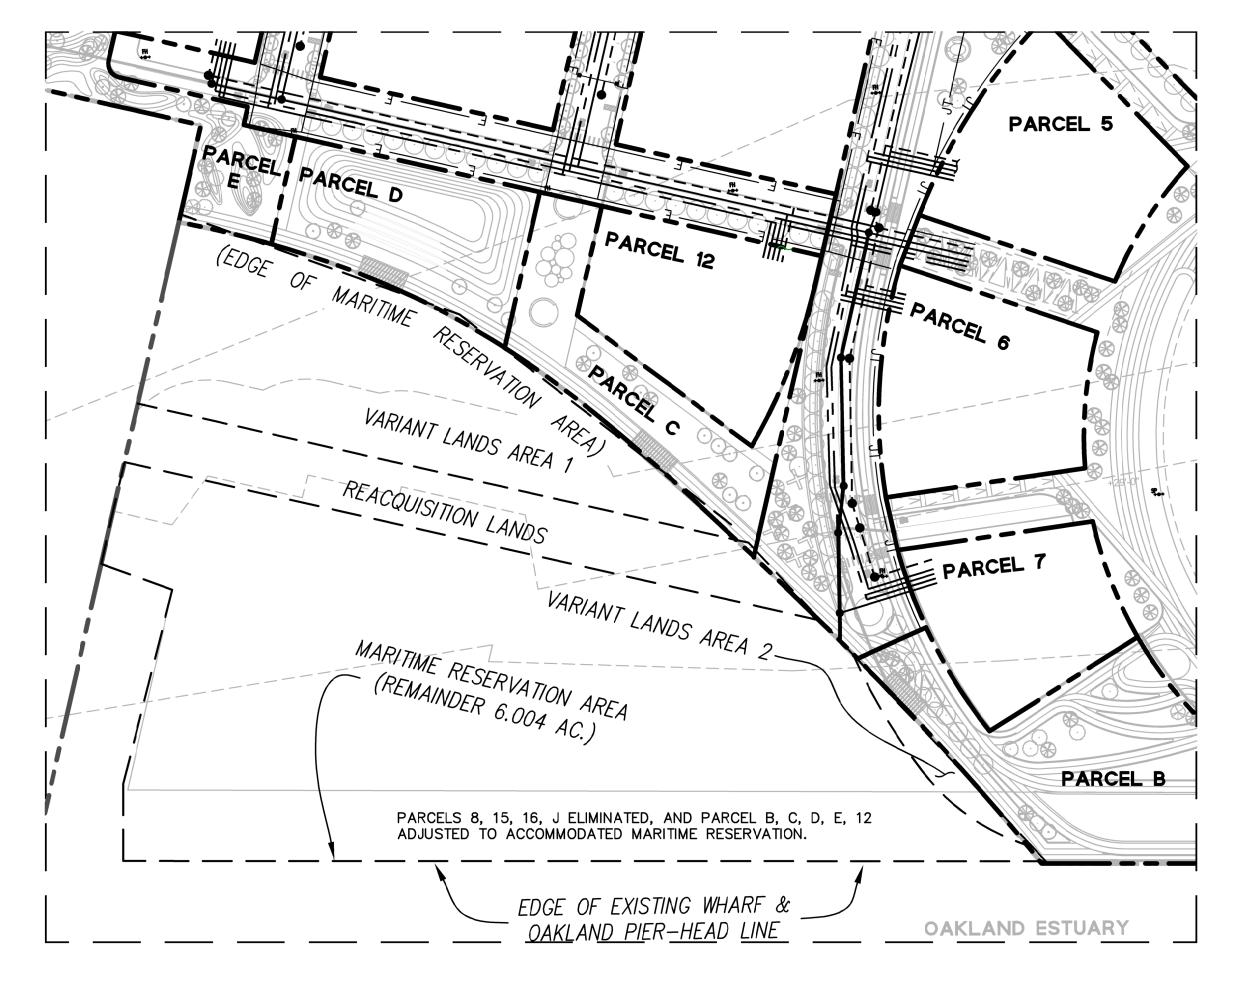
<u>LEGEND</u>		
	PROJECT PARCEL BOUNDARY	
	OFFSITE OR ADJACENT PROPERTY BOUNDARY	
PROPOSED UTILITY LEGEND:		

PROPOSED STORM DRAIN LINE PROPOSED SANITARY SEWER LINE PROPOSED DOMESTIC

WATER LINE PROPOSED RECYCLED WATER LINE PROPOSED JOINT

TRENCH

ABBREVIATIONS

FIRE HYDRANT SDMH STORM DRAIN MANHOLE INV INVERT STANDPIPE PROPOSED SANITARY SEWER SSMH SANITARY SEWER MANHOLE RIM RIM ELEVATION

<u>NOTES</u>

- 2. UTILITY CONNECTIONS SHOWN FOR INFORMATION ONLY. NUMBER OF CONNECTIONS AND LOCATIONS MAY VARY WITH DETAILED DEVELOPMENT OF BUILDING DESIGN.
- 3. SEWER PIPE MATERIAL IS EXPECTED TO BE SOLID WALL HIGH DENSITY POLYETHYLENE (HDPE) PIPE SDR 11 WITH SMOOTH INTERIOR. SEWER PIPE SIZES SHOWN ARE THE MINIMUM INNER DIAMETER.



EX EXISTING


EXISTING UTILITY LEGEND: EXISTING UTILITY, AS LABELED


RECYCLED WATER

STORM DRAIN

SDCB STORM DRAIN CATCH BASIN

DOMESTIC WATER

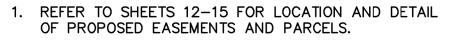

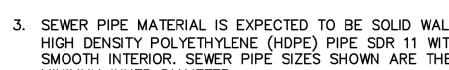



5. POTENTIAL JOINT TRENCH LOCATIONS ARE SHOWN. ACTUAL LOCATIONS WILL BE DEPENDENT ON FINAL DESIGN AND COORDINATION WITH PG&E. LINES MAY BE LOCATED WITHIN STREET OR SIDEWALK.

100

