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| Location: | "6701" / "7001" Oakport Street (See map on reverse) |
| Assessors Parcel Number: | 041-3902-021-00 |
| Proposal: | Proposal to construct a new auto dealership and service center on the existing surface parking lot. |
| Applicant: | Oakland Acura/ Michael Zucker |
| Owner: | City of Oakland |
| Planning Permits Required: | Regular Design Review for new construction, Major Conditional Use Permit to allow a new Automotive Sales Commercial Activity. |
| General Plan: | Regional Commercial |
| Zoning: | D-CO-3 |
| Environmental Determination: | A CEQA Analysis was prepared for this project which concluded that the proposed project satisfies each of the following CEQA provisions: 15332, In fill development projects 15183 - Projects consistent with a community plan, general plan, or zoning; 15164 – Addendum to the 2015 certified Coliseum Area Specific Plan EIR; Each of which provides a separate and independent basis for CEQA compliance. |
| Historic Status: | Not a historic property – vacant parking lots |
| Service Delivery District: | 4 |
| City Council District: | 7 |
| Action to be Taken: | Decision on Application |
| Staff Recommendation: | Approve with the attached conditions. |
| Finality of Decision: | Appealable to City Council within 10 days |
| For Further Information: | Contact case planner Peterson Z. Vollmann at 510-238-6167 or by e-mail at pvollman@oaklandnet.com . |


SUMMARY

Acura of Oakland has filed an application for a Major Conditional Use Permit and Design Review to establish a new Automotive Sales Commercial activity at the subject property under City of Oakland ownership (owned by the former Redevelopment Agency). This would relocate the Oakland based dealership from their current location on 27th Street off of Broadway Auto Row.

PROPERTY DESCRIPTION

The project site is an approximately 3.625-acre property that consists almost entirely of an existing unused asphalt paved parking lot, which was originally intended as an area of expansion for the adjacent Zhong Technologies property. The Project site is flat with a slight slope towards the western boundary. The property has visible frontage onto I-880 and the surrounding area largely consists of a mix of light industrial, office, and auto dealerships.

CITY OF OAKLAND PLANNING COMMISSION

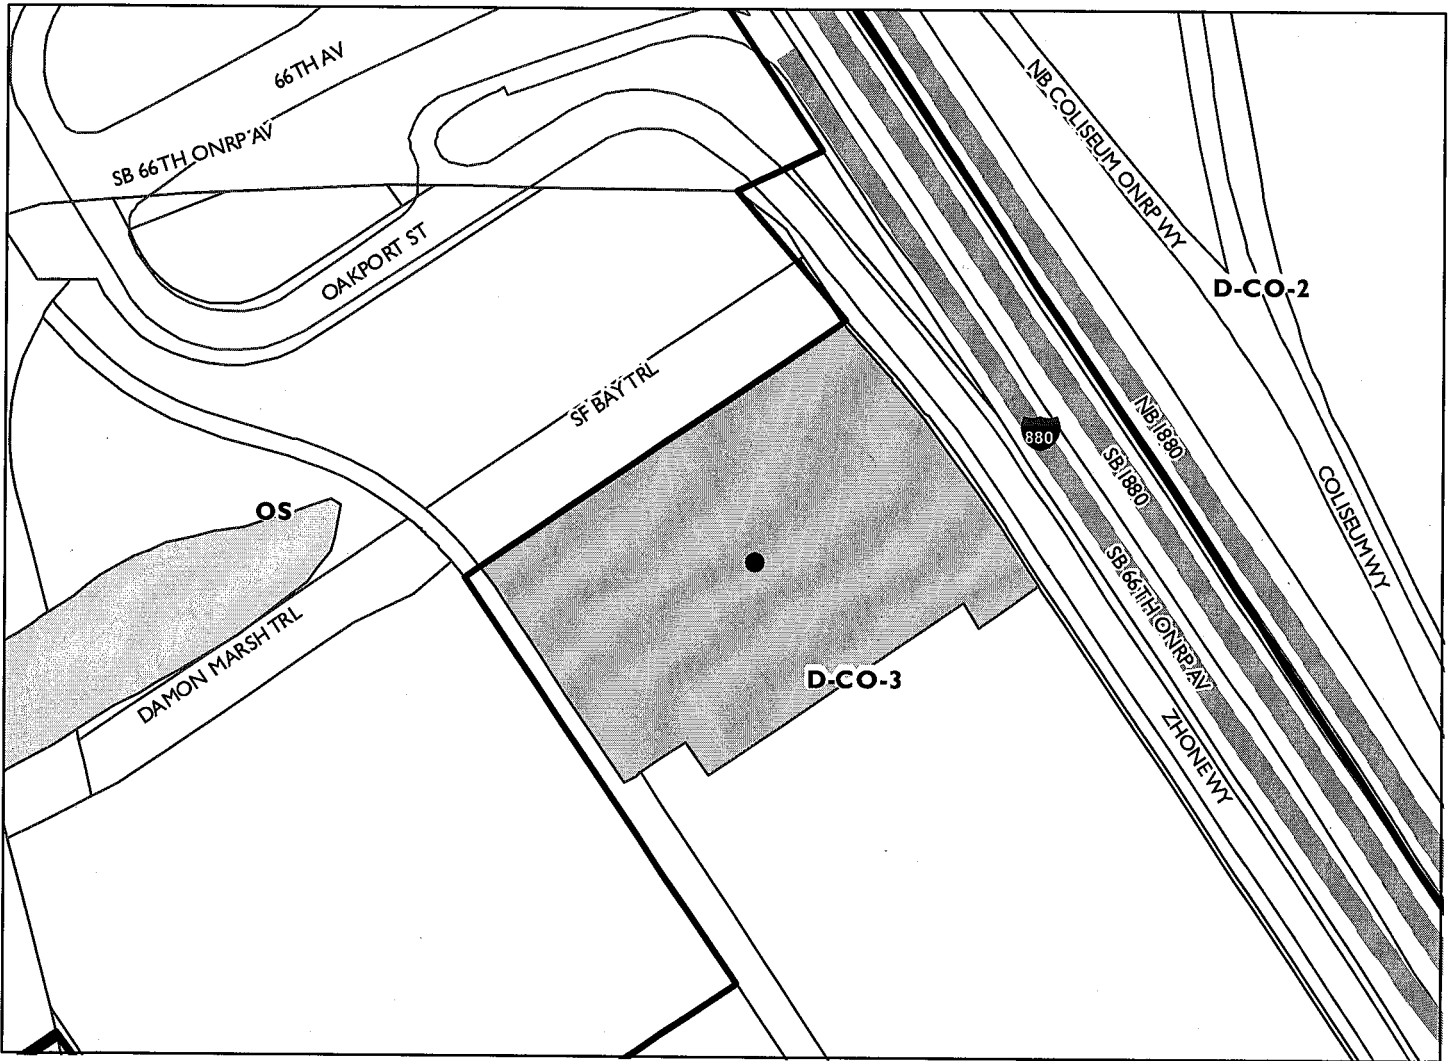

0 125 250 500 750 1,000 Feet



Case File: PLN16144
Applicant: Oakland Acura
Address: "6701" / "7001" Oakport Street
Zone: D-CO-3

PROJECT DESCRIPTION

The proposed Project is relocation of the Oakland Acura automobile dealership from its current location at 277 27th Street to the subject property on Oakport Street. The Project includes clearing the site of all existing paving, landscaped islands and utilities and construction of a new 2-story dealership structure and paving for new surface parking and drive aisles. The building will include areas for sales, presentation and services encompassing a total of approximately 37,500 square feet. The sales and services building will be surrounded by parking for approximately 300 cars, most of which will be new and used car inventory space, as well as employee and customer parking. The Project also includes miscellaneous site improvements such as signage, lighting, site and parking lot landscaping and drainage facilities which includes the creation of on-site bio-swales for treatment of surface runoff.

GENERAL PLAN ANALYSIS

The subject property is located within the Regional Commercial General Plan land use designated area. The intent of the Regional Commercial General Plan classification is to maintain, support, and create areas of the City that serve as region drawing centers of activity. The desired character and uses of the Regional Commercial areas are a mix of commercial, office, entertainment, arts, recreation, sports, and visitor serving activities, residential, mixed use development and other uses of similar character or supportive of regional drawing power.

Relevant General Plan Policies

Policy I/C 1.2 – Retaining Existing Businesses – Existing businesses and jobs within Oakland which are consistent with the long-range objectives of the General Plan should, whenever possible, be retained.

Policy I/C 3.1 – Locating Commercial Business – Commercial uses, which serve long term retail needs of regional consumers and which primarily offer durable goods, should be located in areas adjacent to the I-880 freeway or at locations visible or amendable to high volumes of vehicular traffic, and accessible by multiple modes of transportation.

Policy I/C 3.2 Enhancing Business Districts – Retain and enhance clusters of similar types of commercial enterprises as the nucleus of distinctive business districts, such as the existing new and used automobile sales and related uses through urban design and business retention efforts.

The proposal is consistent with the General Plan in that it will allow an existing Oakland based business to relocate to a different part of the City thereby retaining jobs and local taxes. The new business location is also along the frontage of the I-880 freeway which is an optimal location for auto sales given the visibility and accessibility to the regional population.

Coliseum Area Specific Plan

The Coliseum Area Specific Plan (CASP) provides a flexible, 20- to 25-year framework for guiding land use and infrastructure improvements, coordinating investments, facilitating development, and supporting successful long-term, phased revitalization of the Specific Plan Area. The Specific Plan ensures consistency with the City of Oakland General Plan and provides the basis for the Coliseum Area Specific Plan Environmental Impact Report (EIR) and subsequent entitlements. The Plan Area consists of approximately 800 acres, and is roughly bound by 66th Avenue to the north; San Leandro Street and Hawley Street to the east; Hegenberger Road to the south; and San Leandro Bay and the Oakland

International Airport to the west. It includes the existing Oakland-Alameda County Coliseum and Arena, and the Oakland Airport Business Park.

The site is located within sub-area B of the CASP. Sub-Area B is approximately 122 acres in size and contains the northerly portion of the Oakland Airport Business Park, freeway-oriented retail and office buildings along I-880, and an aging but well-maintained landscaped low-rise light industrial and office park district along Edgewater Drive. The shoreline consists of the MLK Shoreline Park, which features a vegetated pedestrian trail and bike path with views looking across San Leandro Bay. Currently this Sub-Area contains approximately 1.45 million square feet of primarily light industrial, office, and science and technology space, as well as the City of Oakland corporation yard. Sub-Area B includes a portion of a regional shoreline park and 8.6 acres of restored wetland, created as a mitigation project by the Oakland Airport.

Among the Specific Plan goals and policies to the proposed Project are the following:

LU Policy 3-7: Projects within Sub-Areas B and C should be located and designed to take advantage of site assets including visibility from freeways, transit and airport areas, and views of and proximity to the adjacent shoreline and Bay.

LU Policy 3-5: Development projects within Sub-Areas B and C should also emphasize creation of jobs, particularly in the science and technology sector.

While the proposed Project does not carry out the full vision of Sub-Area B within the CASP as a science and technology district that has new established transit connections through the Coliseum site, that vision would need to occur on a much larger development scale including public private partnerships on infrastructure improvements. However, the current proposal does establish a location to retain existing Oakland based jobs as well as allows an auto business to establish good regional visibility by locating directly off of I-880. The proposed auto sales business will help draw people to the area and would not detract from future development scenarios that would fully implement the CASP vision for Sub-Area B.

ZONING ANALYSIS

The subject property is located within the D-CO-3, Coliseum Area Commercial District 3 Zone. The intent of the D-CO-3 zone is to create, maintain and enhance areas suitable for a wide variety of retail, commercial and industrial operations along the Oakport Street and Hegenberger Road corridors and in region-drawing centers of commercial and light industrial activities.

Major Conditional Use permit

The D-CO-3 Zone allows Automobile Sales Commercial activities upon the granting of a Conditional Use permit. Due to the size of the subject property being in excess of one acre, pursuant to Planning Code Section 17.134 a Major Conditional Use permit is required and needs to obtain approval by the Planning Commission.

The proposed project complies with all Planning Code requirements and staff feels that the granting of the Major Conditional Use Permit is appropriate as it will provide a relocation opportunity for an existing Oakland business so that the City may retain the existing jobs and business related taxes created by the operation. In addition, the proposal will create new site improvements that will enhance the visual character of the area as seen from I-880 and promote the area as a Regional destination.

ENVIRONMENTAL DETERMINATION

For purposes of environmental review under the California Environmental Quality Act (CEQA), the project meets the criteria for a Categorical Exemption under Section 15332 of the CEQA Guidelines. The project also meets the Applicable CEQA streamlining and/or tiering code sections are described below.

The *Coliseum Area Specific Plan Environmental Impact Report* (EIR) analyzed the environmental impacts of adoption and implementation of the CASP and, where the level of detail available was sufficient to adequately analyze the potential environmental effects, provided a project-level CEQA review for reasonably foreseeable development. This project-level analysis allows the use of CEQA streamlining and/or tiering provisions for projects developed under the BVDSP.

Applicable CEQA streamlining and/or tiering code sections are described below, each of which, separately and independently, provide a basis for CEQA compliance.

1. Community Plan Exemption. Public Resources Code Section 21083.3 and CEQA Guidelines Section 15183 allow streamlined environmental review for projects that are “consistent with the development density established by existing zoning, community plan or general plan policies for which an EIR was certified, except as might be necessary to examine whether there are project-specific significant effects which are peculiar to the project or its site.” Section 15183(c) specifies that “if an impact is not peculiar to the parcel or to the proposed project, has been addressed as a significant effect in the prior EIR, or can be substantially mitigated by the imposition of uniformly applied development policies or standards..., then an EIR need not be prepared for the project solely on the basis of that impact.”

2. Addendum. Public Resources Code Section 21166 and CEQA Guidelines Section 15164 state that an addendum to a certified EIR is allowed when minor changes or additions are necessary and none of the conditions for preparation of a subsequent EIR or Negative Declaration pursuant to Section 15162 are satisfied.

Note:

A detailed CEQA Analysis was prepared for the project and was provided under separate cover for review and consideration by the Planning Commission, and is available to the public at the Planning Department office at 250 Frank H. Ogawa Plaza, 2nd Floor, Oakland, CA 94612.


CONCLUSION

Staff feels that the approval of the Project is appropriate to allow the re-use of the site as an Automotive Sales Commercial activity as it will provide desirable site improvements to the property, retain local jobs and taxes, as well as further enhance the area as a regional destination.

RECOMMENDATIONS:

1. Affirm staff's environmental determinations.
2. Approve the Major Conditional Use Permit and Design Review subject to the attached findings and conditions.

Prepared by:

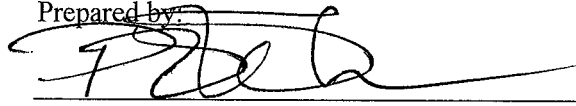


PETERSON Z. VOLLMANN
Planner III

Reviewed by:



SCOTT MILLER
Zoning Manager
Bureau of Planning

Reviewed by:

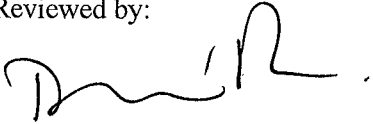

DARIN RANELETTI
Deputy Director
Bureau of Planning

Approved for Forwarding to the
City Planning Commission:



RACHEL FLYNN, Director
Department of Planning and Building

ATTACHMENTS:

- A. Findings for Approval
- B. Conditions of Approval including Standard Conditions of Approval
- C. Plans of the Project Site

ATTACHMENT A

FINDINGS FOR APPROVAL

This proposal meets all the required Conditional Use permit Criteria (Section 17.134.050) and Design Review Criteria (17.136.050B) as set forth below and which are required to approve your application. Required findings are shown in **bold** type; reasons your proposal satisfies them are shown in normal type.

SECTION 17.134.050 –CONDITIONAL USE PERMIT FINDINGS:

- 1. That the location, size, design, and operating characteristics of the proposed development will be compatible with, and will not adversely affect, the livability or appropriate development of abutting properties and the surrounding neighborhood, with consideration to be given to harmony in scale, bulk, coverage, and density; to the availability of civic facilities and utilities; to harmful effect, if any upon desirable neighborhood character; to the generation of traffic and the capacity of surrounding streets; and to any other relevant impact of the development.**

The proposed project would use the site for an automotive sales activity. The site provides excellent visibility to the I-880 freeway, is adjacent to similar activities along Oakport Street with the existing Lexus and Paul Blanco Dealerships on the street, and is an ideal location for an automotive sales activity. The use of the site will not generate traffic that would exceed the capacity of the surrounding streets.

- 2. That the location, design, and site planning of the proposed development will provide a convenient and functional living, working, shopping, or civic environment, and will be as attractive as the nature of the use and its location and setting warrant.**

The proposal will create a functional shopping environment for auto sales. The site is located near existing auto dealerships, and has direct visible frontage on the I-880 freeway across from the Coliseum Complex which is ideal for an activity that focuses on sales to the regional population.

- 3. That the proposed development will enhance the successful operation of the surrounding area in its basic community functions, or will provide an essential service to the community or region.**

The proposal will enhance the operation of the surrounding frontage road area, this section of which already contains other automotive sales activities and with the addition of the proposed business will further enhance the area as a regional destination especially given the high visibility from the I-880 freeway and the close proximity to the Coliseum Complex.

- 4. That the proposal conforms to all applicable design review criteria set forth in the DESIGN REVIEW PROCEDURE of Chapter 17.136 of the Oakland Planning Code.**

See Design Review findings below.

- 5. That the proposal conforms in all significant respects with the Oakland General Plan and with any other applicable plan or development control map which has been adopted by the City Council.**

The subject property is located within the Regional Commercial General Plan land use designated area. The intent of the Regional Commercial General Plan classification is to maintain, support, and create

FINDINGS

areas of the City that serve as region drawing centers of activity. The desired character and uses of the Regional Commercial areas are a mix of commercial, office, entertainment, arts, recreation, sports, and visitor serving activities, residential, mixed use development and other uses of similar character or supportive of regional drawing power.

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SECTION 17.136.050 – NON-RESIDENTIAL DESIGN REVIEW CRITERIA

- A. That the proposal will help achieve or maintain a group of facilities which are well related to one another and which, when taken together, will result in a well-composed design, with consideration given to site, landscape, bulk, height, arrangement, texture, materials, colors, and appurtenances; the relation of these factors to other facilities in the vicinity; and the relation of the proposal to the total setting as seen from key points in the surrounding area.**

The proposal will establish a new auto dealership that will relate well to the other dealerships in the vicinity along Oakport Street. The site will also include new improved landscaping that will help improve the appearance of the area as a frontage road regional shopping area.

- B. That the proposed design will be of a quality and character which harmonizes with, and serves to protect the value of, private and public investments in the area.**

The proposed design will improve the site landscaping and construct a building that will use high quality exterior materials both of which will enhance the operation of the area as a regional destination for purchasing automobiles and will enhance the overall value of properties in the area by creating a regional draw to the area.

- C. That the proposed design conforms in all significant respects with the Oakland General Plan and with any applicable design review guidelines or criteria, district plan, or development control map which have been adopted by the Planning Commission or City Council.**

The Project is consistent with the goals and policies of the LUTE and CASP as indicated in Findings in Sections 17.134.050 above and the City Planning Commission Report, hereby incorporated by reference.

CEQA COMPLIANCE FINDINGS

I. Introduction These findings are made pursuant to the California Environmental Quality Act (Public Resources Code section 21000 et seq.; “CEQA”) and the CEQA Guidelines (Cal. Code Regs. title 14, section 15000 et seq.; “CEQA Guidelines”) by the City Planning Commission in connection with the environmental analysis of the effects of implementation of the Acura Dealership Relocation project, as more fully described elsewhere in this Staff Report and City Of Oakland (“City”)-prepared CEQA Analysis document entitled “Acura Dealership Relocation Project” dated July 15, 2016 (“CEQA Analysis”) (the “Project”). The City is the lead agency for purposes of compliance with the requirements of CEQA. These CEQA findings are attached and incorporated by reference into each and every decision associated with approval of the Project and are based on substantial evidence in the entire administrative record.

II. Adoption of CASP and Certification of CASP EIR: The City finds and determines that (a) the Oakland City Council on March 31, 2015 adopted Resolution No. 85491 C.M.S. which adopted the Coliseum Area Specific Plan (“CASP”), made appropriate CEQA findings, including certification of the CASP Environmental Impact Report (“EIR”); and (b) the CASP satisfies the description of “Community Plan” set out in Public Resources Code section 21083.3(e) and in CEQA Guidelines section 15183 as well the description of “Planning Level Document” set out in Public Resources Code section 21094.5. The City Council, in adopting the CASP following a public hearing, approved as a part thereof Standard Conditions of Approval (“SCAs”) which constitute uniformly applied development policies or standards (together with other City development regulations) and determined that the uniformly applicable development policies or standards, together with the mitigation measures set out in the CASP EIR, would substantially mitigate the impacts of the CASP and future projects thereunder.

III. CEQA Analysis Document: The CEQA Analysis and all of its findings, determinations and information is hereby incorporated by reference as if fully set forth herein. The CEQA Analysis concluded that the Project satisfies each of the following CEQA provisions, qualifying the Project for a CEQA statutory exemption, a CEQA categorical exemption, and that the CEQA Analysis constitutes an addendum to the CASP EIR, as summarized below and provides substantial evidence to support the following findings.

The City hereby finds that, as set forth below and in the CEQA Analysis, the Project is exempt from any additional CEQA Analysis under the “Community Plan Exemption” of Public Resources Code section 21083.3 (CEQA Guidelines §15183) and/or the “Infill Exemption” under Public Resources section 21084 (CEQA Guidelines §15332) and that the CEQA Analysis also constitutes an Addendum to the CASP EIR pursuant to Public Resources Code section 21166 (CEQA Guidelines §15162) and that such Addendum determines that none of the three events requiring subsequent or supplemental environmental analysis as stipulated in Public Resources Code section 21166 have occurred, thus no additional environmental analysis beyond the CASP EIR and the CEQA Analysis is necessary. The specific statutory exemptions and the status of the CEQA Analysis as an Addendum are discussed below in more detail.

FINDINGS

A. Community Plan Exemption; Public Resources Code Section 21083.3 (CEQA Guidelines §15183): The City finds and determines that, for the reasons set out below and in the CEQA Analysis, the Community Plan Exemption applies to the Project. Therefore, no further environmental analysis is required because all of the Project's effects on the environment were adequately analyzed and mitigation measures provided in the CASP EIR; there are no significant effects on the environment which are peculiar to the Project or to the parcel upon which it is located not addressed and mitigated in the CASP EIR; and there is no new information showing that any of the effects shall be more significant than described in the CASP EIR.

As set out in detail in the CEQA Analysis, the City finds that, pursuant to CEQA Guidelines section 15183 and Public Resources Code section 21083.3, the Project is consistent with the development density established by the CASP and analyzed in the CASP EIR and that there are no environmental effects of the Project peculiar to the Project or the Project Site which were not analyzed as significant effects in the LMSAP EIR: nor are there potentially significant off-site impacts and cumulative impacts not discussed in the LMSAP EIR; nor are any of the previously identified significant effects which, as a result of substantial information not known at the time of certification of the CASP EIR, are now determined to present a more severe adverse impact than discussed in the CASP EIR. As such, no further analysis of the environmental effects of the Project is required.

B. Infill Exemption; Public Resources Code Section 21084 (CEQA Guidelines §15332): The City finds and determines that, for the reasons set forth below and in the CEQA Analysis, an Infill Exemption applies to the Project and no further environmental analysis is required since the A) The proposed project is consistent with the General Plan and Zoning Regulations, B) is a site less than 5 acres within City limits and surrounded by urban uses, C) is not within an endangered species habitat, D) A Traffic Impact Analysis was conducted and concluded that the proposed project would not decrease the LOS of any nearby intersections and no mitigation measures were required. With implementation of standard conditions of approval related to construction management and noise reduction measures, the project would not result in any significant impacts on traffic, noise, air quality, or water quality., E) and the site will be adequately served by all required public utilities; Therefore, the proposed project would not have a significant impact on the environment and is exempt from Environmental Review.

C. CEQA Analysis Constitutes an Addendum; Public Resources Code Section 21166 (CEQA Guidelines §15164): The City finds and determines that the CEQA Analysis constitutes an Addendum to the CASP EIR and that no additional environmental analysis of the Project beyond that contained in the CASP EIR is necessary. The City further finds that no substantial changes are proposed in the Project that would require major revisions to the CASP EIR because of new significant environmental effects or a substantial increase in the severity of previously identified significant effects; no substantial changes occur with respect to the circumstances under which the Project will be undertaken which will require major revisions of the LMSAP EIR due to the involvement of new significant environmental effects or a substantial increase in the severity of previously identified significant effects; and there is no new information of substantial importance not known and which could not have been known with the exercise of reasonable diligence as of the time of certification of the CASP EIR showing that the Project will

have one or more significant effects not discussed in the CASP EIR; significant effects previously examined will be substantially more severe than shown in the CASP EIR, mitigation measures or alternatives previously found not to be feasible would in fact be feasible and would substantially reduce one or more significant effects of the Project; or mitigation measures or alternatives which are considerably different from those analyzed in the CASP EIR would substantially reduce one or more significant effects on the environment.

Based on these findings and determinations, the City further finds that no Subsequent or Supplemental EIR or additional environmental analysis shall be required because of the Project. The City has considered the CEQA Analysis along with the CASP EIR prior to making its decision on the Project and a discussion is set out in the CEQA Analysis explaining the City's decision not to prepare a Subsequent or Supplemental EIR pursuant to Guidelines sections 15162 and/or 15163.

IV. Severability: The City finds that all three CEQA provisions discussed and determined to be applicable in Section III above are separately and independently applicable to the consideration of the Project and should any of the three be determined not to be so applicable, such determinations shall have no effect on the validity of these findings and the approval of the Project on any of the other grounds.

V. Incorporation by Reference of Statement of Overriding Considerations: The CASP EIR identified five areas of environmental effects of the CASP that presented significant and unavoidable impacts. Because the Project may contribute to some significant and unavoidable impacts identified in the CASP EIR, but a Subsequent and/or Supplemental EIR is not required in accordance with CEQA Guidelines sections 15162, 15163, 15164, and 15183, a Statement of Overriding Considerations is not legally required. Nevertheless, in the interest of being conservative, the Statement of Overriding Consideration for the CASP EIR, approved as Section XII of the CEQA Findings adopted by the City Council on March 31, 2015, via Resolution No. 85491 C.M.S., is hereby incorporated by reference as if fully set forth herein.

Attachment B

Part 1: Standard Conditions of Approval – General Administrative Conditions

1. **Approved Use**

The project shall be constructed and operated in accordance with the authorized use as described in the approved application materials, **staff report** and the approved plans **dated 5/2/16**, as amended by the following conditions of approval and mitigation measures, if applicable (“Conditions of Approval” or “Conditions”).

2. **Effective Date, Expiration, Extensions and Extinguishment**

This Approval shall become effective immediately, unless the Approval is appealable, in which case the Approval shall become effective in ten calendar days unless an appeal is filed. Unless a different termination date is prescribed, this Approval shall expire **two years** from the Approval date, or from the date of the final decision in the event of an appeal, unless within such period all necessary permits for construction or alteration have been issued, or the authorized activities have commenced in the case of a permit not involving construction or alteration. Upon written request and payment of appropriate fees submitted no later than the expiration date of this Approval, the Director of City Planning or designee may grant a one-year extension of this date, with additional extensions subject to approval by the approving body. Expiration of any necessary building permit or other construction-related permit for this project may invalidate this Approval if said Approval has also expired. If litigation is filed challenging this Approval, or its implementation, then the time period stated above for obtaining necessary permits for construction or alteration and/or commencement of authorized activities is automatically extended for the duration of the litigation.

3. **Compliance with Other Requirements**

The project applicant shall comply with all other applicable federal, state, regional, and local laws/codes, requirements, regulations, and guidelines, including but not limited to those imposed by the City’s Bureau of Building, Fire Marshal, and Public Works Department. Compliance with other applicable requirements may require changes to the approved use and/or plans. These changes shall be processed in accordance with the procedures contained in Condition #4.

4. **Minor and Major Changes**

Minor changes to the approved project, plans, Conditions, facilities, or use may be approved administratively by the Director of City Planning.

Major changes to the approved project, plans, Conditions, facilities, or use shall be reviewed by the Director of City Planning to determine whether such changes require submittal and approval of a revision to the Approval by the original approving body or a new independent permit/approval. Major revisions shall be reviewed in accordance with the procedures required for the original permit/approval. A new independent permit/approval shall be reviewed in accordance with the procedures required for the new permit/approval.

5. Compliance with Conditions of Approval

- a. The project applicant and property owner, including successors, (collectively referred to hereafter as the “project applicant” or “applicant”) shall be responsible for compliance with all the Conditions of Approval and any recommendations contained in any submitted and approved technical report at his/her sole cost and expense, subject to review and approval by the City of Oakland.
- b. The City of Oakland reserves the right at any time during construction to require certification by a licensed professional at the project applicant’s expense that the as-built project conforms to all applicable requirements, including but not limited to, approved maximum heights and minimum setbacks. Failure to construct the project in accordance with the Approval may result in remedial reconstruction, permit revocation, permit modification, stop work, permit suspension, or other corrective action.
- c. Violation of any term, Condition, or project description relating to the Approval is unlawful, prohibited, and a violation of the Oakland Municipal Code. The City of Oakland reserves the right to initiate civil and/or criminal enforcement and/or abatement proceedings, or after notice and public hearing, to revoke the Approval or alter these Conditions if it is found that there is violation of any of the Conditions or the provisions of the Planning Code or Municipal Code, or the project operates as or causes a public nuisance. This provision is not intended to, nor does it, limit in any manner whatsoever the ability of the City to take appropriate enforcement actions. The project applicant shall be responsible for paying fees in accordance with the City’s Master Fee Schedule for inspections conducted by the City or a City-designated third-party to investigate alleged violations of the Approval or Conditions.

6. Signed Copy of the Approval/Conditions

A copy of the Approval letter and Conditions shall be signed by the project applicant, attached to each set of permit plans submitted to the appropriate City agency for the project, and made available for review at the project job site at all times.

7. Blight/Nuisances

The project site shall be kept in a blight/nuisance-free condition. Any existing blight or nuisance shall be abated within 60 days of approval, unless an earlier date is specified elsewhere.

8. Indemnification

- a. To the maximum extent permitted by law, the project applicant shall defend (with counsel acceptable to the City), indemnify, and hold harmless the City of Oakland, the Oakland City Council, the Oakland Redevelopment Successor Agency, the Oakland City Planning Commission, and their respective agents, officers, employees, and volunteers (hereafter

collectively called "City") from any liability, damages, claim, judgment, loss (direct or indirect), action, causes of action, or proceeding (including legal costs, attorneys' fees, expert witness or consultant fees, City Attorney or staff time, expenses or costs) (collectively called "Action") against the City to attack, set aside, void or annul this Approval or implementation of this Approval. The City may elect, in its sole discretion, to participate in the defense of said Action and the project applicant shall reimburse the City for its reasonable legal costs and attorneys' fees.

Within ten (10) calendar days of the filing of any Action as specified in subsection (a) above, the project applicant shall execute a Joint Defense Letter of Agreement with the City, acceptable to the Office of the City Attorney, which memorializes the above obligations. These obligations and the Joint Defense Letter of Agreement shall survive termination, extinguishment, or invalidation of the Approval. Failure to timely execute the Letter of Agreement does not relieve the project applicant of any of the obligations contained in this Condition or other requirements or Conditions of Approval that may be imposed by the City.

9. Severability

The Approval would not have been granted but for the applicability and validity of each and every one of the specified Conditions, and if one or more of such Conditions is found to be invalid by a court of competent jurisdiction this Approval would not have been granted without requiring other valid Conditions consistent with achieving the same purpose and intent of such Approval.

10. Special Inspector/Inspections, Independent Technical Review, Project Coordination and Monitoring

The project applicant may be required to cover the full costs of independent third-party technical review and City monitoring and inspection, including without limitation, special inspector(s)/inspection(s) during times of extensive or specialized plan-check review or construction, and inspections of potential violations of the Conditions of Approval. The project applicant shall establish a deposit with the Bureau of Building, if directed by the Building Official, Director of City Planning, or designee, prior to the issuance of a construction-related permit and on an ongoing as-needed basis.

11. Public Improvements

The project applicant shall obtain all necessary permits/approvals, such as encroachment permits, obstruction permits, curb/gutter/sidewalk permits, and public improvement ("p-job") permits from the City for work in the public right-of-way, including but not limited to, streets, curbs, gutters, sidewalks, utilities, and fire hydrants. Prior to any work in the public right-of-way, the applicant shall submit plans for review and approval by the Bureau of Planning, the Bureau of Building, and other City departments as required. Public improvements shall be designed and installed to the satisfaction of the City.

Part 2: Standard Conditions of Approval – Environmental Protection Measures

GENERAL

12. Regulatory Permits and Authorizations from Other Agencies

Requirement: The project applicant shall obtain all necessary regulatory permits and authorizations from applicable resource/regulatory agencies including, but not limited to, the Regional Water Quality Control Board, Bay Area Air Quality Management District, Bay Conservation and Development Commission, California Department of Fish and Wildlife, U. S. Fish and Wildlife Service, and Army Corps of Engineers and shall comply with all requirements and conditions of the permits/authorizations. The project applicant shall submit evidence of the approved permits/authorizations to the City, along with evidence demonstrating compliance with any regulatory permit/authorization conditions of approval.

When Required: Prior to activity requiring permit/authorization from regulatory agency

Initial Approval: Approval by applicable regulatory agency with jurisdiction; evidence of approval submitted to Bureau of Planning

Monitoring/Inspection: Applicable regulatory agency with jurisdiction

AESTHETICS

13. Graffiti Control

Requirement:

a. During construction and operation of the project, the project applicant shall incorporate best management practices reasonably related to the control of graffiti and/or the mitigation of the impacts of graffiti. Such best management practices may include, without limitation:

- i. Installation and maintenance of landscaping to discourage defacement of and/or protect likely graffiti-attracting surfaces.
- ii. Installation and maintenance of lighting to protect likely graffiti-attracting surfaces.
- iii. Use of paint with anti-graffiti coating.
- iv. Incorporation of architectural or design elements or features to discourage graffiti defacement in accordance with the principles of Crime Prevention Through Environmental Design (CPTED).
- v. Other practices approved by the City to deter, protect, or reduce the potential for graffiti defacement.

The project applicant shall remove graffiti by appropriate means within seventy-two (72) hours. Appropriate means include the following:

CONDITIONS OF APPROVAL

- i. Removal through scrubbing, washing, sanding, and/or scraping (or similar method) without damaging the surface and without discharging wash water or cleaning detergents into the City storm drain system.
- ii. Covering with new paint to match the color of the surrounding surface.
- iii. Replacing with new surfacing (with City permits if required).

When Required: Ongoing

Initial Approval: N/A

Monitoring/Inspection: Bureau of Building

14. Landscape Plan

a. *Landscape Plan Required*

Requirement: The project applicant shall submit a final Landscape Plan for City review and approval that is consistent with the approved Landscape Plan. The Landscape Plan shall be included with the set of drawings submitted for the construction-related permit and shall comply with the landscape requirements of chapter 17.124 of the Planning Code.

When Required: Prior to approval of construction-related permit

Initial Approval: Bureau of Planning

Monitoring/Inspection: N/A

Landscape Installation

Requirement: The project applicant shall implement the approved Landscape Plan unless a bond, cash deposit, letter of credit, or other equivalent instrument acceptable to the Director of City Planning, is provided. The financial instrument shall equal the greater of \$2,500 or the estimated cost of implementing the Landscape Plan based on a licensed contractor's bid.

When Required: Prior to building permit final

Initial Approval: Bureau of Planning

Monitoring/Inspection: Bureau of Building

Landscape Maintenance

Requirement: All required planting shall be permanently maintained in good growing condition and, whenever necessary, replaced with new plant materials to ensure continued compliance with applicable landscaping requirements. The property owner shall be responsible for maintaining planting in adjacent public rights-of-way. All required fences, walls, and irrigation systems shall be permanently maintained in good condition and, whenever necessary, repaired or replaced.

When Required: Ongoing

Initial Approval: N/A

Monitoring/Inspection: Bureau of Building

15. Lighting

Requirement: Proposed new exterior lighting fixtures shall be adequately shielded to a point below the light bulb and reflector to prevent unnecessary glare onto adjacent properties.

When Required: Prior to building permit final

Initial Approval: N/A

Monitoring/Inspection: Bureau of Building

AIR QUALITY

16. Construction-Related Air Pollution Controls (Dust and Equipment Emissions)

Requirement: The project applicant shall implement all of the following applicable air pollution control measures during construction of the project:

- a. Water all exposed surfaces of active construction areas at least twice daily. Watering should be sufficient to prevent airborne dust from leaving the site. Increased watering frequency may be necessary whenever wind speeds exceed 15 miles per hour. Reclaimed water should be used whenever feasible.
- b. Cover all trucks hauling soil, sand, and other loose materials or require all trucks to maintain at least two feet of freeboard (i.e., the minimum required space between the top of the load and the top of the trailer).
- c. All visible mud or dirt track-out onto adjacent public roads shall be removed using wet power vacuum street sweepers at least once per day. The use of dry power sweeping is prohibited.
- d. Pave all roadways, driveways, sidewalks, etc. within one month of site grading or as soon as feasible. In addition, building pads should be laid within one month of grading or as soon as feasible unless seeding or soil binders are used.
- e. Enclose, cover, water twice daily, or apply (non-toxic) soil stabilizers to exposed stockpiles (dirt, sand, etc.).
- f. Limit vehicle speeds on unpaved roads to 15 miles per hour.
- g. Idling times on all diesel-fueled commercial vehicles over 10,000 lbs. shall be minimized either by shutting equipment off when not in use or reducing the maximum idling time to five minutes (as required by the California airborne toxics control measure Title 13, Section 2485, of the California Code of Regulations). Clear signage to this effect shall be provided for construction workers at all access points.
- h. Idling times on all diesel-fueled off-road vehicles over 25 horsepower shall be minimized either by shutting equipment off when not in use or reducing the maximum idling time to five minutes and fleet operators must develop a written policy as required by Title 23, Section 2449, of the California Code of Regulations ("California Air Resources Board Off-Road Diesel Regulations").
- i. All construction equipment shall be maintained and properly tuned in accordance with the manufacturer's specifications. All equipment shall be checked by a certified mechanic and determined to be running in proper condition prior to operation.
- j. Portable equipment shall be powered by electricity if available. If electricity is not available, propane or natural gas shall be used if feasible. Diesel engines shall only be used if electricity is not available and it is not feasible to use propane or natural gas.

When Required: During construction

Initial Approval: N/A

Monitoring/Inspection: Bureau of Building

BIOLOGICAL RESOURCES

17. Bird Collision Reduction Measures

Requirement: The project applicant shall submit a Bird Collision Reduction Plan for City review and approval to reduce potential bird collisions to the maximum feasible extent. The Plan shall include all of the following mandatory measures, as well as applicable and specific project Best Management Practice (BMP) strategies to reduce bird strike impacts to the maximum feasible extent. The project applicant shall implement the approved Plan. Mandatory measures include all of the following:

- i. For large buildings subject to federal aviation safety regulations, install minimum intensity white strobe lighting with three second flash instead of solid red or rotating lights.
- ii. Minimize the number of and co-locate rooftop-antennas and other rooftop structures.
- iii. Monopole structures or antennas shall not include guy wires.
- iv. Avoid the use of mirrors in landscape design.
- v. Avoid placement of bird-friendly attractants (i.e., landscaped areas, vegetated roofs, water features) near glass unless shielded by architectural features taller than the attractant that incorporate bird friendly treatments no more than two inches horizontally, four inches vertically, or both (the “two-by-four” rule), as explained below.
- vi. Apply bird-friendly glazing treatments to no less than 90 percent of all windows and glass between the ground and 60 feet above ground or to the height of existing adjacent landscape or the height of the proposed landscape. Examples of bird-friendly glazing treatments include the following:
 - Use opaque glass in window panes instead of reflective glass.
 - Uniformly cover the interior or exterior of clear glass surface with patterns (e.g., dots, stripes, decals, images, abstract patterns). Patterns can be etched, fritted, or on films and shall have a density of no more than two inches horizontally, four inches vertically, or both (the “two-by-four” rule).
 - Install paned glass with fenestration patterns with vertical and horizontal mullions no more than two inches horizontally, four inches vertically, or both (the “two-by-four” rule).
 - Install external screens over non-reflective glass (as close to the glass as possible) for birds to perceive windows as solid objects.
 - Install UV-pattern reflective glass, laminated glass with a patterned UV-reflective coating, or UV-absorbing and UV-reflecting film on the glass since most birds can see ultraviolet light, which is invisible to humans.
 - Install decorative grilles, screens, netting, or louvers, with openings no more than two inches horizontally, four inches vertically, or both (the “two-by-four” rule).

- Install awnings, overhangs, sunshades, or light shelves directly adjacent to clear glass which is recessed on all sides.
 - Install opaque window film or window film with a pattern/design which also adheres to the “two-by-four” rule for coverage.
- vi. Reduce light pollution. Examples include the following:
- Extinguish night-time architectural illumination treatments during bird migration season (February 15 to May 15 and August 15 to November 30).
 - Install time switch control devices or occupancy sensors on non-emergency interior lights that can be programmed to turn off during non-work hours and between 11:00 p.m. and sunrise.
 - Reduce perimeter lighting whenever possible.
 - Install full cut-off, shielded, or directional lighting to minimize light spillage, glare, or light trespass.
 - Do not use beams of lights during the spring (February 15 to May 15) or fall (August 15 to November 30) migration.
- vii. Develop and implement a building operation and management manual that promotes bird safety. Example measures in the manual include the following:
- Donation of discovered dead bird specimens to an authorized bird conservation organization or museums (e.g., UC Berkeley Museum of Vertebrate Zoology) to aid in species identification and to benefit scientific study, as per all federal, state and local laws.
 - Distribution of educational materials on bird-safe practices for the building occupants. Contact Golden Gate Audubon Society or American Bird Conservancy for materials.
 - Asking employees to turn off task lighting at their work stations and draw office blinds, shades, curtains, or other window coverings at end of work day.
 - Install interior blinds, shades, or other window coverings in windows above the ground floor visible from the exterior as part of the construction contract, lease agreement, or CC&Rs.
 - Schedule nightly maintenance during the day or to conclude before 11 p.m., if possible.

When Required: Prior to approval of construction-related permit

Initial Approval: Bureau of Planning

Monitoring/Inspection: Bureau of Building

18. Tree Removal During Bird Breeding Season

Requirement: To the extent feasible, removal of any tree and/or other vegetation suitable for nesting of birds shall not occur during the bird breeding season of February 1 to August 15 (or during December 15 to August 15 for trees located in or near marsh, wetland, or aquatic habitats). If tree removal must occur during the bird breeding season, all trees to be removed shall be surveyed by a qualified biologist to verify the presence or absence of nesting raptors or other birds. Pre-removal surveys shall be conducted within 15 days prior to the start of work and shall be submitted to the City for review and approval. If the survey indicates the potential presence of nesting raptors or other birds, the biologist shall determine an appropriately sized buffer around the nest in which no work will be allowed until the young have successfully fledged. The size of the nest buffer will be determined by the biologist in consultation with the California Department of Fish and Wildlife, and will be based to a large extent on the nesting species and its sensitivity to disturbance. In general, buffer sizes of 200 feet for raptors and 50 feet for other birds should suffice to prevent disturbance to birds nesting in the urban environment, but these buffers may be increased or decreased, as appropriate, depending on the bird species and the level of disturbance anticipated near the nest.

When Required: Prior to removal of trees

Initial Approval: Bureau of Building

Monitoring/Inspection: Bureau of Building

19. Tree Permit**a. Tree Permit Required**

Requirement: Pursuant to the City's Tree Protection Ordinance (OMC chapter 12.36), the project applicant shall obtain a tree permit and abide by the conditions of that permit.

When Required: Prior to approval of construction-related permit

Initial Approval: Permit approval by Public Works Department, Tree Division; evidence of approval submitted to Bureau of Building

Monitoring/Inspection: Bureau of Building

Tree Protection During Construction

Requirement: Adequate protection shall be provided during the construction period for any trees which are to remain standing, including the following, plus any recommendations of an arborist:

- i. Before the start of any clearing, excavation, construction, or other work on the site, every protected tree deemed to be potentially endangered by said site work shall be securely fenced off at a distance from the base of the tree to be determined by the project's consulting arborist. Such fences shall remain in place for duration of all such work. All trees to be removed shall be clearly marked. A scheme shall be established for the removal and disposal of logs, brush, earth and other debris which will avoid injury to any protected tree.
- ii. Where proposed development or other site work is to encroach upon the protected perimeter of any protected tree, special measures shall be incorporated to allow the roots to breathe and obtain water and nutrients. Any excavation, cutting, filing, or compaction of the existing ground surface within the protected perimeter shall be

- minimized. No change in existing ground level shall occur within a distance to be determined by the project's consulting arborist from the base of any protected tree at any time. No burning or use of equipment with an open flame shall occur near or within the protected perimeter of any protected tree.
- iii. No storage or dumping of oil, gas, chemicals, or other substances that may be harmful to trees shall occur within the distance to be determined by the project's consulting arborist from the base of any protected trees, or any other location on the site from which such substances might enter the protected perimeter. No heavy construction equipment or construction materials shall be operated or stored within a distance from the base of any protected trees to be determined by the project's consulting arborist. Wires, ropes, or other devices shall not be attached to any protected tree, except as needed for support of the tree. No sign, other than a tag showing the botanical classification, shall be attached to any protected tree.
 - iv. Periodically during construction, the leaves of protected trees shall be thoroughly sprayed with water to prevent buildup of dust and other pollution that would inhibit leaf transpiration.
 - v. If any damage to a protected tree should occur during or as a result of work on the site, the project applicant shall immediately notify the Public Works Department and the project's consulting arborist shall make a recommendation to the City Tree Reviewer as to whether the damaged tree can be preserved. If, in the professional opinion of the Tree Reviewer, such tree cannot be preserved in a healthy state, the Tree Reviewer shall require replacement of any tree removed with another tree or trees on the same site deemed adequate by the Tree Reviewer to compensate for the loss of the tree that is removed.
 - vi. All debris created as a result of any tree removal work shall be removed by the project applicant from the property within two weeks of debris creation, and such debris shall be properly disposed of by the project applicant in accordance with all applicable laws, ordinances, and regulations.

When Required: During construction

Initial Approval: Public Works Department, Tree Division

Monitoring/Inspection: Bureau of Building

Tree Replacement Plantings

Requirement: Replacement plantings shall be required for tree removals for the purposes of erosion control, groundwater replenishment, visual screening, wildlife habitat, and preventing excessive loss of shade, in accordance with the following criteria:

- i. No tree replacement shall be required for the removal of nonnative species, for the removal of trees which is required for the benefit of remaining trees, or where insufficient planting area exists for a mature tree of the species being considered.
- ii. Replacement tree species shall consist of Sequoia sempervirens (Coast Redwood), Quercus agrifolia (Coast Live Oak), Arbutus menziesii (Madrone), Aesculus californica (California Buckeye), Umbellularia californica (California Bay Laurel), or other tree species acceptable to the Tree Division.

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- iii. Replacement trees shall be at least twenty-four (24) inch box size, unless a smaller size is recommended by the arborist, except that three fifteen (15) gallon size trees may be substituted for each twenty-four (24) inch box size tree where appropriate.
- iv. Minimum planting areas must be available on site as follows:
 - For Sequoia sempervirens, three hundred fifteen (315) square feet per tree;
 - For other species listed, seven hundred (700) square feet per tree.
- v. In the event that replacement trees are required but cannot be planted due to site constraints, an in lieu fee in accordance with the City's Master Fee Schedule may be substituted for required replacement plantings, with all such revenues applied toward tree planting in city parks, streets and medians.
- vi. The project applicant shall install the plantings and maintain the plantings until established. The Tree Reviewer of the Tree Division of the Public Works Department may require a landscape plan showing the replacement plantings and the method of irrigation. Any replacement plantings which fail to become established within one year of planting shall be replanted at the project applicant's expense.

When Required: Prior to building permit final

Initial Approval: Public Works Department, Tree Division

Monitoring/Inspection: Bureau of Building

CULTURAL RESOURCES

20. Archaeological and Paleontological Resources – Discovery During Construction

Requirement: Pursuant to CEQA Guidelines section 15064.5(f), in the event that any historic or prehistoric subsurface cultural resources are discovered during ground disturbing activities, all work within 50 feet of the resources shall be halted and the project applicant shall notify the City and consult with a qualified archaeologist or paleontologist, as applicable, to assess the significance of the find. In the case of discovery of paleontological resources, the assessment shall be done in accordance with the Society of Vertebrate Paleontology standards. If any find is determined to be significant, appropriate avoidance measures recommended by the consultant and approved by the City must be followed unless avoidance is determined unnecessary or infeasible by the City. Feasibility of avoidance shall be determined with consideration of factors such as the nature of the find, project design, costs, and other considerations. If avoidance is unnecessary or infeasible, other appropriate measures (e.g., data recovery, excavation) shall be instituted. Work may proceed on other parts of the project site while measures for the cultural resources are implemented.

In the event of data recovery of archaeological resources, the project applicant shall submit an Archaeological Research Design and Treatment Plan (ARDTP) prepared by a qualified archaeologist for review and approval by the City. The ARDTP is required to identify how the proposed data recovery program would preserve the significant information the archaeological resource is expected to contain. The ARDTP shall identify the scientific/historic research questions applicable to the expected resource, the data classes the resource is expected to possess, and how the expected data classes would address the applicable research questions. The ARDTP shall

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include the analysis and specify the curation and storage methods. Data recovery, in general, shall be limited to the portions of the archaeological resource that could be impacted by the proposed project. Destructive data recovery methods shall not be applied to portions of the archaeological resources if nondestructive methods are practicable. Because the intent of the ARDTP is to save as much of the archaeological resource as possible, including moving the resource, if feasible, preparation and implementation of the ARDTP would reduce the potential adverse impact to less than significant. The project applicant shall implement the ARDTP at his/her expense.

In the event of excavation of paleontological resources, the project applicant shall submit an excavation plan prepared by a qualified paleontologist to the City for review and approval. All significant cultural materials recovered shall be subject to scientific analysis, professional museum curation, and/or a report prepared by a qualified paleontologist, as appropriate, according to current professional standards and at the expense of the project applicant.

When Required: During construction

Initial Approval: N/A

Monitoring/Inspection: Bureau of Building

21. Human Remains – Discovery During Construction

Requirement: Pursuant to CEQA Guidelines section 15064.5(e)(1), in the event that human skeletal remains are uncovered at the project site during construction activities, all work shall immediately halt and the project applicant shall notify the City and the Alameda County Coroner. If the County Coroner determines that an investigation of the cause of death is required or that the remains are Native American, all work shall cease within 50 feet of the remains until appropriate arrangements are made. In the event that the remains are Native American, the City shall contact the California Native American Heritage Commission (NAHC), pursuant to subdivision (c) of section 7050.5 of the California Health and Safety Code. If the agencies determine that avoidance is not feasible, then an alternative plan shall be prepared with specific steps and timeframe required to resume construction activities. Monitoring, data recovery, determination of significance, and avoidance measures (if applicable) shall be completed expeditiously and at the expense of the project applicant.

When Required: During construction

Initial Approval: N/A

Monitoring/Inspection: Bureau of Building

GEOLOGY AND SOILS

22. Construction-Related Permit(s)

Requirement: The project applicant shall obtain all required construction-related permits/approvals from the City. The project shall comply with all standards, requirements and conditions contained in construction-related codes, including but not limited to the Oakland Building Code and the Oakland Grading Regulations, to ensure structural integrity and safe construction.

When Required: Prior to approval of construction-related permit

Initial Approval: Bureau of Building

Monitoring/Inspection: Bureau of Building

23. Seismic Hazards Zone (Landslide/Liquefaction)

Requirement: The project applicant shall submit a site-specific geotechnical report, consistent with California Geological Survey Special Publication 117 (as amended), prepared by a registered geotechnical engineer for City review and approval containing at a minimum a description of the geological and geotechnical conditions at the site, an evaluation of site-specific seismic hazards based on geological and geotechnical conditions, and recommended measures to reduce potential impacts related to liquefaction and/or slope stability hazards. The project applicant shall implement the recommendations contained in the approved report during project design and construction.

When Required: Prior to approval of construction-related permit

Initial Approval: Bureau of Building

Monitoring/Inspection: Bureau of Building

HAZARDS AND HAZARDOUS MATERIALS

24. Hazardous Materials Related to Construction

Requirement: The project applicant shall ensure that Best Management Practices (BMPs) are implemented by the contractor during construction to minimize potential negative effects on groundwater, soils, and human health. These shall include, at a minimum, the following:

- a. Follow manufacture's recommendations for use, storage, and disposal of chemical products used in construction;
- b. Avoid overtopping construction equipment fuel gas tanks;
- c. During routine maintenance of construction equipment, properly contain and remove grease and oils;
- d. Properly dispose of discarded containers of fuels and other chemicals;
- e. Implement lead-safe work practices and comply with all local, regional, state, and federal requirements concerning lead (for more information refer to the Alameda County Lead Poisoning Prevention Program); and
- f. If soil, groundwater, or other environmental medium with suspected contamination is encountered unexpectedly during construction activities (e.g., identified by odor or visual staining, or if any underground storage tanks, abandoned drums or other hazardous materials or wastes are encountered), the project applicant shall cease work in the vicinity of the suspect material, the area shall be secured as necessary, and the applicant shall take all appropriate measures to protect human health and the environment. Appropriate measures shall include notifying the City and applicable regulatory agency(ies) and implementation of the actions described in the City's Standard Conditions of Approval, as necessary, to identify the nature and extent of contamination. Work shall not resume in the area(s) affected until the measures have been implemented under the oversight of the City or regulatory agency, as appropriate.

When Required: During construction

Initial Approval: N/A

Monitoring/Inspection: Bureau of Building

HYDROLOGY AND WATER QUALITY

25. Erosion and Sedimentation Control Measures for Construction

Requirement: The project applicant shall implement Best Management Practices (BMPs) to reduce erosion, sedimentation, and water quality impacts during construction to the maximum extent practicable. At a minimum, the project applicant shall provide filter materials deemed acceptable to the City at nearby catch basins to prevent any debris and dirt from flowing into the City's storm drain system and creeks.

When Required: During construction

Initial Approval: N/A

Monitoring/Inspection: Bureau of Building

26. State Construction General Permit

Requirement: The project applicant shall comply with the requirements of the Construction General Permit issued by the State Water Resources Control Board (SWRCB). The project applicant shall submit a Notice of Intent (NOI), Stormwater Pollution Prevention Plan (SWPPP), and other required Permit Registration Documents to SWRCB. The project applicant shall submit evidence of compliance with Permit requirements to the City.

When Required: Prior to approval of construction-related permit

Initial Approval: State Water Resources Control Board; evidence of compliance submitted to Bureau of Building

Monitoring/Inspection: State Water Resources Control Board

27. NPDES C.3 Stormwater Requirements for Regulated Projects

a. Post-Construction Stormwater Management Plan Required

Requirement: The project applicant shall comply with the requirements of Provision C.3 of the Municipal Regional Stormwater Permit issued under the National Pollutant Discharge Elimination System (NPDES). The project applicant shall submit a Post-Construction Stormwater Management Plan to the City for review and approval with the project drawings submitted for site improvements, and shall implement the approved Plan during construction. The Post-Construction Stormwater Management Plan shall include and identify the following:

- i. Location and size of new and replaced impervious surface;
- ii. Directional surface flow of stormwater runoff;
- iii. Location of proposed on-site storm drain lines;
- iv. Site design measures to reduce the amount of impervious surface area;
- v. Source control measures to limit stormwater pollution;

- vi. Stormwater treatment measures to remove pollutants from stormwater runoff, including the method used to hydraulically size the treatment measures; and
- vii. Hydromodification management measures, if required by Provision C.3, so that post-project stormwater runoff flow and duration match pre-project runoff.

When Required: Prior to approval of construction-related permit

Initial Approval: Bureau of Planning; Bureau of Building

Monitoring/Inspection: Bureau of Building

Maintenance Agreement Required

Requirement: The project applicant shall enter into a maintenance agreement with the City, based on the Standard City of Oakland Stormwater Treatment Measures Maintenance Agreement, in accordance with Provision C.3, which provides, in part, for the following:

- i. The project applicant accepting responsibility for the adequate installation/construction, operation, maintenance, inspection, and reporting of any on-site stormwater treatment measures being incorporated into the project until the responsibility is legally transferred to another entity; and
- ii. Legal access to the on-site stormwater treatment measures for representatives of the City, the local vector control district, and staff of the Regional Water Quality Control Board, San Francisco Region, for the purpose of verifying the implementation, operation, and maintenance of the on-site stormwater treatment measures and to take corrective action if necessary.

The maintenance agreement shall be recorded at the County Recorder's Office at the applicant's expense.

When Required: Prior to building permit final

Initial Approval: Bureau of Building

Monitoring/Inspection: Bureau of Building

28. Structures in a Flood Zone

Requirement: The project shall be designed to ensure that new structures within a 100-year flood zone do not interfere with the flow of water or increase flooding. The project applicant shall submit plans and hydrological calculations for City review and approval with the construction-related drawings that show finished site grades and floor elevations elevated above the Base Flood Elevation (BFE).

When Required: Prior to approval of construction-related permit

Initial Approval: Bureau of Building

Monitoring/Inspection: Bureau of Building

NOISE

29. Construction Days/Hours

Requirement: The project applicant shall comply with the following restrictions concerning construction days and hours:

- a. Construction activities are limited to between 7:00 a.m. and 7:00 p.m. Monday through Friday, except that pier drilling and/or other extreme noise generating activities greater than 90 dBA shall be limited to between 8:00 a.m. and 4:00 p.m.
- b. Construction activities are limited to between 9:00 a.m. and 5:00 p.m. on Saturday. In residential zones and within 300 feet of a residential zone, construction activities are allowed from 9:00 a.m. to 5:00 p.m. only within the interior of the building with the doors and windows closed. No pier drilling or other extreme noise generating activities greater than 90 dBA are allowed on Saturday.
- c. No construction is allowed on Sunday or federal holidays.

Construction activities include, but are not limited to, truck idling, moving equipment (including trucks, elevators, etc.) or materials, deliveries, and construction meetings held on-site in a non-enclosed area.

Any construction activity proposed outside of the above days and hours for special activities (such as concrete pouring which may require more continuous amounts of time) shall be evaluated on a case-by-case basis by the City, with criteria including the urgency/emergency nature of the work, the proximity of residential or other sensitive uses, and a consideration of nearby residents'/occupants' preferences. The project applicant shall notify property owners and occupants located within 300 feet at least 14 calendar days prior to construction activity proposed outside of the above days/hours. When submitting a request to the City to allow construction activity outside of the above days/hours, the project applicant shall submit information concerning the type and duration of proposed construction activity and the draft public notice for City review and approval prior to distribution of the public notice.

When Required: During construction

Initial Approval: N/A

Monitoring/Inspection: Bureau of Building

30. Construction Noise

Requirement: The project applicant shall implement noise reduction measures to reduce noise impacts due to construction. Noise reduction measures include, but are not limited to, the following:

- a. Equipment and trucks used for project construction shall utilize the best available noise control techniques (e.g., improved mufflers, equipment redesign, use of intake silencers, ducts, engine enclosures and acoustically-attenuating shields or shrouds) wherever feasible.
- b. Except as provided herein, impact tools (e.g., jack hammers, pavement breakers, and rock drills) used for project construction shall be hydraulically or electrically powered to avoid noise associated with compressed air exhaust from pneumatically powered tools. However, where use of pneumatic tools is unavoidable, an exhaust muffler on the compressed air exhaust shall be used; this muffler can lower noise levels from the exhaust by up to about 10 dBA. External jackets on the tools themselves shall be used, if such jackets are commercially available, and this could achieve a reduction of 5 dBA. Quieter procedures shall be used, such as drills rather than impact equipment, whenever such procedures are available and consistent with construction procedures.
- c. Applicant shall use temporary power poles instead of generators where feasible.

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- d. Stationary noise sources shall be located as far from adjacent properties as possible, and they shall be muffled and enclosed within temporary sheds, incorporate insulation barriers, or use other measures as determined by the City to provide equivalent noise reduction.
- e. The noisiest phases of construction shall be limited to less than 10 days at a time. Exceptions may be allowed if the City determines an extension is necessary and all available noise reduction controls are implemented.

When Required: During construction

Initial Approval: N/A

Monitoring/Inspection: Bureau of Building

31. **Extreme Construction Noise**

a. Construction Noise Management Plan Required

Requirement: Prior to any extreme noise generating construction activities (e.g., pier drilling, pile driving and other activities generating greater than 90dBA), the project applicant shall submit a Construction Noise Management Plan prepared by a qualified acoustical consultant for City review and approval that contains a set of site-specific noise attenuation measures to further reduce construction impacts associated with extreme noise generating activities. The project applicant shall implement the approved Plan during construction. Potential attenuation measures include, but are not limited to, the following:

- i. Erect temporary plywood noise barriers around the construction site, particularly along on sites adjacent to residential buildings;
- ii. Implement “quiet” pile driving technology (such as pre-drilling of piles, the use of more than one pile driver to shorten the total pile driving duration), where feasible, in consideration of geotechnical and structural requirements and conditions;
- iii. Utilize noise control blankets on the building structure as the building is erected to reduce noise emission from the site;
- iv. Evaluate the feasibility of noise control at the receivers by temporarily improving the noise reduction capability of adjacent buildings by the use of sound blankets for example and implement such measure if such measures are feasible and would noticeably reduce noise impacts; and
- v. Monitor the effectiveness of noise attenuation measures by taking noise measurements.

When Required: Prior to approval of construction-related permit

Initial Approval: Bureau of Building

Monitoring/Inspection: Bureau of Building

Public Notification Required

Requirement: The project applicant shall notify property owners and occupants located within 300 feet of the construction activities at least 14 calendar days prior to commencing extreme noise generating activities. Prior to providing the notice, the project applicant shall submit to the City for review and approval the proposed type and duration of extreme noise generating activities and the proposed public notice. The public notice shall provide the estimated start and end dates of the extreme noise generating activities and describe noise attenuation measures to be implemented.

When Required: During construction

Initial Approval: Bureau of Building

Monitoring/Inspection: Bureau of Building

32. Operational Noise

Requirement: Noise levels from the project site after completion of the project (i.e., during project operation) shall comply with the performance standards of chapter 17.120 of the Oakland Planning Code and chapter 8.18 of the Oakland Municipal Code. If noise levels exceed these standards, the activity causing the noise shall be abated until appropriate noise reduction measures have been installed and compliance verified by the City.

When Required: Ongoing

Initial Approval: N/A

Monitoring/Inspection: Bureau of Building

TRANSPORTATION/TRAFFIC

33. Construction Activity in the Public Right-of-Way

a. Obstruction Permit Required

Requirement: The project applicant shall obtain an obstruction permit from the City prior to placing any temporary construction-related obstruction in the public right-of-way, including City streets and sidewalks.

When Required: Prior to approval of construction-related permit

Initial Approval: Bureau of Building

Monitoring/Inspection: Bureau of Building

Traffic Control Plan Required

Requirement: In the event of obstructions to vehicle or bicycle travel lanes, the project applicant shall submit a Traffic Control Plan to the City for review and approval prior to obtaining an obstruction permit. The project applicant shall submit evidence of City approval of the Traffic Control Plan with the application for an obstruction permit. The Traffic Control Plan shall contain a set of comprehensive traffic control measures for auto, transit, bicycle, and pedestrian detours, including detour signs if required, lane closure procedures, signs, cones for drivers, and designated construction access routes. The project applicant shall implement the approved Plan during construction.

When Required: Prior to approval of construction-related permit

Initial Approval: Public Works Department, Transportation Services Division

Monitoring/Inspection: Bureau of Building

Repair of City Streets

Requirement: The project applicant shall repair any damage to the public right-of way, including streets and sidewalks caused by project construction at his/her expense within one week of the occurrence of the damage (or excessive wear), unless further damage/excessive wear may continue; in such case, repair shall occur prior to approval of the final inspection of

the construction-related permit. All damage that is a threat to public health or safety shall be repaired immediately.

When Required: Prior to building permit final

Initial Approval: N/A

Monitoring/Inspection: Bureau of Building

34. Bicycle Parking

Requirement: The project applicant shall comply with the City of Oakland Bicycle Parking Requirements (chapter 17.118 of the Oakland Planning Code). The project drawings submitted for construction-related permits shall demonstrate compliance with the requirements.

When Required: Prior to approval of construction-related permit

Initial Approval: Bureau of Planning

Monitoring/Inspection: Bureau of Building

UTILITY AND SERVICE SYSTEMS

35. Construction and Demolition Waste Reduction and Recycling

Requirement: The project applicant shall comply with the City of Oakland Construction and Demolition Waste Reduction and Recycling Ordinance (chapter 15.34 of the Oakland Municipal Code) by submitting a Construction and Demolition Waste Reduction and Recycling Plan (WRRP) for City review and approval, and shall implement the approved WRRP. Projects subject to these requirements include all new construction, renovations/alterations/modifications with construction values of \$50,000 or more (except R-3 type construction), and all demolition (including soft demolition) except demolition of type R-3 construction. The WRRP must specify the methods by which the project will divert construction and demolition debris waste from landfill disposal in accordance with current City requirements. The WRRP may be submitted electronically at www.greenhalosystems.com or manually at the City’s Green Building Resource Center. Current standards, FAQs, and forms are available on the City’s website and in the Green Building Resource Center.

When Required: Prior to approval of construction-related permit

Initial Approval: Public Works Department, Environmental Services Division

Monitoring/Inspection: Public Works Department, Environmental Services Division

36. Underground Utilities

Requirement: The project applicant shall place underground all new utilities serving the project and under the control of the project applicant and the City, including all new gas, electric, cable, and telephone facilities, fire alarm conduits, street light wiring, and other wiring, conduits, and similar facilities. The new facilities shall be placed underground along the project’s street frontage and from the project structures to the point of service. Utilities under the control of other agencies, such as PG&E, shall be placed underground if feasible. All utilities shall be installed in accordance with standard specifications of the serving utilities.

When Required: During construction

Initial Approval: N/A

Monitoring/Inspection: Bureau of Building

37. Recycling Collection and Storage Space

Requirement: The project applicant shall comply with the City of Oakland Recycling Space Allocation Ordinance (chapter 17.118 of the Oakland Planning Code). The project drawings submitted for construction-related permits shall contain recycling collection and storage areas in compliance with the Ordinance. For residential projects, at least two cubic feet of storage and collection space per residential unit is required, with a minimum of ten cubic feet. For nonresidential projects, at least two cubic feet of storage and collection space per 1,000 square feet of building floor area is required, with a minimum of ten cubic feet.

When Required: Prior to approval of construction-related permit

Initial Approval: Bureau of Planning

Monitoring/Inspection: Bureau of Building

38. Green Building Requirements

a. Compliance with Green Building Requirements During Plan-Check

Requirement: The project applicant shall comply with the requirements of the California Green Building Standards (CALGreen) mandatory measures and the applicable requirements of the City of Oakland Green Building Ordinance (chapter 18.02 of the Oakland Municipal Code).

- i. The following information shall be submitted to the City for review and approval with the application for a building permit:
 - Documentation showing compliance with Title 24 of the current version of the California Building Energy Efficiency Standards.
 - Completed copy of the final green building checklist approved during the review of the Planning and Zoning permit.
 - Copy of the Unreasonable Hardship Exemption, if granted, during the review of the Planning and Zoning permit.
 - Permit plans that show, in general notes, detailed design drawings, and specifications as necessary, compliance with the items listed in subsection (ii) below.
 - Copy of the signed statement by the Green Building Certifier approved during the review of the Planning and Zoning permit that the project complied with the requirements of the Green Building Ordinance.
 - Signed statement by the Green Building Certifier that the project still complies with the requirements of the Green Building Ordinance, unless an Unreasonable Hardship Exemption was granted during the review of the Planning and Zoning permit.
 - Other documentation as deemed necessary by the City to demonstrate compliance with the Green Building Ordinance.
- ii. The set of plans in subsection (i) shall demonstrate compliance with the following:

CONDITIONS OF APPROVAL

- CALGreen mandatory measures.
- **LEED Silver** per the appropriate checklist approved during the Planning entitlement process.
- All green building points identified on the checklist approved during review of the Planning and Zoning permit, unless a Request for Revision Plan-check application is submitted and approved by the Bureau of Planning that shows the previously approved points that will be eliminated or substituted.
- The required green building point minimums in the appropriate credit categories.

When Required: Prior to approval of construction-related permit

Initial Approval: Bureau of Building

Monitoring/Inspection: N/A

Compliance with Green Building Requirements During Construction

Requirement: The project applicant shall comply with the applicable requirements of CALGreen and the Oakland Green Building Ordinance during construction of the project.

The following information shall be submitted to the City for review and approval:

- i. Completed copies of the green building checklists approved during the review of the Planning and Zoning permit and during the review of the building permit.
- ii. Signed statement(s) by the Green Building Certifier during all relevant phases of construction that the project complies with the requirements of the Green Building Ordinance.
- iii. Other documentation as deemed necessary by the City to demonstrate compliance with the Green Building Ordinance.

When Required: During construction

Initial Approval: N/A

Monitoring/Inspection: Bureau of Building

Compliance with Green Building Requirements After Construction

Requirement: Prior to finalizing the Building Permit, the Green Building Certifier shall submit the appropriate documentation to City staff and attain the minimum required point level.

When Required: After project completion as specified

Initial Approval: Bureau of Planning

Monitoring/Inspection: Bureau of Building

39. Green Building Requirements – Small Projects

a. Compliance with Green Building Requirements During Plan-Check

The project applicant shall comply with the requirements of the California Green Building Standards (CALGreen) mandatory measures and the applicable requirements of the City of Oakland Green Building Ordinance (chapter 18.02 of the Oakland Municipal Code) for projects using the **Bay Friendly Landscape Checklist**

- i. The following information shall be submitted to the City for review and approval with application for a building permit:

- Documentation showing compliance with Title 24 of the current version of the California Building Energy Efficiency Standards.
 - Completed copy of the green building checklist approved during the review of a Planning and Zoning permit.
 - Permit plans that show in general notes, detailed design drawings and specifications as necessary compliance with the items listed in subsection (b) below.
 - Other documentation to prove compliance.
- ii. The set of plans in subsection (a) shall demonstrate compliance with the following:
- CALGreen mandatory measures.
 - All applicable green building measures identified on the checklist approved during the review of a Planning and Zoning permit, or submittal of a Request for Revision Plan-check application that shows the previously approved points that will be eliminated or substituted.

When Required: Prior to approval of construction-related permit

Initial Approval: Bureau of Building

Monitoring/Inspection: N/A

Compliance with Green Building Requirements During Construction

Requirement: The project applicant shall comply with the applicable requirements of CALGreen and the Green Building Ordinance during construction.

The following information shall be submitted to the City for review and approval:

- i. Completed copy of the green building checklists approved during review of the Planning and Zoning permit and during the review of the Building permit.
- ii. Other documentation as deemed necessary by the City to demonstrate compliance with the Green Building Ordinance.


When Required: During construction

Initial Approval: N/A

Monitoring/Inspection: Bureau of Building



ATTACHMENT C

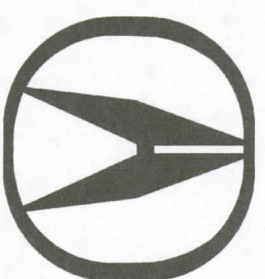

ACURA OF OAKLAND

6701 OAKPORT STREET
OAKLAND, CALIFORNIA



**Michael Zucker
& Associates**
Architecture • Interior Design
155 Montgomery Street Suite 201
San Francisco, CA 94104
T 415.957.0909
F 415.957.0638

ISSUE DATE
PROJECT REVIEW 1 05/22/2016

PROJECT DATA

OCCUPANCY CLASSIFICATION: B, S-3, S-1
ZONE: D-CO-3
CODE EDITION: CALIFORNIA BUILDING CODE 2013
TYPE OF CONSTRUCTION: TYPE V-N SPRINKLERED
SITE AREA: 157,905 SF (3.625 ACRES)
BUILDING GROSS AREA: 38,000 GSF
BUILDING HEIGHT: 2 FLOORS; 27'-6"

PROJECT TEAM

Owner / Developer:
Mr. Gordon Walton
Walnut Creek Associates 5, Inc.
277 27th Street
Oakland, CA 94612

Architect:
MICHAEL ZUCKER & ASSOCIATES
155 Montgomery Street, suite 201
San Francisco, CA 94104
Michael F. Zucker, AIA

Landscape Architect:
PGA Design
LANDSCAPE ARCHITECTS
444 17th Street
Oakland, CA 94612
Ms. Chris Pattillo FASLA

Structural Engineer:
IDA Structural Engineers, Inc.
1629 Telegraph Avenue, Suite 300
Oakland, CA 94612
Mr. Stephen DeJesse, SE


Mechanical, Electrical & Plumbing Engineer:
Glumac Engineers
150 California Street, Suite 300
Mr. Michael Howe

Geotechnical & Civil Engineer:
ARUP
560 Mission Street, Suite 700
San Francisco, CA 94105
Mr. Martin Walker P.E.

General Contractor:
Zac Crouse
Crouse Construction Company
1551 Third Ave.
Walnut Creek, CA 94596

EIR / CEQA:
Lamphier-Gregory
1944 Embarcadero
Oakland, CA 94606
Mr. Scott Gregory


VICINITY MAP

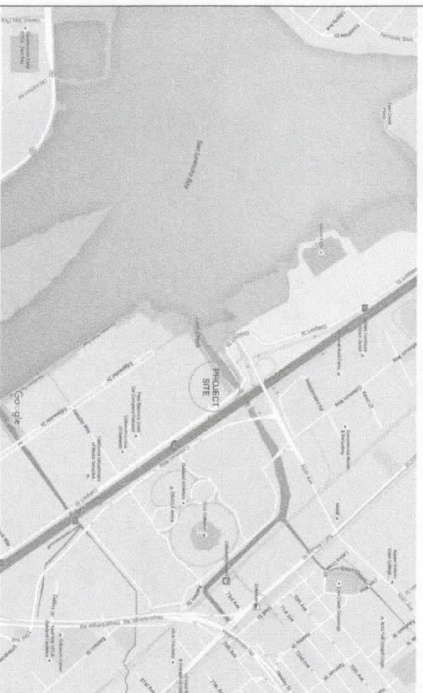

DRAWING INDEX

| | |
|--------|--------------------------------------|
| A-0.1 | COVER PAGE |
| A-0.2 | PERSPECTIVE 1 |
| A-0.3 | PERSPECTIVE 2 |
| A-0.4 | SURVEY WITH PROPOSED BLDG. FOOTPRINT |
| A-1.0 | SITE PLAN |
| A-2.0 | GROUND FLOOR PLAN |
| A-3.0 | 2ND FLOOR PLAN |
| A-4.0 | EAST AND NORTH ELEVATIONS |
| A-5.0 | WEST AND SOUTH ELEVATIONS |
| 1 OF 1 | SURVEY |
| L-1.0 | LANDSCAPE PLAN |

PARCEL MAP

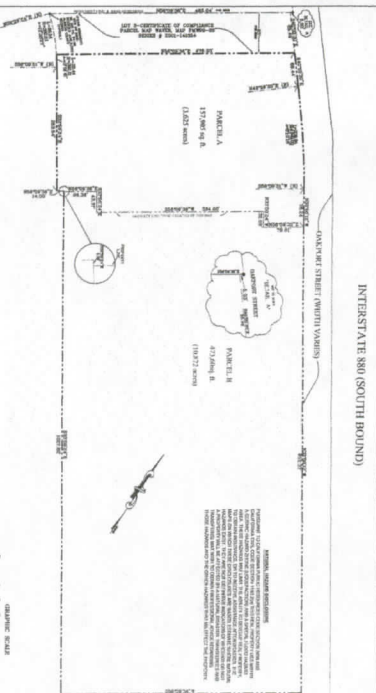

APPLICABLE CODES

THE WORK SHALL BE PERFORMED IN ACCORDANCE WITH APPLICABLE CODE REQUIREMENTS, AND APPLICABLE REQUIREMENTS OF ALL OTHER REGULATORY AGENCIES, INCLUDING, BUT NOT LIMITED TO THE FOLLOWING:

- CALIFORNIA BUILDING CODE 2013
- CALIFORNIA ELECTRICAL CODE 2013
- CALIFORNIA MECHANICAL CODE 2013
- CALIFORNIA PLUMBING CODE 2013
- CALIFORNIA ENERGY CODE 2013
- CALIFORNIA FIRE CODE 2013
- STATE REFERENCE STANDARDS CODE 2013
- NATIONAL FIRE PROTECTION ASSOCIATION PAMPHLETS 13 & 72, 2013 EDITION

PROJECT TITLE/ADDRESS:
ACURA
of Oakland

6701 Oakport Street
Oakland, CA 94621

STAMPS/APPROVALS



PROJECT NO.
DRAWN BY
SCALE AS NOTED
SHEET TITLE
REGIONAL AND VICINITY MAPS
SHEET NUMBER

A-0



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ISSUE DATE
DEVELOPMENT REVIEW 05/11/2016



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ACURA
of Oakland

6701 Oakport Street
Oakland, CA 94621
STAMPS/APPROVALS:



PROJECT NO.:
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SCALE: AS NOTED
SHEET TITLE

PERSPECTIVE 1

SHEET NUMBER

A-0.2



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PROJECT REVIEW 1 06/22/2016



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of Oakland

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STAMPS/APPROVALS




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SHEET TITLE

PERSPECTIVE 2

SHEET NUMBER

A-0.3

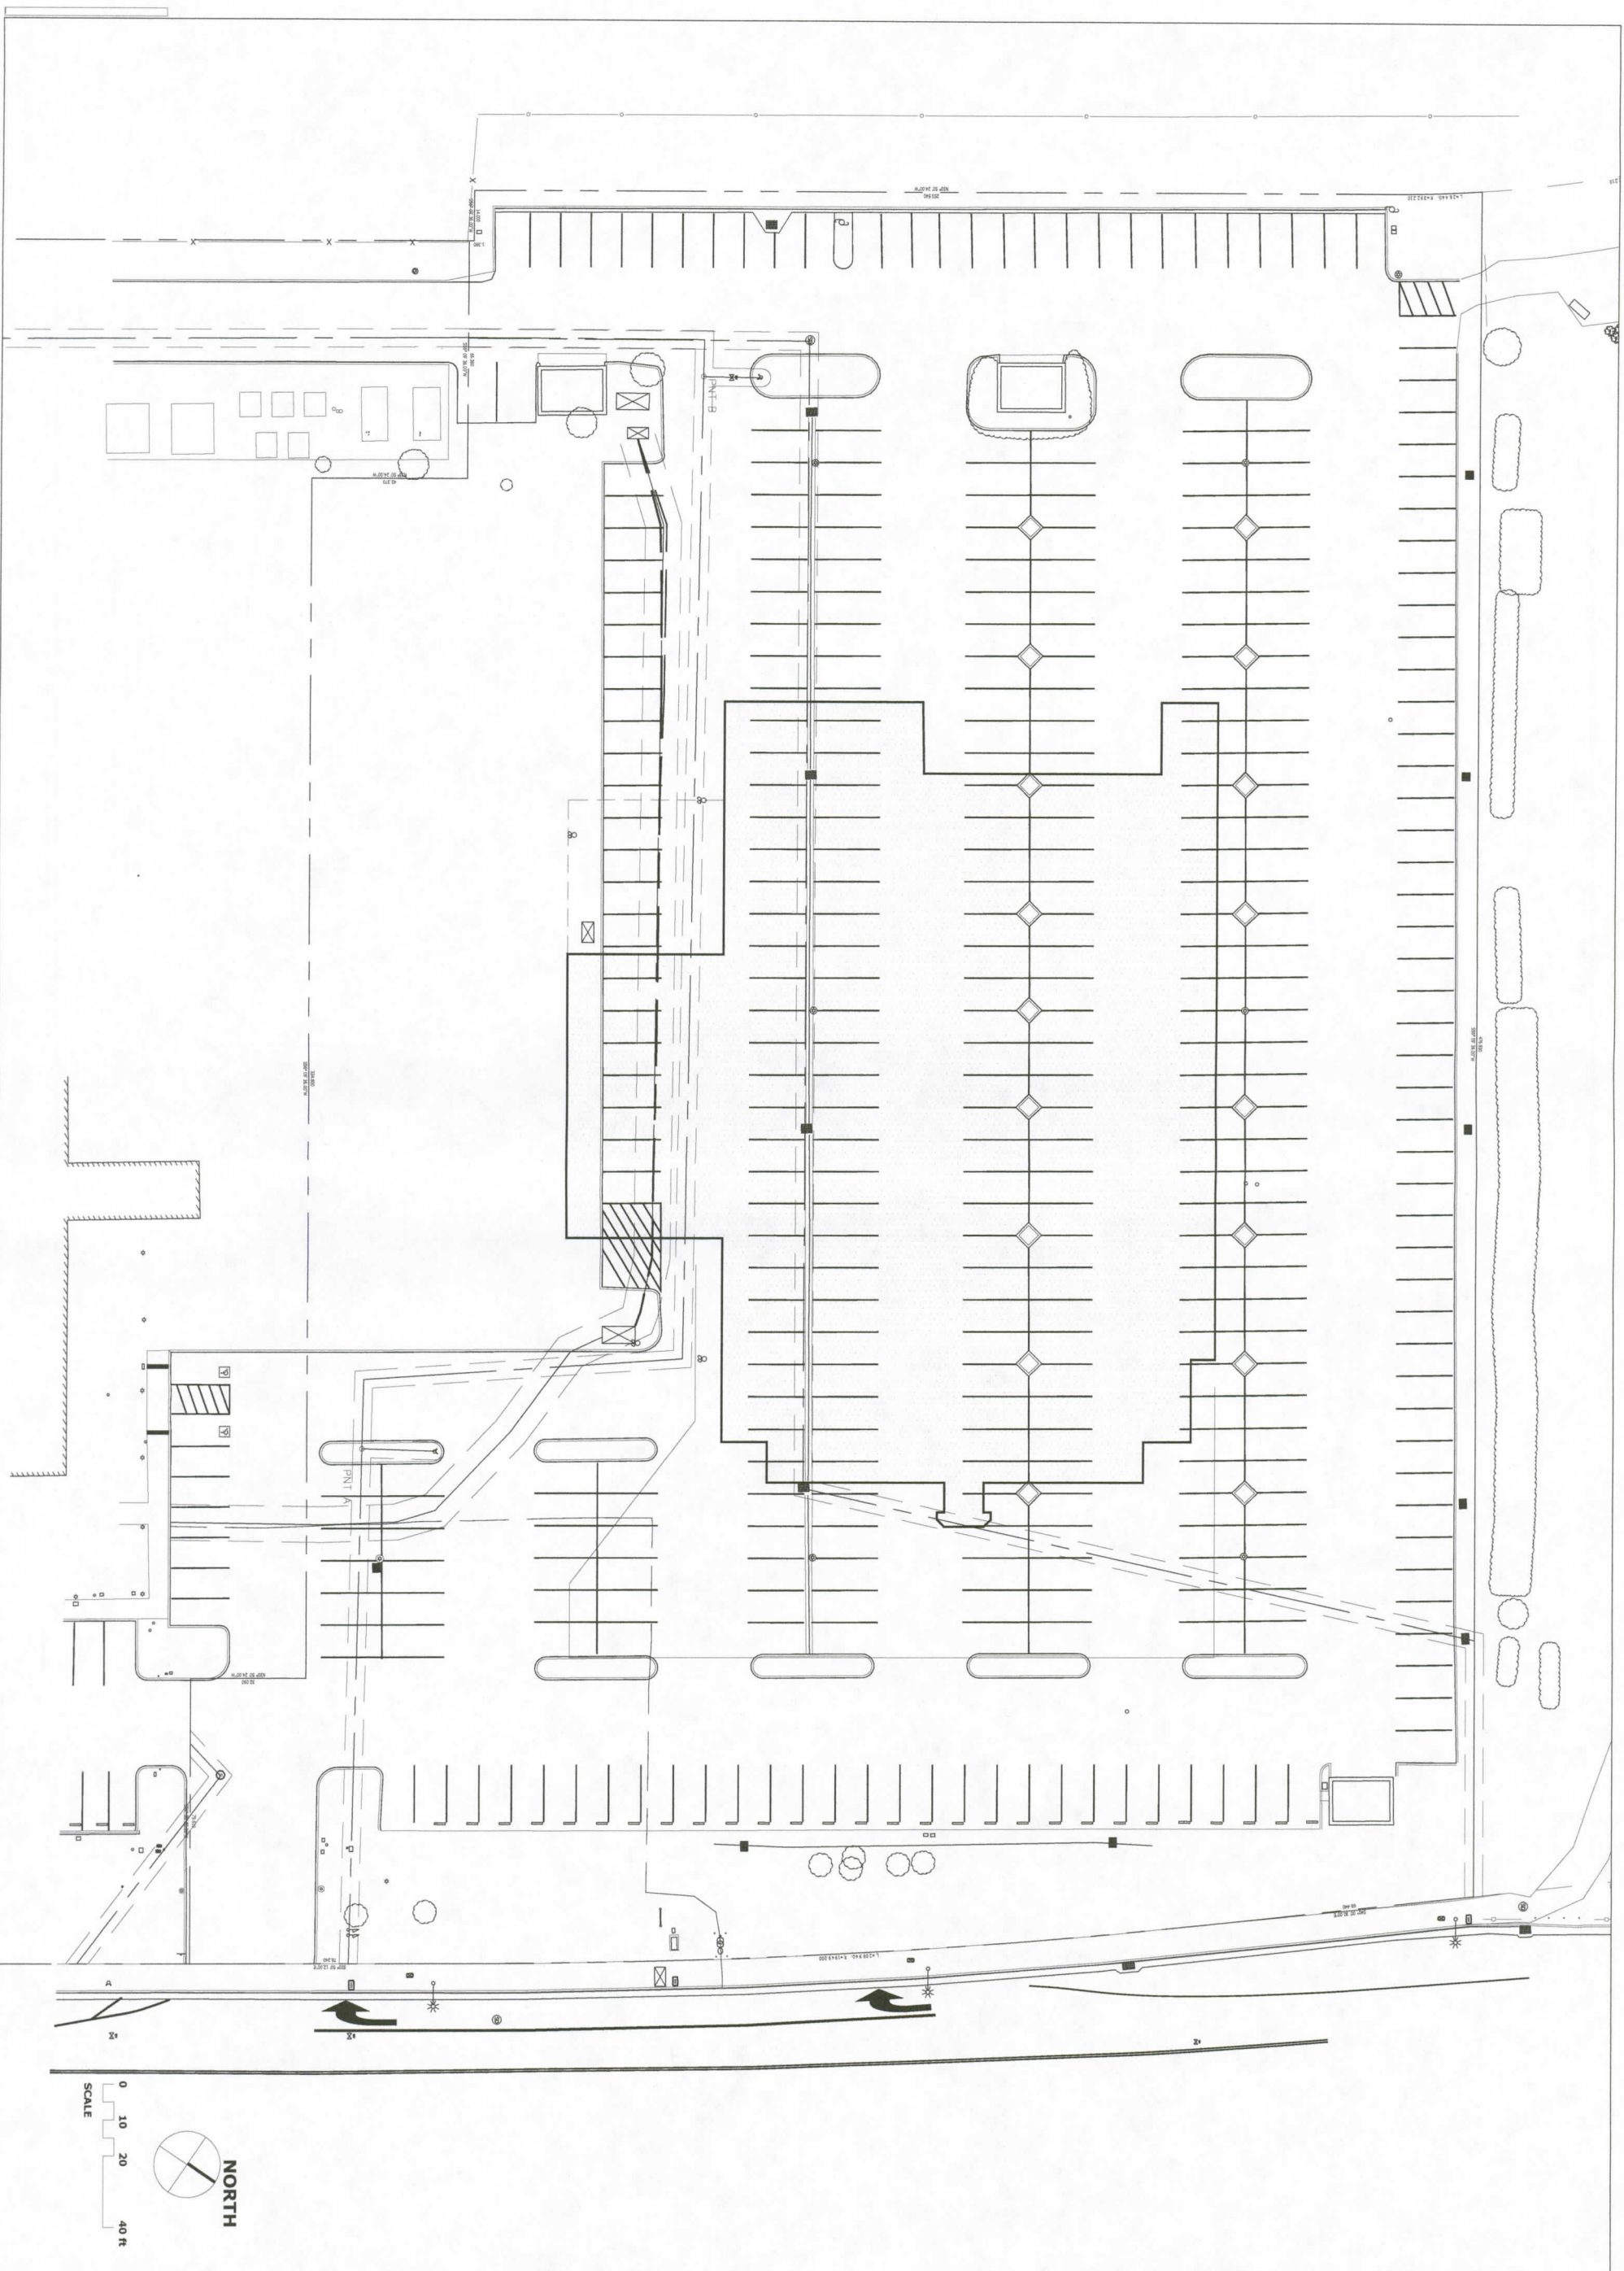



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 DEVELOPMENT REVIEW 05/11/2016



PROJECT TITLE/ADDRESS:
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 of Oakland

6701 Oakport Street
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 STAMPS/APPROVALS

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 SHEET TITLE
**SURVEY WITH
 (P) BLDG.
 FOOTPRINT**
 SHEET NUMBER
A-0.4

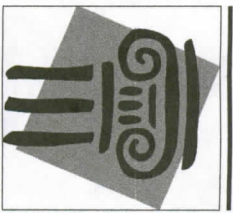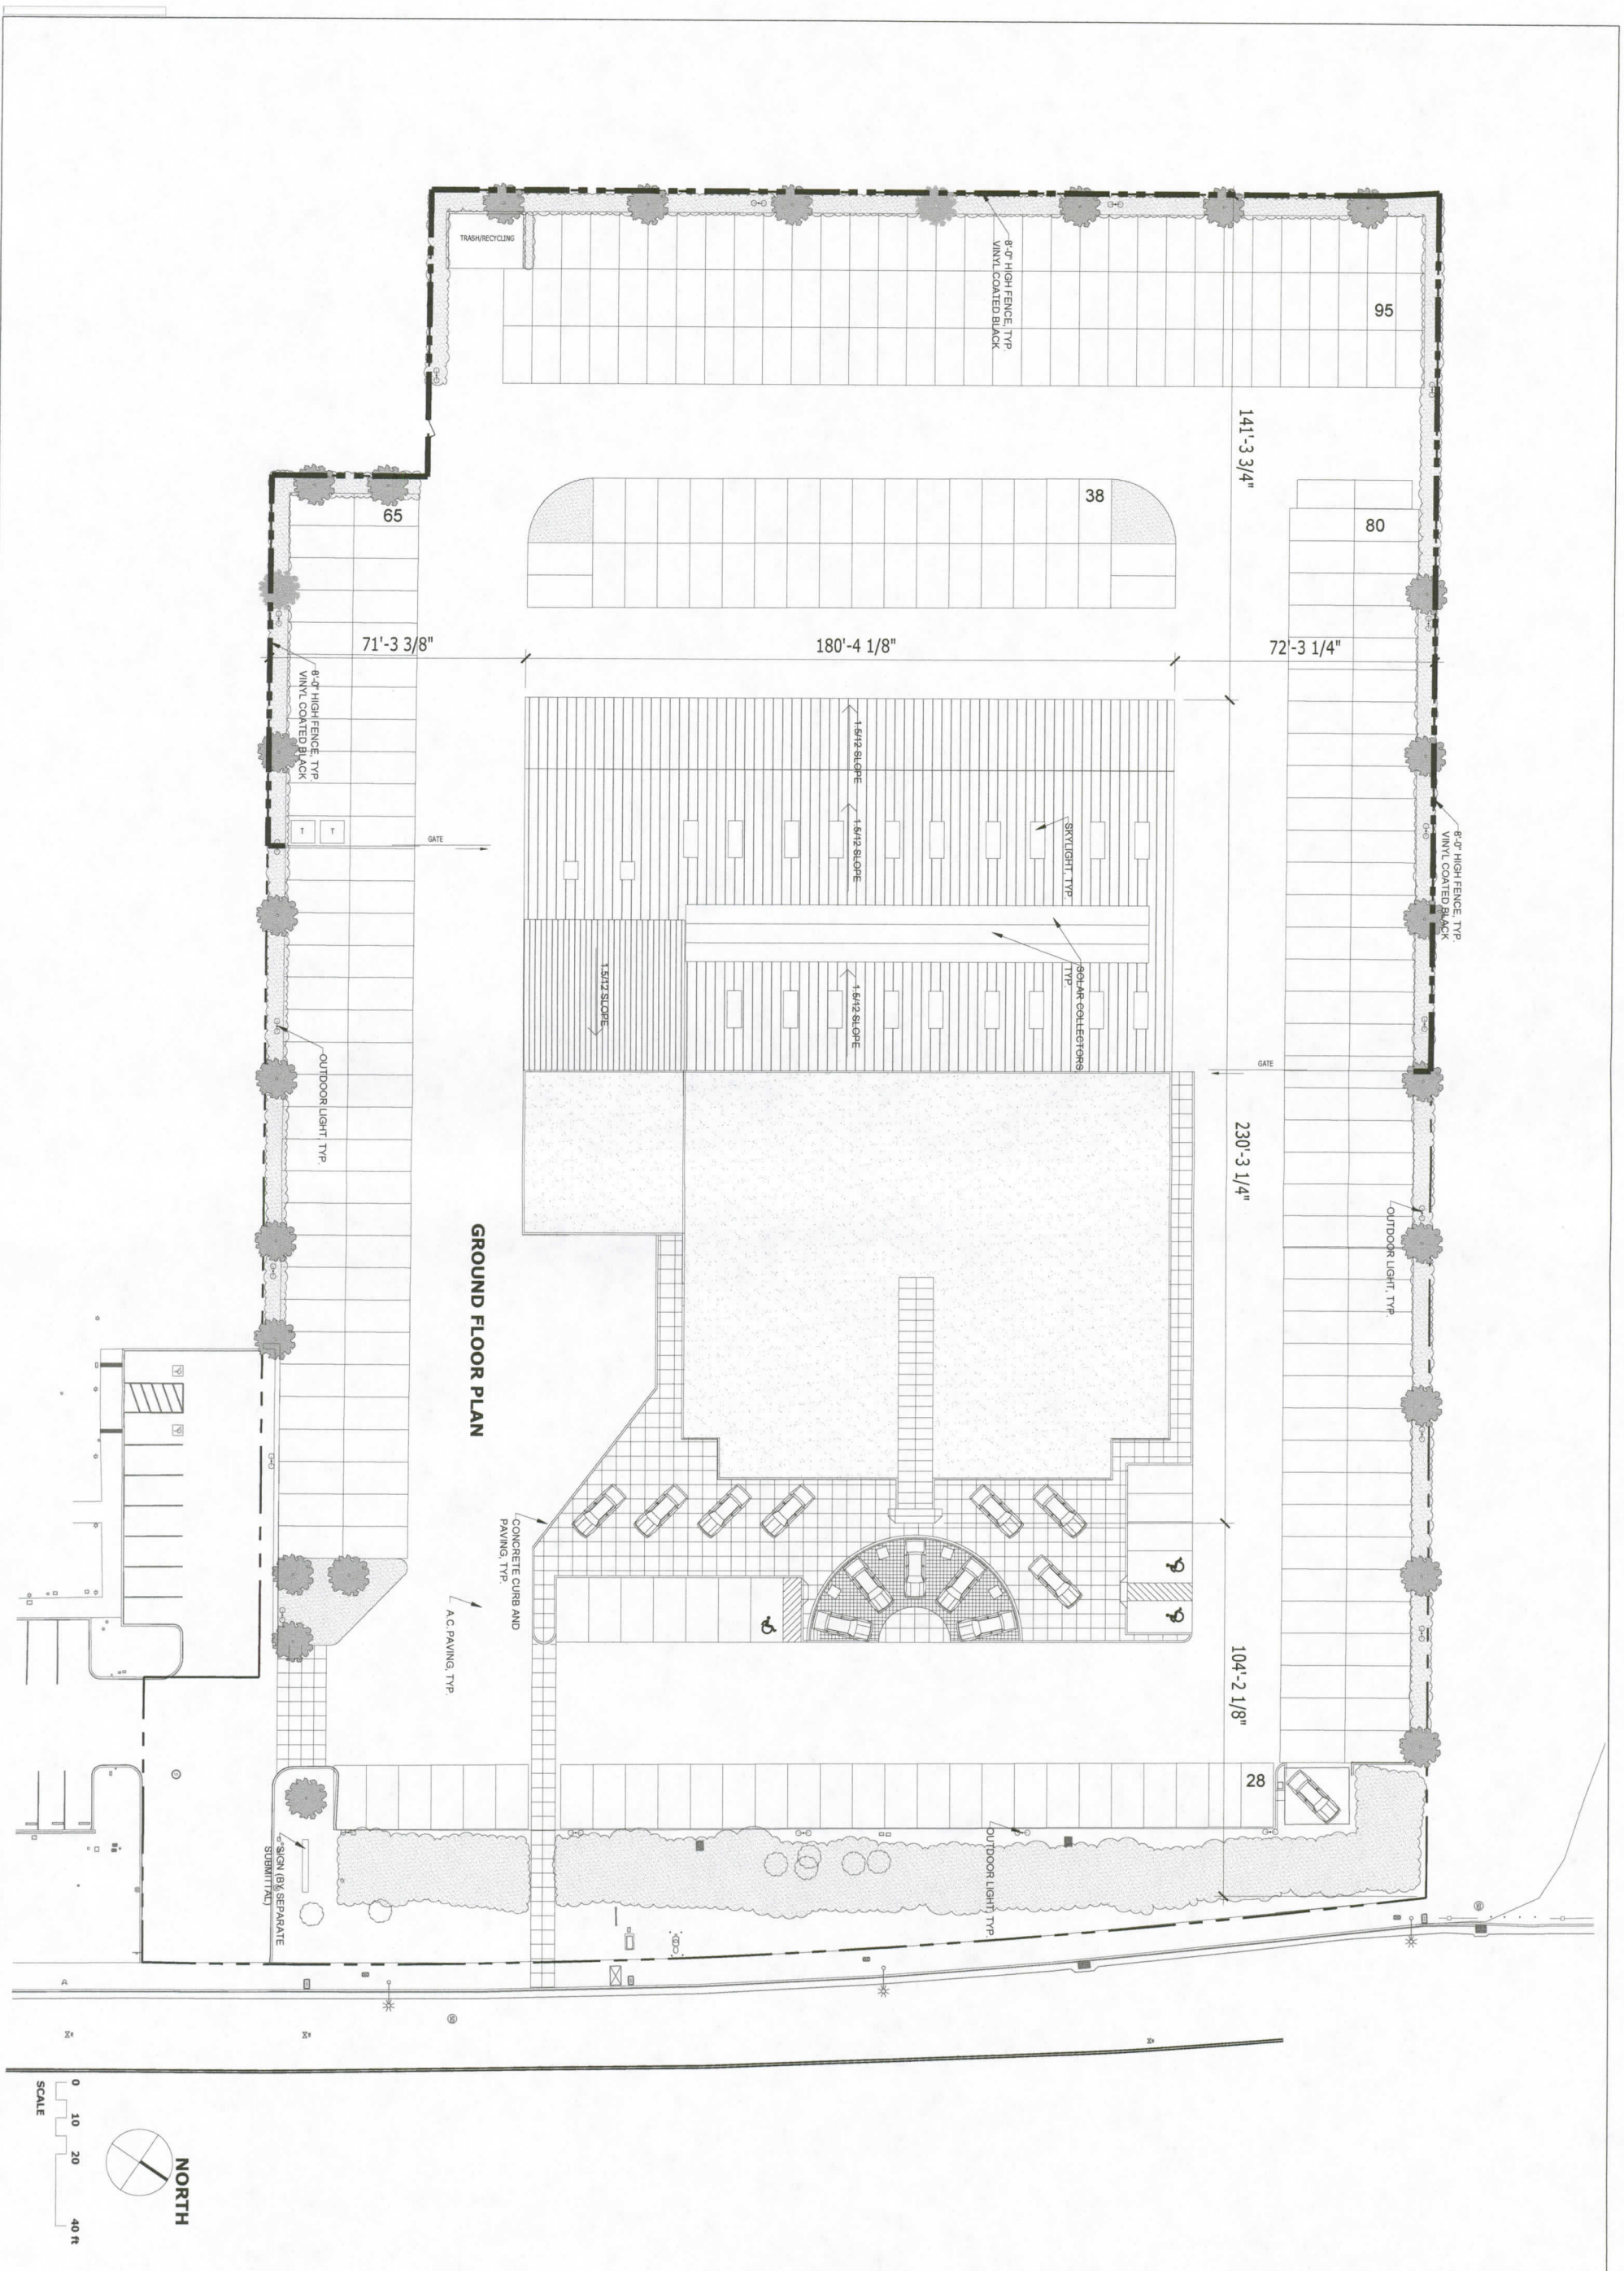


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 F 415.957.0938
 ISSUE DATE
 PROJECT REVIEW 1 08/02/2016



PROJECT TITLE/ADDRESS:
ACURA
 of Oakland
 6701 Oakport Street
 Oakland, CA 94621
 STAMP/STAR APPROVALS



PROJECT NO.:
 DRAWN BY:
 SCALE: 1"=30'-0"
 SHEET TITLE
SITE PLAN
 SHEET NUMBER
A-1.0

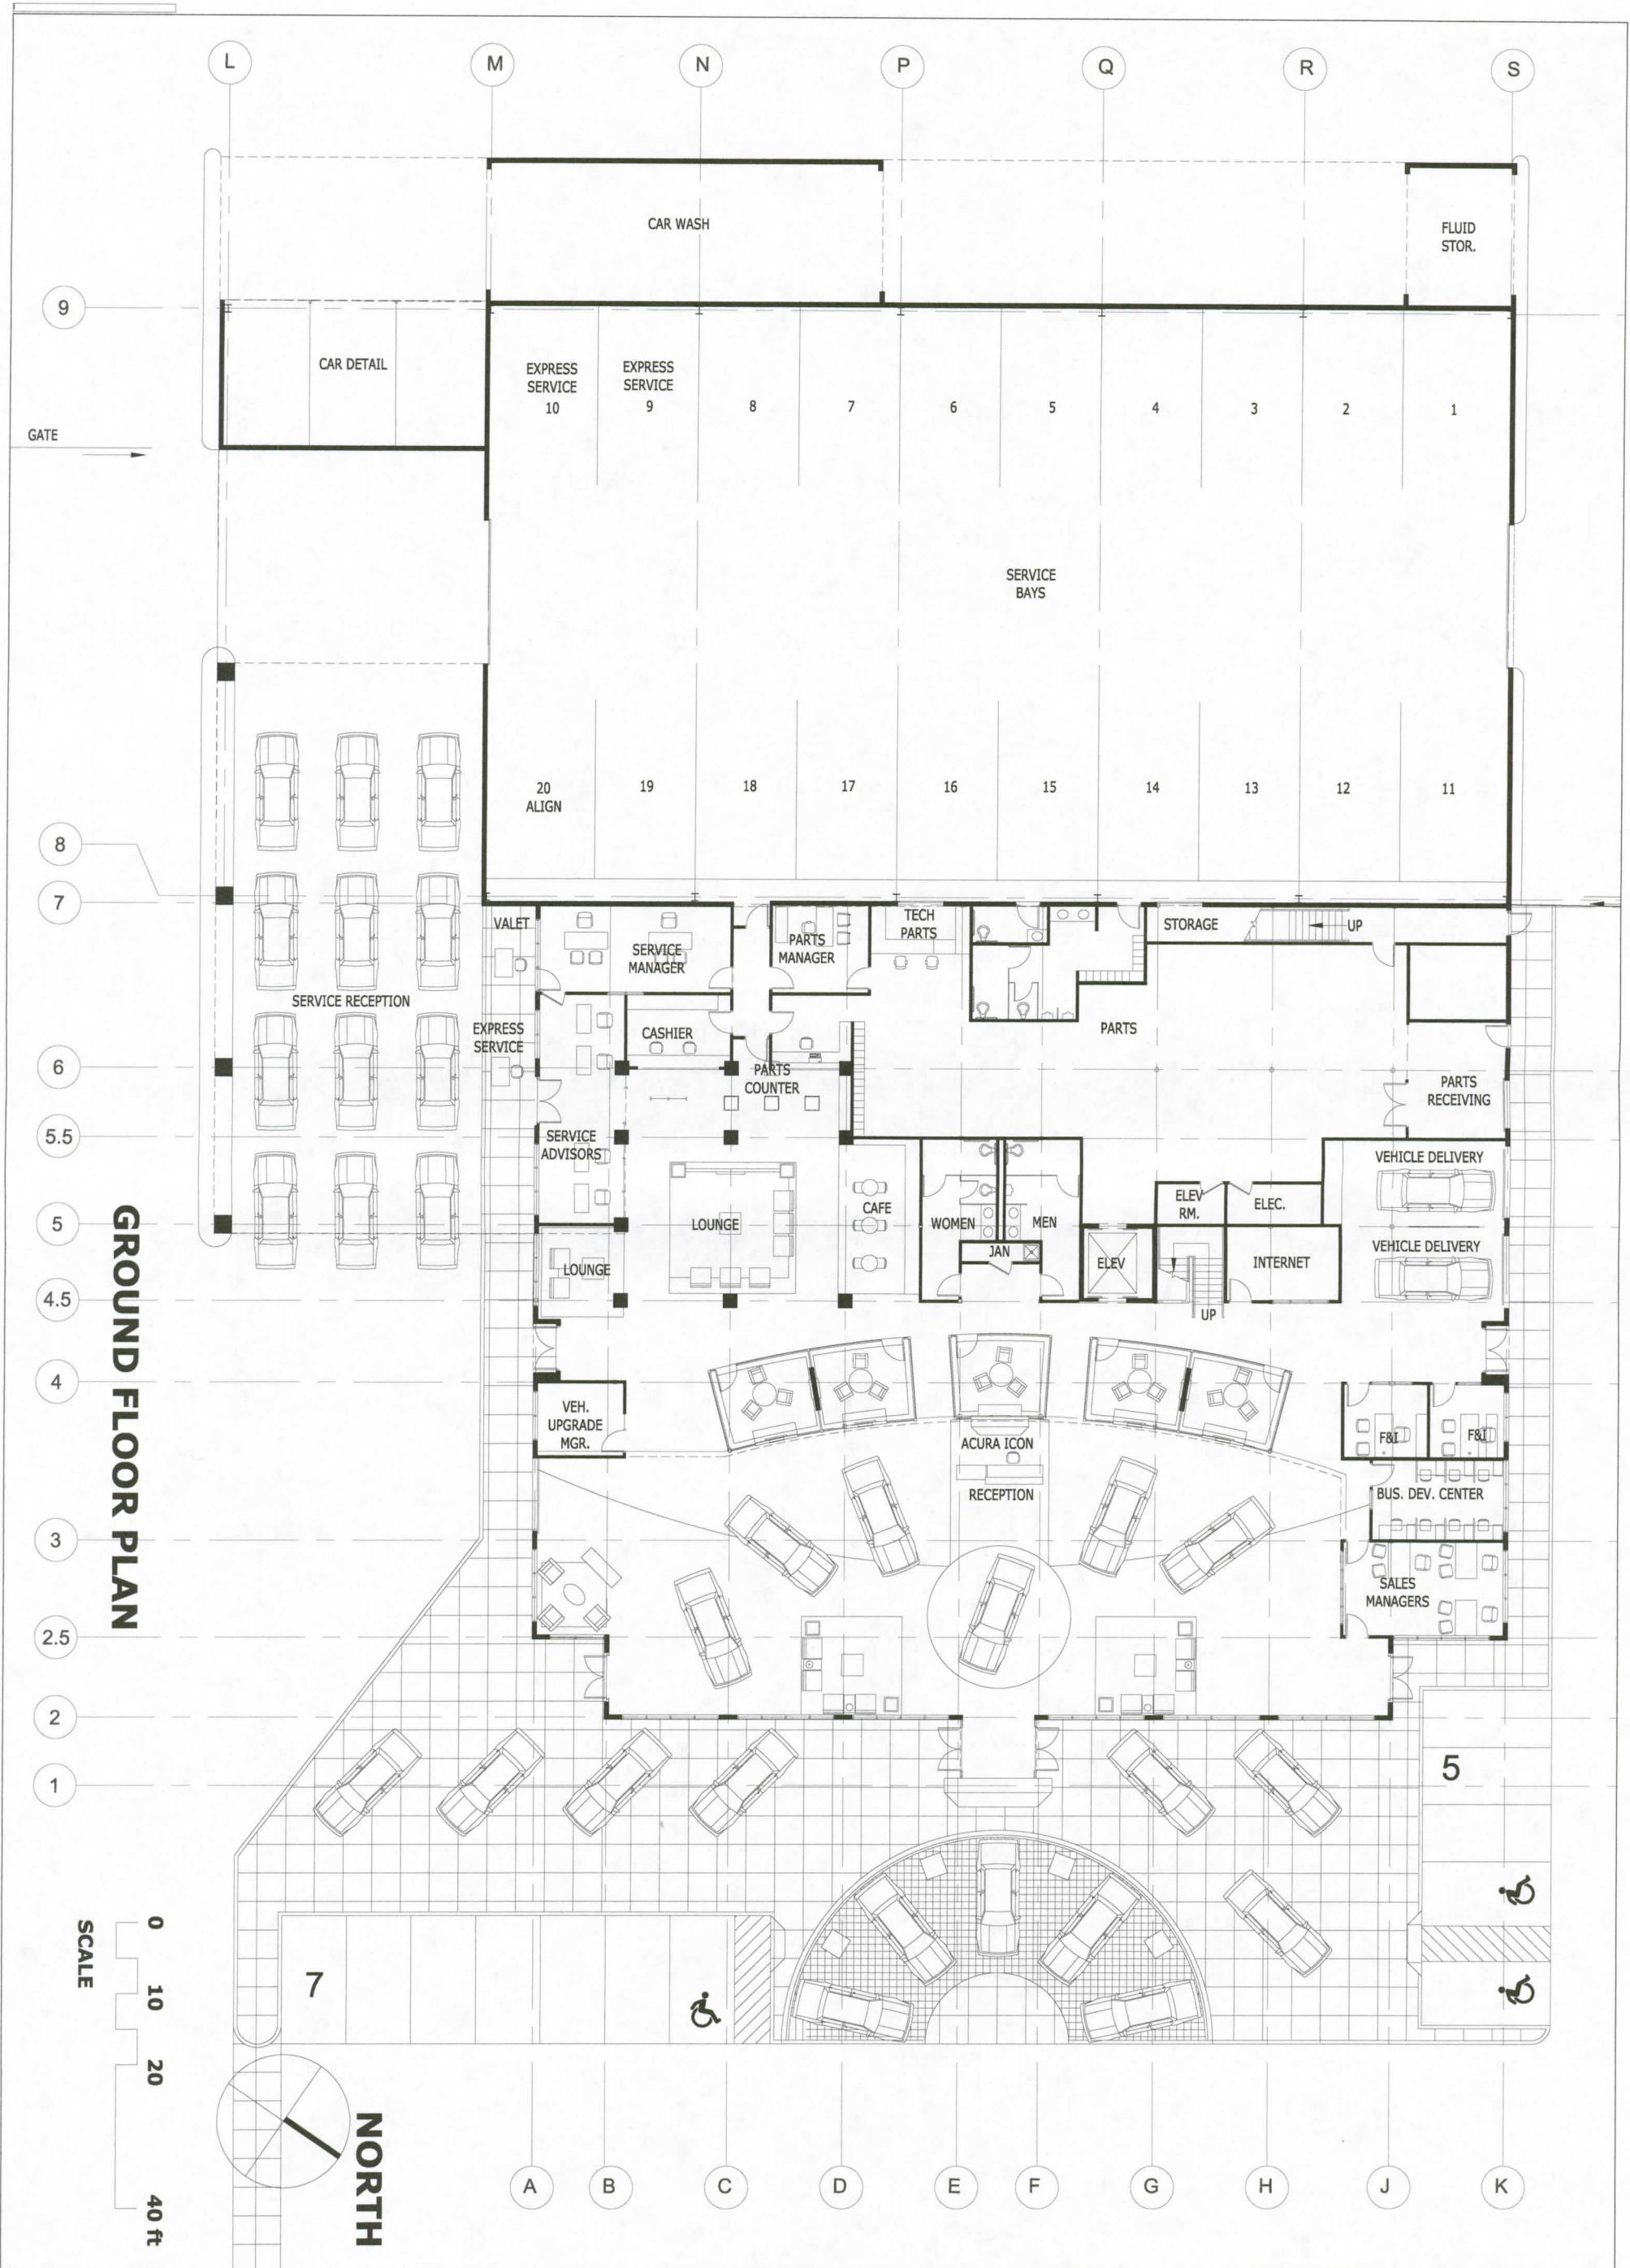

GROUND FLOOR PLAN

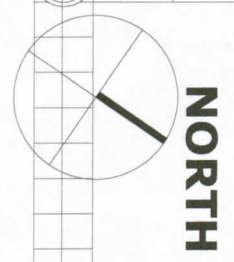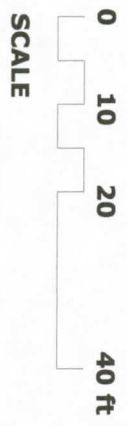

PROJECT NO.:
DRAWN BY:
SCALE: 1/4" = 1'-0"
SHEET TITLE:



STAMPS/APPROVALS
7101 Oakport Street
Oakland, CA 94621

PROJECT TITLE/ADDRESS:
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of Oakland


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A-2.0

GROUND FLOOR PLAN
SHEET NUMBER

ISSUE DATE
DEVELOPMENT REVIEW 05/11/2016



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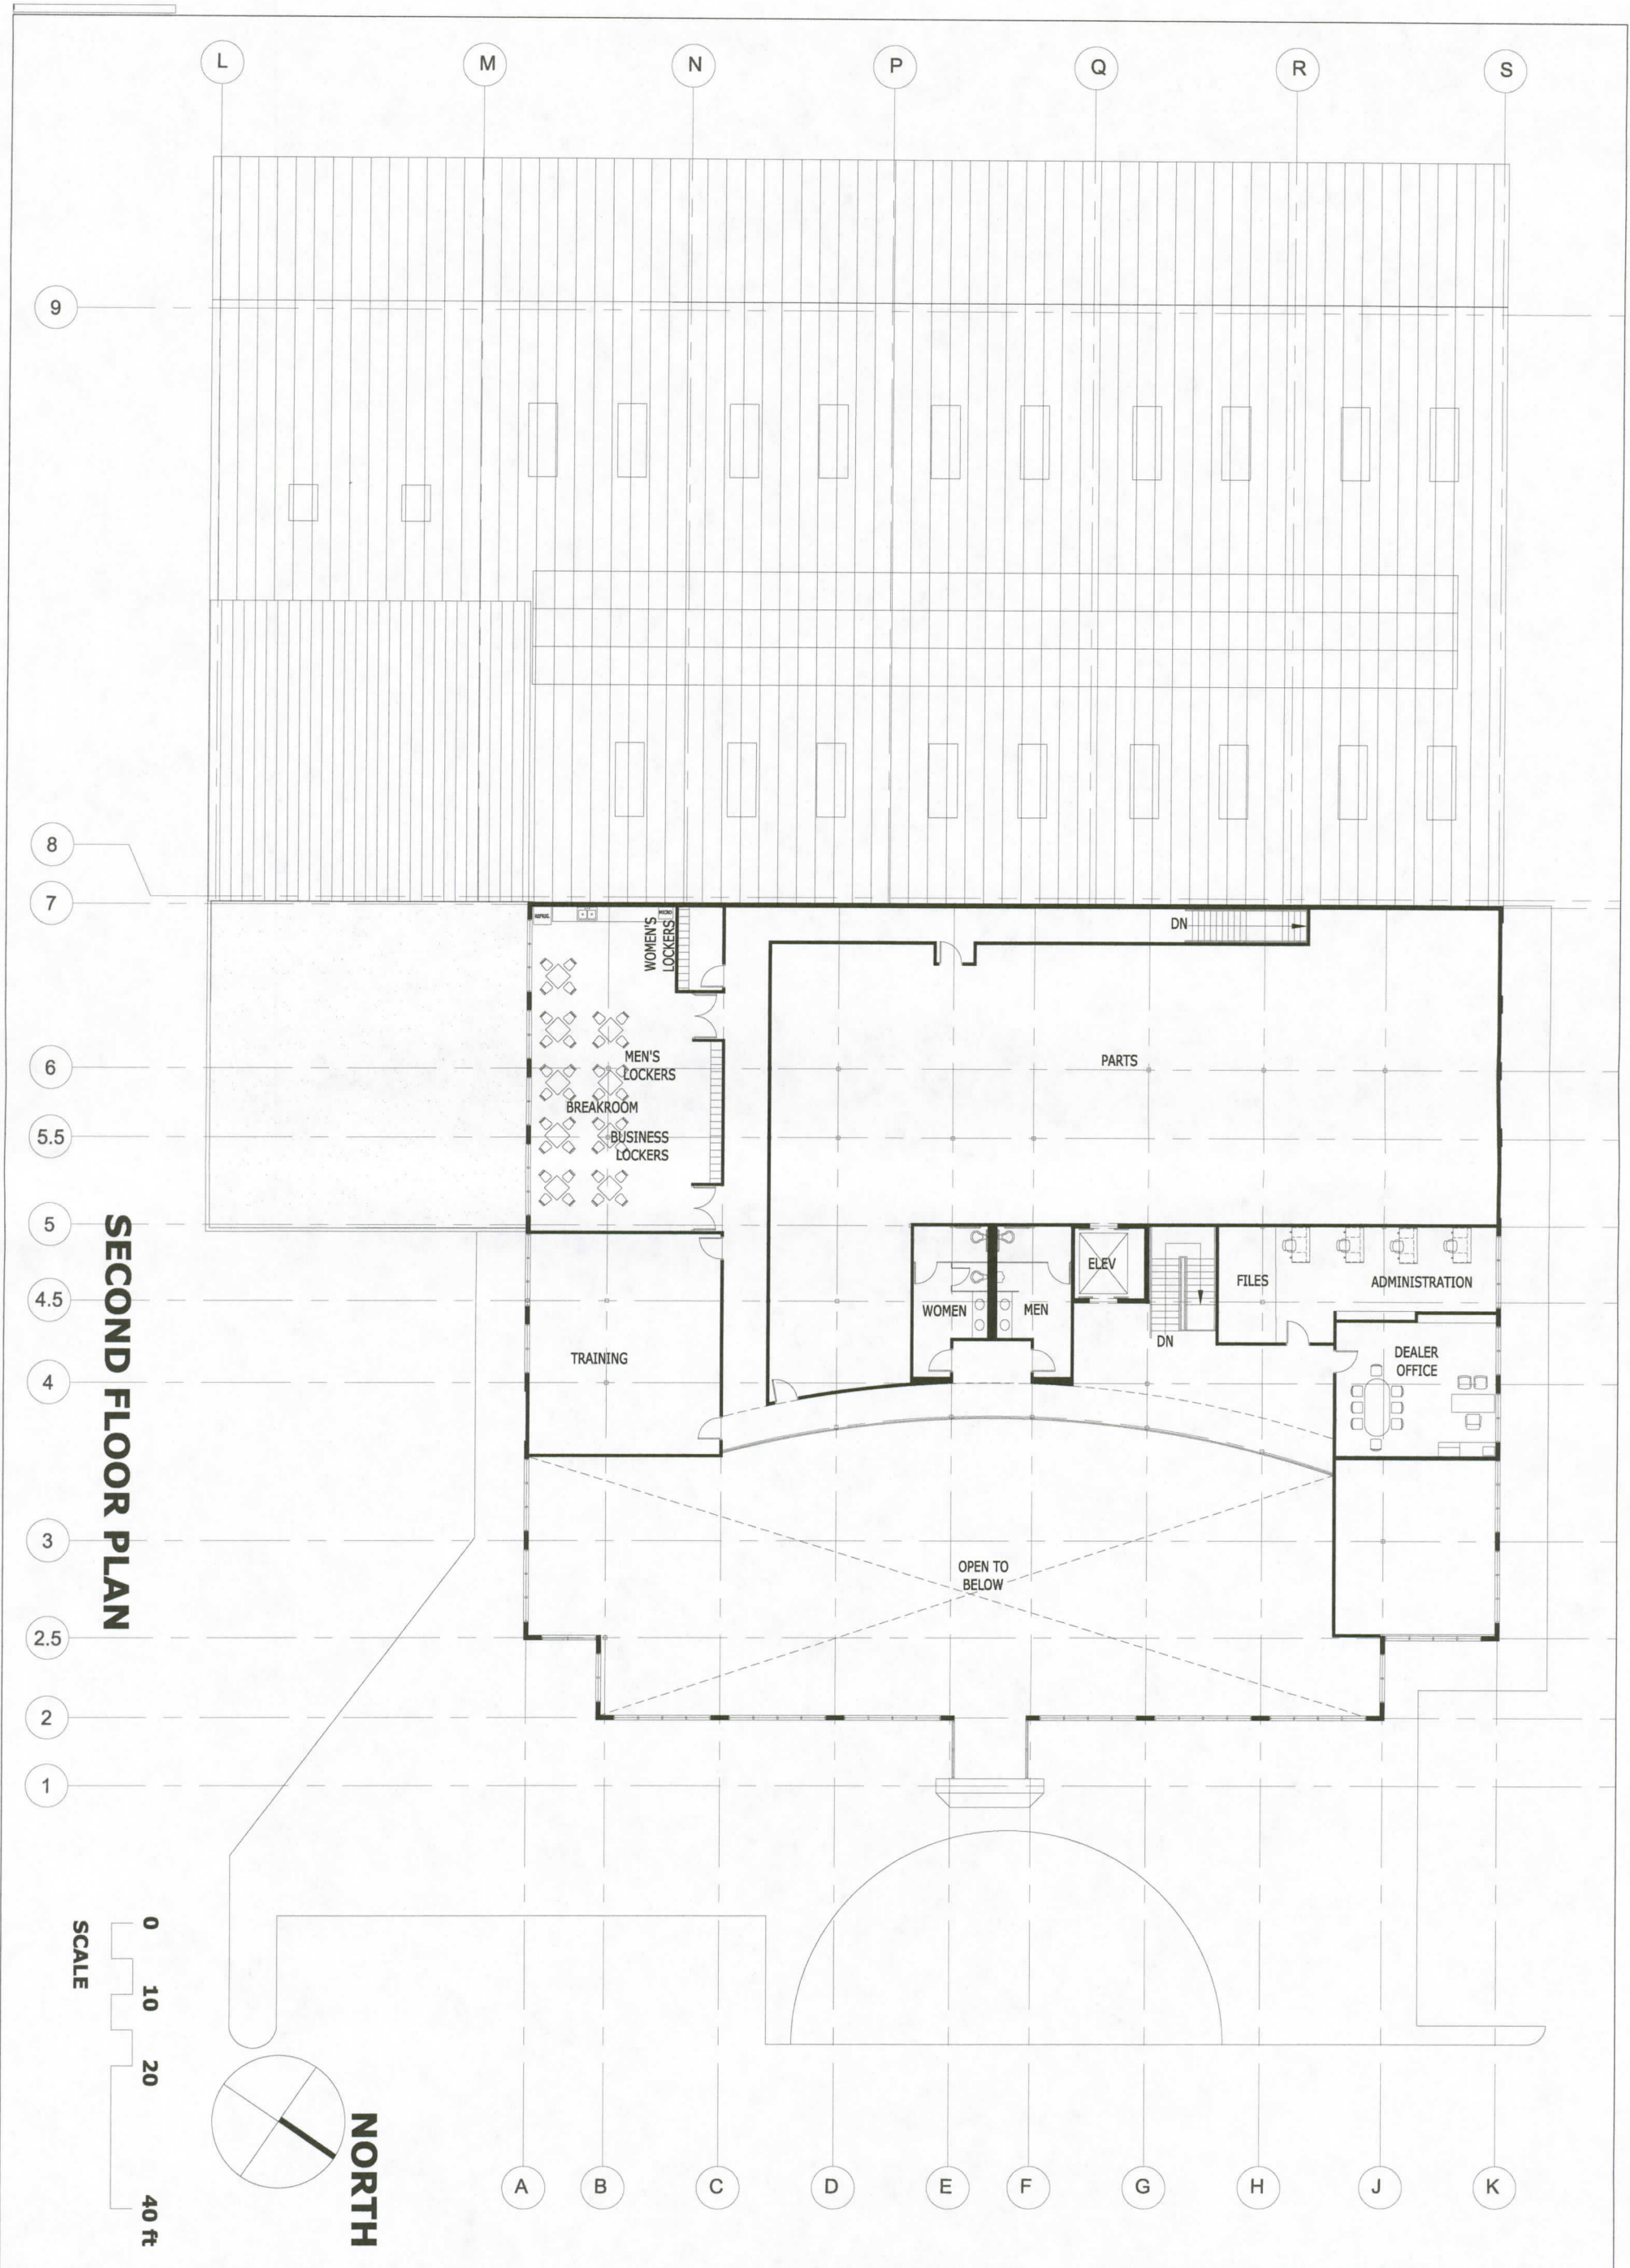
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6701 Oakport Street
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 STAMPS/APPROVALS

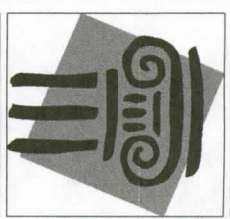

PROJECT NO.:
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 SHEET TITLE

SECOND FLOOR PLAN
 SHEET NUMBER
A-3.0




SECOND FLOOR PLAN



EAST ELEVATION



NORTH ELEVATION

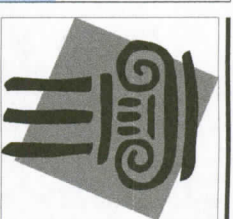

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ISSUE DATE
DEVELOPMENT REVIEW 06/11/2016



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ACURA
of Oakland

PROJECT TITLE/ADDRESS:

PROJECT NO.:
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SHEET TITLE

EAST AND NORTH
ELEVATIONS
SHEET NUMBER


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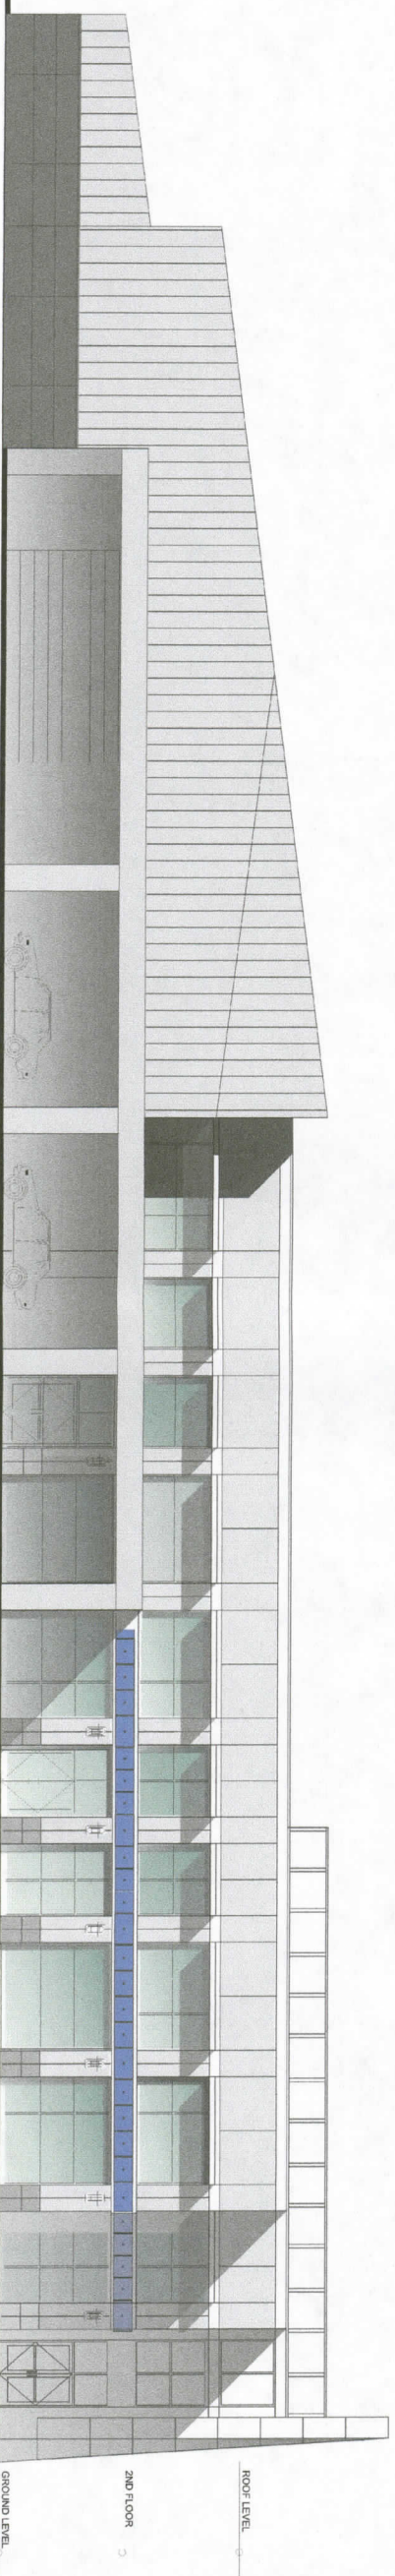
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ISSUE DATE
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WEST ELEVATION



SOUTH ELEVATION

PROJECT TITLE/ADDRESS:

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of Oakland

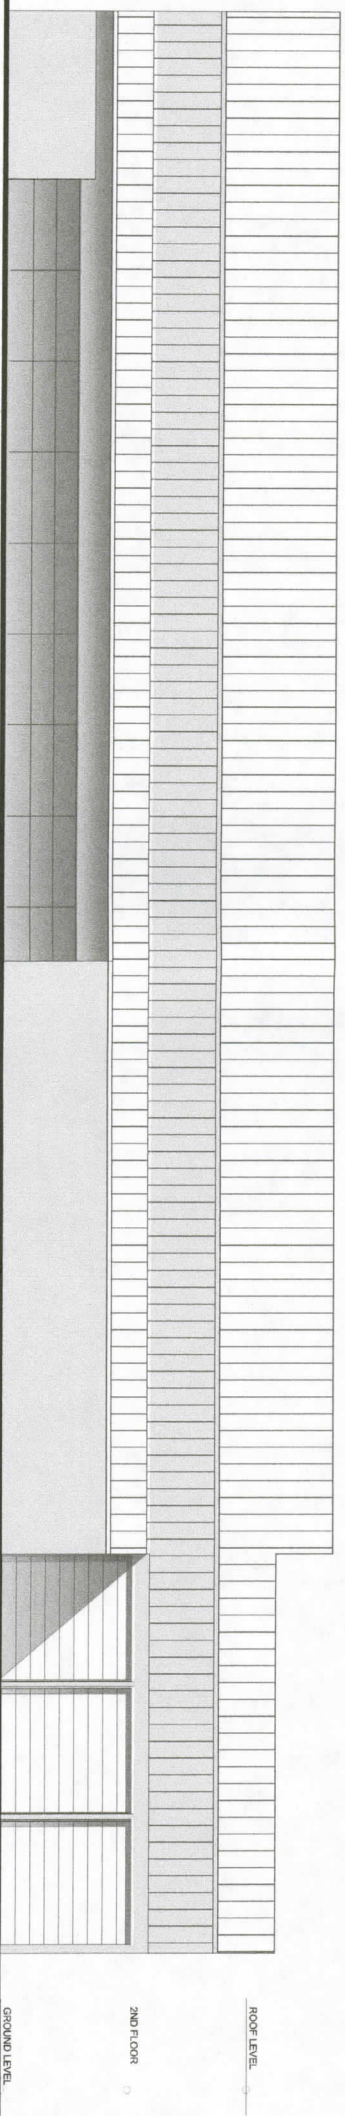6701 Oakport Street
Oakland, CA 94621

STAMPS/APPROVALS:



PROJECT NO.:

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SCALE: 1/8" = 1'-0"

SHEET TITLE

WEST AND SOUTH
ELEVATIONS

SHEET NUMBER


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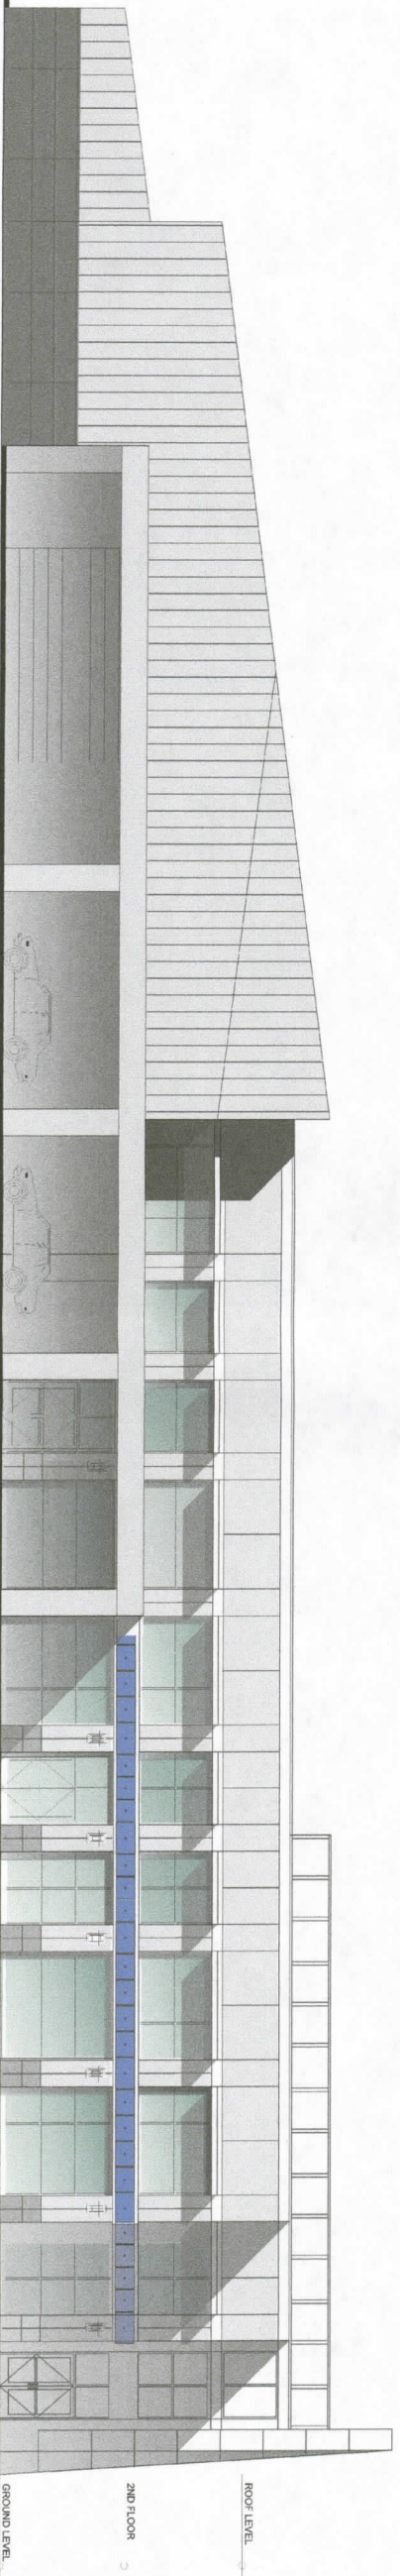
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WEST ELEVATION



SOUTH ELEVATION

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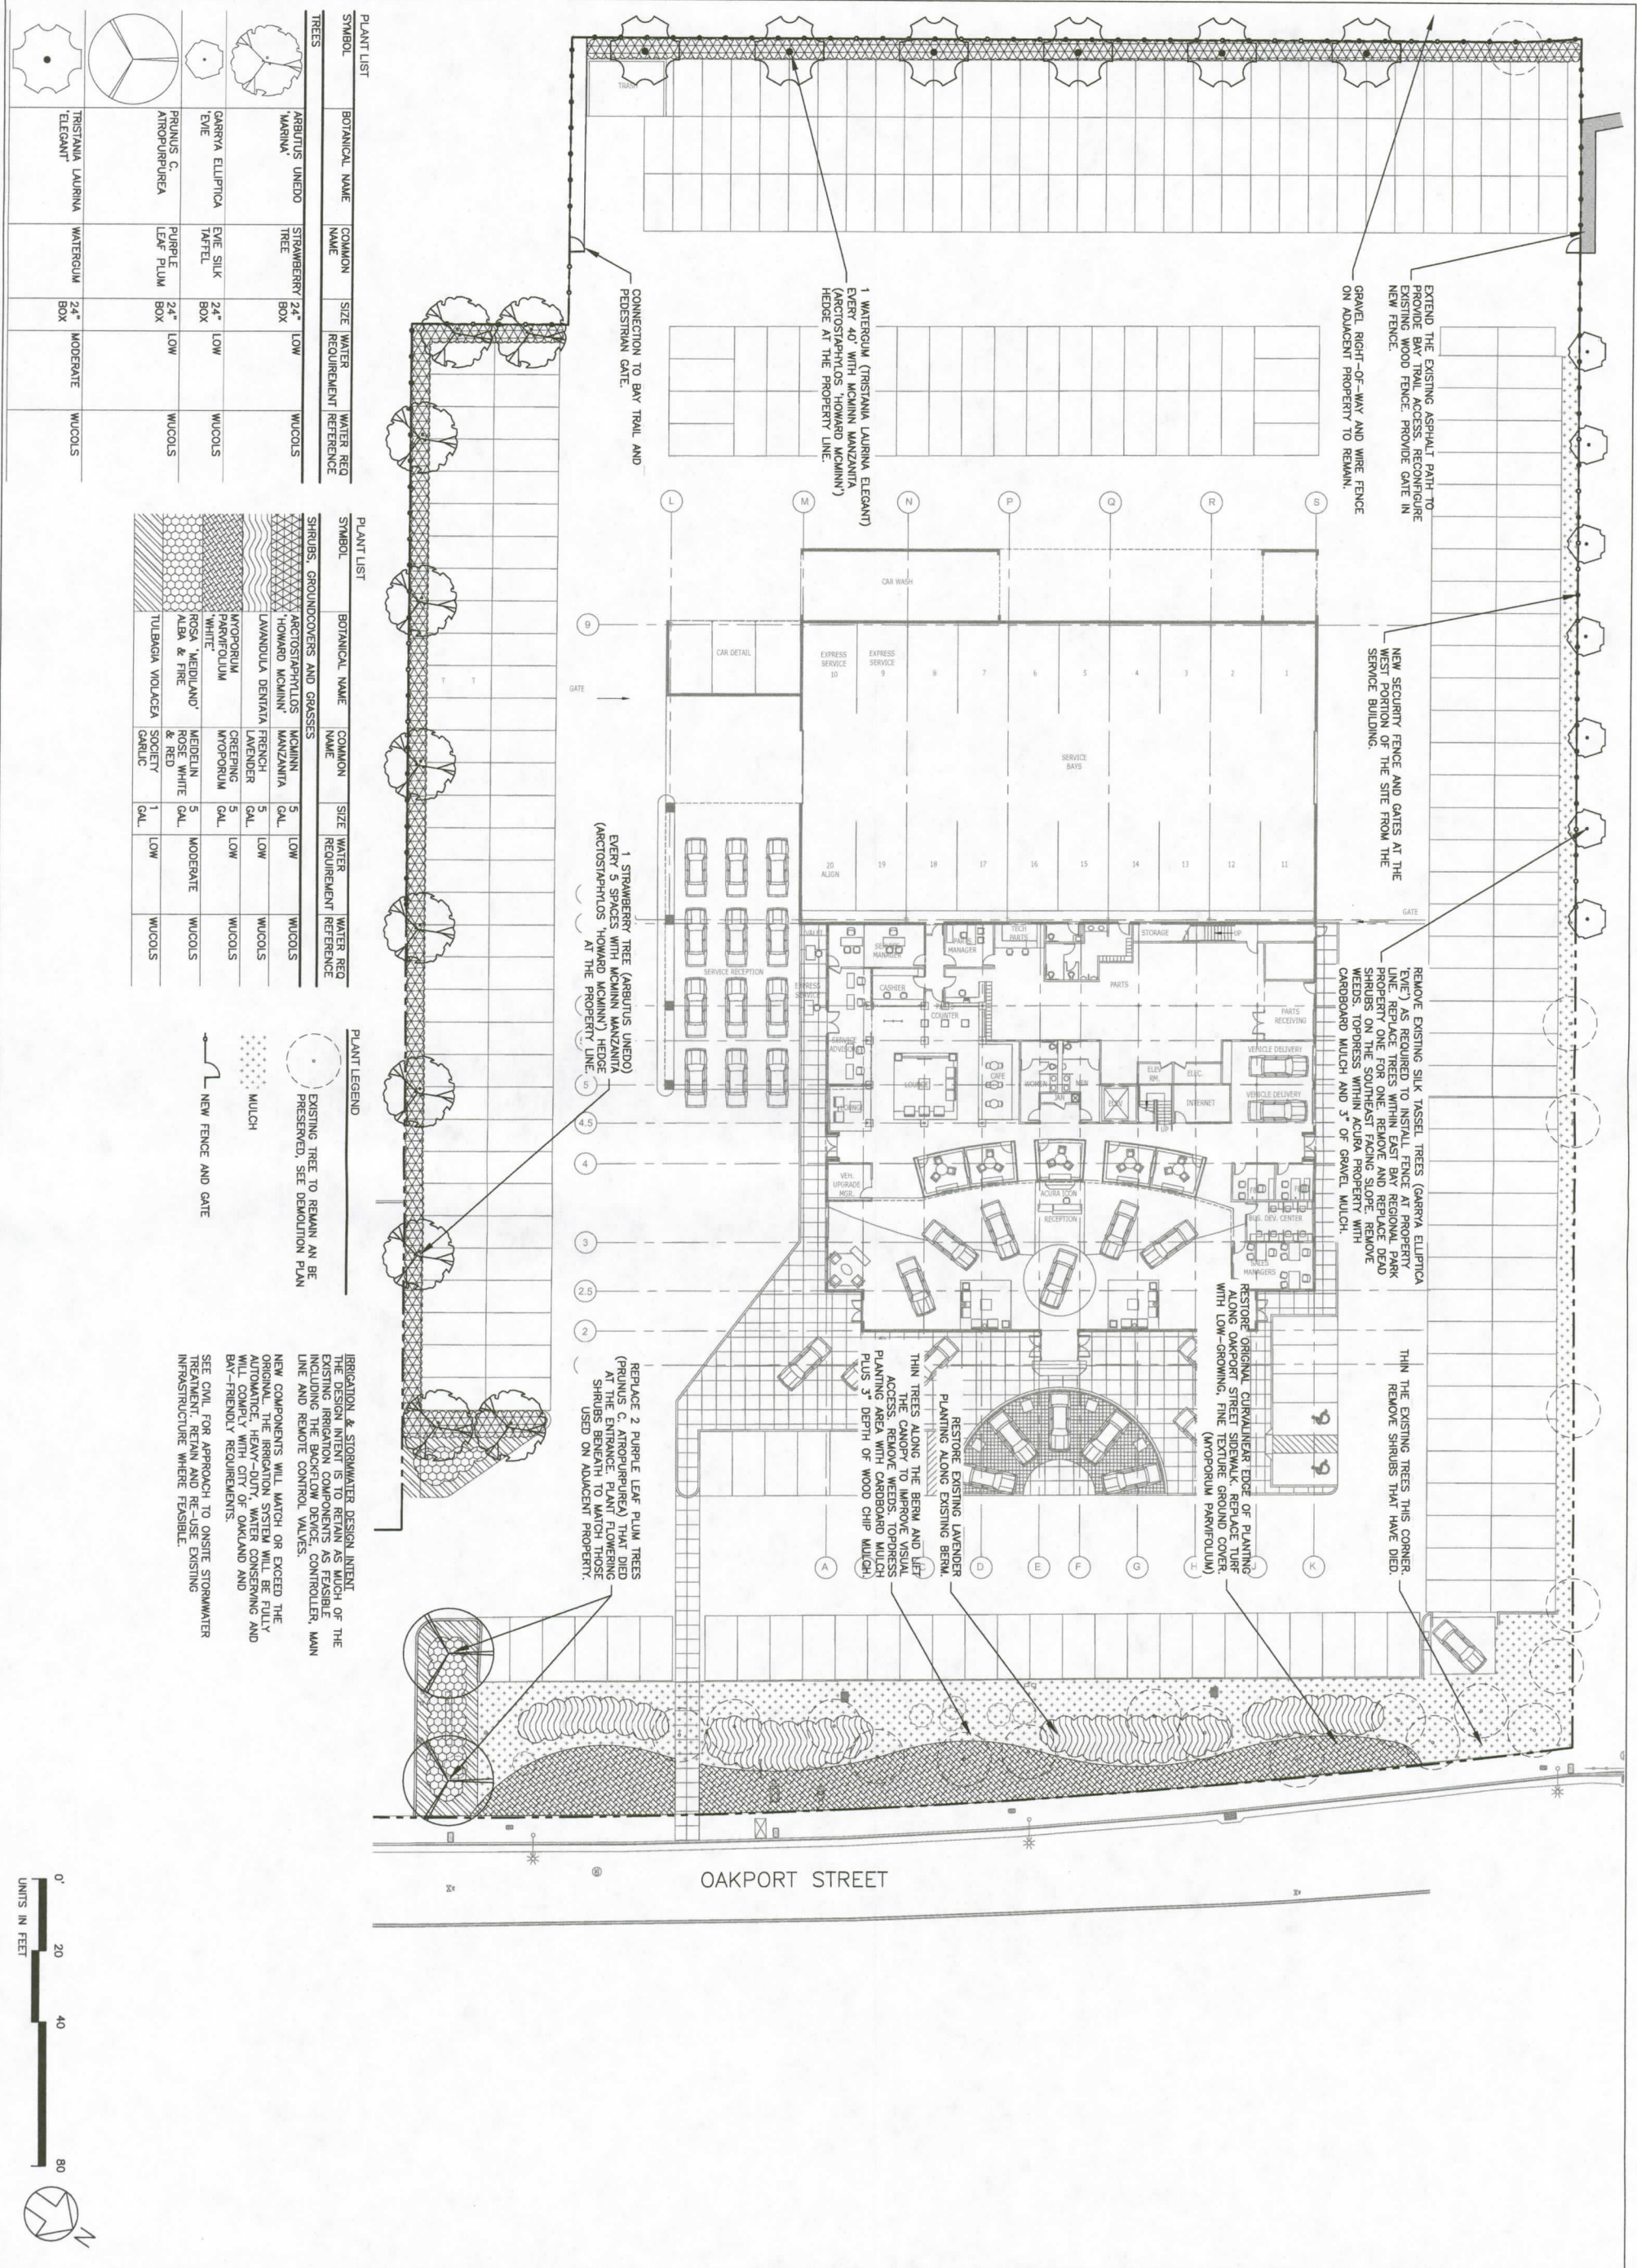
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WEST AND SOUTH
ELEVATIONS

SHEET NUMBER
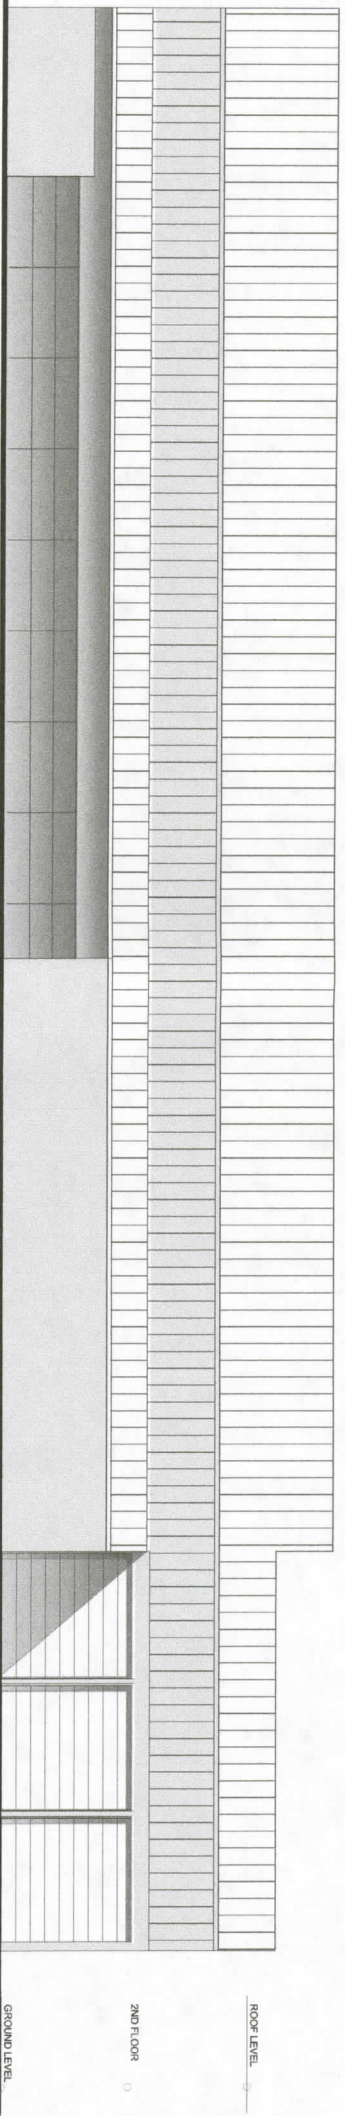
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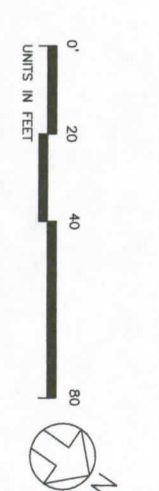


| TREES | | | |
|--------|------------------------|------------------|----------|
| SYMBOL | BOTANICAL NAME | COMMON NAME | SIZE |
| | ARGENTUS UNEDO | STRAWBERRY TREE | 24" BOX |
| | PRUNUS C. ATROPURPUREA | PURPLE LEAF PLUM | 24" BOX |
| | GARRA ELLIPTICA | SILK TAFFEL | 24" BOX |
| | TRISTANA LAURINA | WATERGLIM | 24" BOX |
| | | | MODERATE |
| | | | WILCOOLS |

| SHRUBS, GROUNDCOVERS AND GRASSES | | | |
|----------------------------------|------------------------|------------------|----------|
| SYMBOL | BOTANICAL NAME | COMMON NAME | SIZE |
| | ARGENTUS UNEDO | STRAWBERRY TREE | 24" BOX |
| | PRUNUS C. ATROPURPUREA | PURPLE LEAF PLUM | 24" BOX |
| | GARRA ELLIPTICA | SILK TAFFEL | 24" BOX |
| | TRISTANA LAURINA | WATERGLIM | 24" BOX |
| | | | MODERATE |
| | | | WILCOOLS |

| PLANT LEGEND | | | |
|--------------|---|--|--|
| | EXISTING TREE TO REMAIN AND BE PRESERVED, SEE DEMOLITION PLAN | | |
| | MULCH | | |
| | NEW FENCE AND GATE | | |

IRRIGATION & STORMWATER DESIGN INTENT
 THE DESIGN INTENT IS TO RETAIN AS MUCH OF THE EXISTING IRRIGATION SYSTEM AS FEASIBLE INCLUDING THE BACKFLOW PREVENTER, MAIN LINE AND REMOVE CONTROL VALVES.
 NEW COMPONENTS WILL MATCH OR EXCEED THE ORIGINAL. THE IRRIGATION SYSTEM WILL BE FULLY AUTOMATIC, HEAVY-DUTY, WATER CONSERVING AND BAY-FRIENDLY REQUIREMENTS.
 SEE CIVIL FOR APPROACH TO ONSITE STORMWATER TREATMENT, RETAIN AND RE-USE EXISTING INFRASTRUCTURE WHERE FEASIBLE.



| No. | Date | Description |
|-----|------|-------------|
| | | |
| | | |

LANDSCAPE PLAN

Date: 5/11/2016
 Scale: 1" = 20'
 Drawn: KF
 Check: CP
 Sheet: L1.0

ACURA OF OAKLAND

PGA design
 LANDSCAPE ARCHITECTS
 444 17th Street
 Oakland CA 94612
 T 510 465 1284
 F 510 465 1256

Client: _____
 Project Partners: _____
 Stamp: _____

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