Design Review Committee

Case File Number: PLN16-117 October 26, 2016

Location: 1433 Webster Street

(See map on reverse)

Assessor's Parcel Numbers: 008-0624-035-00; & -036-00

Proposal: Proposal to construct a new 28 story mixed use building

containing 176 residential units, approximately 55,000 square feet of office and 2,000 square feet of commercial at

the ground floor.

Applicant: Lih-Chuin Loh

Owners: Village Glenn Oakland 1, LLC

Planning Permits Required: Regular Design Review for new construction; Major

Conditional Use Permit for development exceeding 200,000

square feet; and Tentative Parcel Map to merge two lots and

merge adjacent property air rights.

General Plan: Central Business District

Zoning: CBD-P; Height Area 2 (85')

CBD-C; Height Area 7(no limit)

Environmental Determination: Determination Pending

Historic Status: Potentially Designated Historic Property (PDHP); Ratings:

359 15th Street - Ed2* & 363 15th Street - Dc2+ (15th &

Webster ASI)

Service Delivery District: Metro

City Council District:

For further information: Contact case planner Pete Vollmann at 510-238-6167 or by

email: pvollmann@oaklandnet.com

SUMMARY

The Nautilus Group has filed an application with the Bureau of Planning to develop a mixed use 28 story building that would include 176 dwelling units, approximately 55,000 square feet of office and 2,000 square feet of ground floor commercial.

Staff requests that the Design Review Committee receive public testimony and provide comments on the proposed design.

PROPERTY DESCRIPTION

The subject property consists of two lots on the southwest corner of Webster and 15th Streets, 1433 Webster Street and 359 15th Street, each of which contains an existing two story commercial building. The proposal also includes the western adjacent property at 363 15th Street, which will not be redeveloped as part of this proposal but will be retained while providing the air space merger into the adjacent development site as well as using allowable density from the lot.

CITY OF OAKLAND PLANNING COMMISSION



Case File: PLN16117

Applicant: Thor Hoskins

Address: 1433 Webster Street

Zone: CBD-P, CBD-C

Case File Number: PLN16-117 Page 3

363 15th Street and the corner property at 359 15th Street are located within the 15th & Webster Historic District, which is an Area of Secondary Importance (ASI). The property at 363 15th Street has a rating of Dc2+ and is a contributor to the district while the building at 359 15th Street is itself a contingency contributor to the district, meaning it may contribute if it were restored. The district consists of a mix of one to five story buildings, but with a very prominent tall one to two story height context along the south side of 15th Street. The tallest building in the district is the five story YWCA Building on the northwest corner of 15th & Webster Streets which is an A2+ rated building design by Julia Morgan.

PROJECT DESCRIPTION

The proposed project would demolish the two existing buildings and to construct a new mixed use development with 28 stories reaching up to approximately 350 feet in height. The ground floor of the proposal would contain approximately 2,00 square feet of retail and the residential entrance lobby on 15th Street with the office lobby located on Webster Street. The Webster Street frontage at the ground floor would also contain the garage entry and one loading berth. The parking entry leads to a mechanical parking system tucked to the back of the ground floor as well as a ramp to a subterranean level where additional mechanical parking systems would be provided. The mechanical parking systems at the ground and basement level would provide parking for 91 cars. The ground floor would also have an internally oriented bike storage and room and workshop for tenants of the building. Levels two through five in the building would be designated as office space totaling approximately 55,000 square feet, with the fifth floor having terraces open to the streets. The sixth floor with contain amenity spaces for the residents of the building with access out to a roof top outdoor open space. Large portions of this floor facing the street would be reserved for mechanical rooms for the building and would not be occupied floor area. Levels seven through 28 would be the residential floors in the building with eight units per floor for a total of 176 apartments, 44 of which would be one bedroom units and the remaining 132 as two bedroom units. The 29th level/ tower rooftop would contain an additional outdoor open space and amenity space.

ZONING ANALYSIS

The subject property is located within both the CBD-C and CBD-P Zones within Height Areas 7 and 2. The portion of the site on Webster Street (1433 Webster) is within the CBD-C Zone and Height Area 7. The portion of the site on 15th Street (359 & 363 15th Street) is within the CBD-P Zone and Height Area 2. The intent of the CBD-C Zone is to create, maintain, and enhance areas of the Central Business District appropriate for a wide range of ground-floor office and other commercial activities. Upper-story spaces are intended to be available for a wide range of residential and office or other commercial activities. The intent of the CBD-P Zone is to create, maintain, and enhance areas of the Central Business District for ground-level, pedestrian-oriented, active storefront uses. Upper story spaces are intended to be available for a wide range

Case File Number: PLN16-117

Page 4

of office and residential activities. The Height Area 7 does not set any restriction on building height above the 120 building base height and allows a density of one dwelling unit per 90 square feet of lot area and a Commercial FAR of 20.0. The Height Area 2 allows a maximum height of 85 feet above a 55 foot tall building base and allows one dwelling unit per 200 square feet of lot area with a commercial FAR of 6.0.

Density

The proposed development site would allow the following density based upon the Height Areas that it is located within as described in the table below:

Site	Area	Residential	Commercial	Max Units/
		Density	FAR	Floor Area
1433 Webster Street	9,750	1:90	20.0	108.3 / 195,000
359 15 th Street	6,146	1:200	6.0	30.7 / 36,876
363 15 th Street *	2,108	1:200	6.0	10.5 / 8,432
TOTAL	1		,	149 units
				240,308 sq.ft.

^{*363 15&}lt;sup>th</sup> Street is only calculated at 4.0 FAR since two existing stories of commercial are proposed to be retained.

Height

As mentioned above the subject development site is split by two different Height Areas. The portion of the site fronting onto 15th Street is within a Height Area 2 which allows a maximum building height of 85 feet, while the portion on Webster Street is within the Height Area 7 and does not set a maximum height above the 120 foot base height. Height Area 7 also requires that tower above the base height not exceed 85% of the site area to allow for a more slender tower. The proposed project complies with the Height Area 7 regulations with regard to height and tower coverage, but exceeds the height allowances of Height Area 2 by extending the full 353 foot tall tower above the 85 feet within Area 2. The applicant has requested a Density Bonus Concession pursuant to Planning Code Section 17.107.080 to allow a waiver of this height restriction as part of providing affordable housing within the development project. The Planning Code also allows for a 30 foot encroachment of the adjacent Height Area into the Height Area 2 by 30 feet pursuant to Section 17.154.060.C as part of the Design Review process, so the height waiver through the density bonus process would be for the additional approximately 35 feet into the Height Area 2 out to 15th Street.

DENSITY BONUS FOR AFFORDABLE HOUSING

The applicant has proposed as part of their development proposal to include affordable units within the project in order to take advantage of a density bonus and concessions pursuant to Planning Code Section 17.107. The applicant proposes to include 5% of the 149 baseline allowed

Case File Number: PLN16-117 Page 5

dwelling units at Very Low Income (less than 50% of Median Income) resulting in 8 affordable units. This allows for a Density Bonus of 20% above the baseline number of 149 units resulting in a maximum density of 179 dwelling units on the site.

In addition to the bonus in density allowed on-site the applicant is also able to take advantage of one density bonus concession/incentive that would relax other Zoning Regulations. The applicant has requested that the Bureau of Planning waive the height regulations within the Height Area 2 of a maximum height of 85 feet to allow the full extent of the tower to extend up to 353 feet in height.

DESIGN REVIEW

Staff requests that the Design Review Committee review the proposed development project and provide comments and/or design recommendations to the applicant and staff prior to the proposal moving forward to the full Planning Commission.

Staff has the following concerns, comments and/or recommendations on the proposed design:

15th Street Setback

The proposed development contains a zero setback along 15th Street, which while appropriate at the ground level, could provide an additional setback or other design treatment to soften the transition from the adjacent two story context. This also seems appropriate given that the site is located within the 15th & Webster Historic District and 15th Street contains a two story context. As noted above the applicant has requested a density bonus concession to relieve the project from the height limitations of Height Area 2 along 15th Street, but that doesn't preclude the City from requesting other design related elements to address the two story context, which wouldn't inherently need to disallow an increase over the height limit as requested.

Tower Façade

The south and north elevations of the proposed tower contain large expanses of blank walls above the sixth floor of the building including only a central break for glazing and other vertical recesses in the aluminum paneling. Staff feels that these facades should incorporate more glazing and other treatments to provide visual interest to the tower, which would also help to articulate the boxy form of the building.

The other tower facades on the east and west elevations could also use more articulation to provide more visual interest since the tall vertical lines that are used to break up the mass of the façade seem to enhance the overall boxy form of the building. These facades could also use some inclusion of balcony recesses to better identify the building as a residential tower.

Case File Number: PLN16-117 Page 6

In addition, the rooftop feature includes six boxed in "enclosures", which again reinforces this overall box feeling to the building, and the rooftop component could include something that provides more visual interest to the tower as seen from a distance as part of the skyline.

Exterior Materials

The tower would be clad in a black aluminum paneling system, which would provide a very dark appearance to the building. This would especially cause the building to stand out within the context of the skyline as this is a very different color than the other buildings within the skyline which are more of a lighter masonry or aluminum paneling or for more recent office buildings a more reflective glass. Staff requests feedback from the Committee as to the appropriateness of the exterior color of the building within the context of the skyline.

The sixth floor of the building also contains large louvers for the mechanical systems within the building. Staff recommends that these either be better concealed or that more creative design treatments are provided to better incorporate this element into the balcony recess break at this portion of the building.

RECOMMENDATION

Staff recommends that the Committee review the proposed project for appropriate site and building design considerations and provide direction to staff and the project applicant prior to full consideration by the City Planning Commission.

Prepared by:

PETERSON Z. VOLLMANN

Planner IV

Approved:

ROBERT MERKAMP

Development Projects Manager

Attachments:

A. Project Plans

1433 WEBSTER STREET

ARCHITECT OF RECORD

AGENCY APPROVALS

	ISSUE RECORD	
No.	Description	Date
001	ZONING PRE-APPLICATION	2-10-2016
002	BASIC APPLICATION FOR DEV. REVIEW	4-22-2016
003	BASIC APPLICATION FOR DEV. REVIEW	7-22-2016
004	BASIC APPLICATION FOR DEV. REVIEW	9-15-2016
005	BASIC APPLICATION FOR DESIGN REVIEW	10-12-2016

1433 Webster Ave.

Oakland, CA 94609

RAD BUILD P.O. Box 70975 Oakland, CA 94612 Tel: 510.343.5593

NEMO Building Systems, LLC 18231 Muprhy Pkwy Lathrop, CA 95330

TITLE SHEET

RAD Project Number 12, OCT 2016

A0.1



SHEET INDEX

Sheet	Drawing	Scale	Submittal 1
DBO IEC	T INFORMATION & SITE PLAN		
A0.1	Title Sheet	NTS	X
A0.2 Project Data		NTS	X
A0.3	Density Bonus	NTS	X
A0.4	Existing Condition Photos	NTS	X
A0.5	Existing Condition Photos	NTS	X
A0.6	Demolition Plan	3/32"=1'-0"	Х
A0.7	Site Plan	1/16"=1'-0"	X

CIVIL			
C0.0	Topographic Survey	1"=20'-0"	X
C1.0	Stormwater Management	1"=10'-0"	Х
C2.0	Tree Exhibit	N.T.S	Х

LANDS	CAPE DESIGN		
L1.0	Level 1 Plan	3/32"=1'-0"	Х
L1.1	Level 2 Plan	3/32"=1'-0"	Х
L1.2	Roof Plan	3/32"=1'-0"	Х

Oncot	Branning	Oddic	Oubilittai	
ARCHITE	CTURAL			
A1.3	Level P1	3/32"=1'-0"	X	
A1.4	Level 1	3/32"=1'-0"	Х	
41.5	Level 2-4	3/32"=1'-0"	X	
A1.6	Level 5	3/32"=1'-0"	Х	
1.7	Level 6	3/32"=1'-0"	X	
1.8	Level 7-28	3/32"=1'-0"	Х	
1.9	level 29	3/32"=1'-0"	X	
1.10	Roof Plan	3/32"=1'-0"	X	
41.11	Unit Plan	1/4"=1'-0"	Х	
			-	
42.0	Building Elevation	1/16"=1'-0"	Х	
A2.1	Building Elevation	1/16"=1'-0"	Х	
A2.2	Sign & Light Plan	NTS	X	
43.0	Building Section	1/16"=1'-0"	Х	
7		-	'	
BUILDING	MASSING AND RENDERINGS		Sai Lond Than	
44.1	Perspective Rendering	N.T.S	X	
44.2	Perspective Rendering	N.T.S	Х	
44.3	Perspective Rendering	N.T.S	X	
4.4	Perspective Rendering	N.T.S		
44.5	Perspective Rendering	N.T.S	X	



PROJECT INFORMATION: PLANNING

ADDRESS:

1433 Webster Street, Oakland, CA (Cross Street: 15th)

ZONING SUMMARY: 1433 Webster St: Parcel Number 008 062403600 Lot Area = 9,750 sf

Lot Dimensions 150' x 65' Zoning District CBD-C (Commercial Zone)

Height Limit No Limit (CBD- Height Area 7) Max Height Base 120'. Max FAR 20.0

Residential Density 90 sf of lot area required

per unit

LOT 1433 Webster Street contains an

existing 2 story Business building with 100% lot coverage. This building is to be

LOT 359 15th Street contains an existing 2 story Business building with 100% lot coverage. This building

Lot Area 6,147 sf

359 15Th St: Parcel Number: 008 062403500

Lot Dimensions 87.5' x 70.25' Zoning District CBD-P(Commercial Zone)

Max FAR 6.0 (non-residential FAR)
Residential Density 200 sf of lot area required

MAXIMUM FAR

LOT AREA

FAR

TOTAL 20 195,000 36,876

12,648

Height Limit 85' (CBD Height Area 2)

is to be demolished...

PROJECT DESCRIPTION:

EXISTING SITE

CONDITION:

New 176-Unit- 29 STORY High Rise Residential/Mixed-use building with one level subterranean parking, 1,300 SF of ground floor retail and an above grade podium containing 60,000 SF office use. This is a Covered Apartment Residential Building per 1102A.1,2 (Flat-Level, Multi-Family), Fully Automatic Sprinkled. The airspace rights of lot 363 15th street are

included in the project property.

HEIGHT:

The project contains a residential tower with a height of 353.5 feet facing the street frontage of Webster St. The project steps down to a 77 foot podium with office use and residential garden at the projects rear.

OCCUPANCY: CONSTRUCTION:

R-2 Multi-Residential, S-2 Garage, M-Mercantile, B-Business, A3-Assembly, A-2 Restaurant

A podium is proposed at 100% lot coverage for a height of 77 feet.

BULK:

The tower rises to a height of 353.5 feet with a lot coverage of 74% (85% allowed in Height Zone 7)

ALLOWABLE DENSITY:

MAXIMUI	M DWELLING	UNIT DENSIT	Υ
LOT	LOT AREA	RESIDENTIAL DENSITY	ALLOWABLE UNITS
1433 WEBSTER	9,750	90	108
359 15th ST	6,146	200	30
363 15th St (TDR)	2,108	200	8
TOTAL	18,004		146
Density Bonus for Providing 5% very Low Income Units = 20%		1.20	176***

PER OMC 17.107.040 (F) FRACTIONAL DENSITY BONUS CALCULATIONS ARE ROUNDED UP

PROPOSED UNIT COUNT AND GROSS BUILDING AREA

								Unit Co	unt + Floor	Area					
							INC	LUDED IN F	FLOOR AREA (PL	ANNING)					
HEIGHT	FLOOR TO FLOOR	LEVEL		BED 60 SF	2 BED 1260 SF	TOTAL UNITS	LOBBY/ AMENITY/ MAIL	RETAIL	OFFICE NET RENTABLE	FLOOR AREA PER OMC	GROUP OPEN SPACE	PRIVATE OPEN SPACE	TOTAL OPEN SPACE	PARKING (INCLUDE RAMP)	PARKIN
353.5	0	ROOF													
340.0	13.5	MECH								347	5500		5500		
317.0 303.5	23 13.50	29 28	_	2	6	8	2077			2,077 10,505	6600		6600 0		
293.5	10.00	27		2	6	8				10,505		0	0	_	
283.5	10.00	26	_	- 2	6	8				10,505		320	320	_	
273.5	10.00	25	+	2	6	8				10,505	-	0	0	_	
263.5	10.00	24		2	6	8				10,505		320	320	_	
253.5	10.00	23	1	2	6	- 8				10,505		0	0		
243.5	10.00	22		2	6	8				10,505		320	320		
233.5	10.00	21	_	2	6	8				10,505		0	0		
223.5	10.00	20	1	2	6	8				10,505		320	320		
213.5	10.00	19	+	2	6	8				10,505		0	0		
203.5	10.00	18	_	2	6	8				10,505		320	320		
193.5	10.00	17	_	2	6	8				10,505		0	0		
183.5	10.00	16	_	2	5	8				10,505		320	320		
173.5	10.00	15		2	6	8				10,505		0	0		
163.5	10.00	14		2	6	8				10,505		320	320		
153.5	10.00	13		2	6	8				10,505		0	0	-	
143.5	10.00	12		2	6	8				10,505		320	320		
133.5	10.00	11		2	6	8				10,505		0	0		
123.5	10.00	10		2	6	8				10,505		320	320		
113.5	10.00	9		2	6	8				10,505		0	0		
103.5	10.00	8		2	6	8				10,505		320	320		
93.5	10.00	7		2	6	8				10,505		0	0		
77.0	16.50	6		0	0	0	3,060			10,649	3,720	-	3720		
63.0	14.00	5		0	0	0			13,222	14,602	2,120		0		
49.0	14.00	4		0	0	0			13,222	14,602			0		
35.0	14.00	3	\top	0	0	0			13,222	14,602			0		
21.0	14.00	2		0	0	0			13,222	14,602			0		
11.0	10.00	Mez		0	0	0		482		482			0		
0.0	11.00	1		0	0	0	1,876	1,482	2,381	5,739			0	7,796	
-14.5	-14.50	P1		0	0	0				1,005			0	15,457	
	TOTAL			44	132	176	7,013	1,964	55,269	309,817	10,320	3,200	13,520	23,253	

		REQUIRED				PI	ROPOSEI	D		
VEHICLE PARKING:	Residential (17.116.060(A))	1 space per unit 1 x 176 units- 176		Туре	Compact 7'-6" x 15'	Intermediate 8' x 16'-6"	Standard 8'-6" x 18'	HC 9' x 18'	Total	
		1 x 176 utilits- 176	Level 1	3 level stacker			38	0	38	1

		Level P1	2 level puzzle
rcial .080(B))	none		

		REC	UIRED	PROPOSED	
		Long Term	Short Term	Long Term	Short Term
BICYCLE PARKING:	Residential (17.117.110(9))	44 Spaces (1 per 4 Units)	9 Spaces (1 per 20 Units)	44	9
	Commercial (OFFICE) (17.117.090(4.B)	6 Spaces	3 Spaces	6	3
	Commercial (RETAIL) (17.117.090(4.B)	2 Spaces	2 Spaces	2	2
	Total	E2	4.4	50	

.0010 Cubic yard per Unit

			REQUIRED RATIO	REQUIRED LOOSE	PROPOSED COMPACTED
	RESIDENTIAL	Residential Recycle (Ordinance No. 11807) 2 Cubic ft per Unit (2x176=352 C.F)		13 cubic yards	
	RECYCLE AND TRASH	Commercial Recycle (Ordinance No. 11807)	2 Cubic ft per 1,000 sf	0.148 cubic yards	20% compaction ratio = 2.62 cubic yards (2- 2.3 yd bins)
		Residential Trash (Section 8.28.140,)	4.3 Cubic ft per Unit (4.3x176=757 C.F)	28 cubic yards	
1		Commosoial			20% compaction ratio = 6 cubic yards (3-2.3 yd bins)

1.875 cubic yards

OFFICE RECYCLE	Office Recycle (Ordinance No. 11807)		3- 1 cu. yrd bins		
AND TRASH	Office Trash (Ordinance No. 11807)	.0272 lbs, sf, wk	3- 1 cu. yrd bins	4 to 1 ratio (2- 1 cu, yrd. bins)	

75 SF per unit (176 x 75 = 13,200 sf)

(American Trash Manag.)

Commer


Total Private: 20 private decks (80 sf x 2=160) x 20 =3,200 sf Total group proposed= 10,320 sf (no dimension less than 15 feet)

PROPOSED


REQUIRED


Total Provided: 13,520 sf

All group open space to have 50% planted area

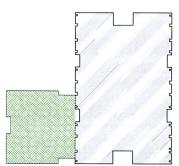

OPEN SPACE:

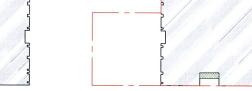

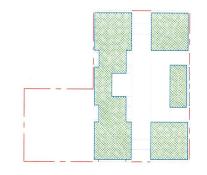

LEVEL 6: COMMON OUTDOOR DECK: 3,720 SF

TYPICAL RESIDENTIAL FLOOR BALCONY: 80 SF X 2 = 160 (X2) 320 SF PER FLOOR

LEVEL 29: SKYDECK: 6,600 SF



RAD BUILD P.O. Box 70975 , Oakland, CA 94612 Tel: 510.343.5593

OWNER

VILLAGE GLENN OAKLAND 1, LLC P.O. Box 70975, OAKLAND, CA 94612 L 510,343,5593

GENERAL CONTRACTOR

RAD BUILD P.O. Box 70975, CAKLAND, CA 94612 1, 510,343,5593

ARCHITECT OF RECORD

RAD BUILD P.O. Box 70975, OAKLAND, CA 94612 1 510 343 5593

PROJECT DESIGN

AGENCY APPROVALS

PLAN CHECK #

ISSUE RECORD No. Description

001 ZONING PRE-APPLICATION
 902
 BASIC APPLICATION FOR DEV. REVIEW
 4-22-2015

 903
 BASIC APPLICATION FOR DEV. REVIEW
 7-22-2016
 904 BASIC APPLICATION FOR DEV. REVIEW 9-15-2016 805 BASIC APPLICATION FOR DESIGN REVIEW

1433 Webster Ave.

Oakland, CA 94609

RAD BUILD P.O. Box 70975 Oakland, CA 94612 Tel: 510.343.5593

NEMO Building Systems, LLC 18231 Muprhy Pkwy Lathrop, CA 95330


PROJECT DATA

RAD Project Number 0001 Date 12, OCT 2016 SDG

DENSITY BONUS SUMMARY (see project manual for full density bonus narrative) City of Oakland municipal code chapter 17.107: table 17.107.02: density bonus for providing units for very low income households. This project proposes 5% very low income units which allows 20% density bonus.

Concorsions:

This project requests an increase from the 85'-0" maximum building height limit applicable to the lot at 359 15th Street to a maximum building height of 360'-0" as its one concession provided by the California Density Bonus Law.

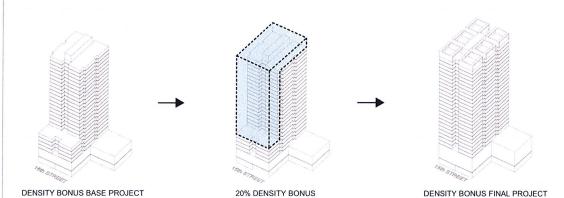

CONCESSIONS 1

**Note: To accommodate the 20% increase in units the project requests a concession from the city to increase the maximum height limit from 85 feet to 360 feet at lot 359 15th street.

MAXIMUM DWELLING UNIT DENSITY							
гот	LOT AREA	RESIDENTIAL DENSITY	ALLOWABLE UNITS				
1433 WEBSTER	9,750	90	108				
359 15th ST	6,146	200	30				
363 15th St (TDR)	2,108	200	8				
TOTAL	18,004		146				
Density Bonus for Providing 5% very Low Income Units = 20%		1.20	176***				

MAXIMUM FAR						
LOT AREA	FAR	TOTAL				
9,750	20	195,000				
6,146	6	36,876				
2,108	6	12,648				
TOTAL		244,524				


^{***}PER OMC 17.107.040 (F) FRACTIONAL DENSITY BONUS CALCULATIONS ARE ROUNDED UP***


1433 V	NEBSTER	STREET: DEN	SITY BONUS	BASE PROJECT

Note: Base	project assumes (1) 85' height limi	t at 359 15th street (2) total heigh	ht under 250' (3) Gross Bui	lding SF is under 200,000 sf (4)	The total units is 146.
Note: Base	e project assumes (1) 85' height limi	t at 359 15th street (2) total heigh	ht under 250' (3) Gross Bui	liding SF is under 200,000 sf (4)	The total units is 146.

				INCLUE	DED IN GR	OSS BUILD	DING AR	A (PLANNI	NG)			BUILDING EF	FICIENCY	EXCLUD	ED FRO	OM GRO	OSS BUILD	ING AREA(PLANNING)
HEIGHT	FLOOR TO FLOOR	LEVEL	1 BED 860 SF	2 BED 1260 SI	TOTAL UNITS	AMENITY		LOADING/ TRASH/ MECH	RETAIL	FLOOR AREA PER OMC	NON-RES. FAR	BUILDING NET	EFF.	PARKING		PRIVAT E OPEN SPACE	GROUP OPEN SPACE	TOTAL OPEN SPACE	PARKING SPACES
249	10	ROOF	-			-									-	-	5,475	5,475	
239	10	23	2	4	6					8,100		6,464	80%					0	
229	10	22	2	4	6					8,100		6,464	80%					0	
219	10	21	2	4	6					8,100		6,464	80%					0	
209	10	20	2	4	6					8,100		6,464	80%					0	
199	10	19	2	4	6					8,100		6,464	80%					0	
189	10	18	2	4	6					8,100		6,464	80%					0	
179	10	17	2	4	6	1				8,100		6,464	80%					0	
169	10	16	2	4	6					8,100		6,464	80%					0	
159	10	15	2	4	6					8,100		6,464	80%					0	
149	10	14	2	4	6					8,100		6,464	80%					0	
139	10	13	2	4	6					8,100		6,464	80%					0	
129	10	12	. 2	4	6					8,100		6,464	80%					0	
119	10	11	2	4	6					8,100		6,464	80%					0	
109	10	10	5	2	7					8,100		6,464	80%					0	
99	10	9	5	2	7					8,100		6,464	80%					0	
89	10	8	5	2	7					8,100		6,464	80%					0	
79	10	7	5	2	7					8,100		6,464	80%				1,800	1,800	
69	10	6	2	8	10					11,230		9,100	81%					0	
59	10	5	2	8	10					11,230		9,100	81%					0	
49	10	4	2	8	10					11,230		9,100	81%					0	
39	10	3	2	8	10					11,230		9,100	81%				. 4,100	4,100	
14	25	2	0	0	0					0	0			11,000				0	81
0	14	1	0	0	0		3,500	1,000	1,600	6,100	1,600	-		6,210	\perp				51
			1 1			1 1						1 1		1 1	2	0			1

BASE PROJECT DATA 1

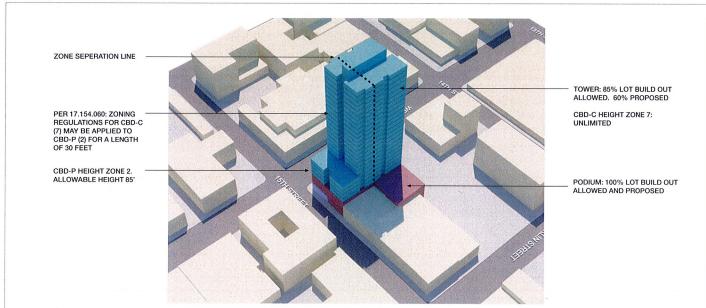

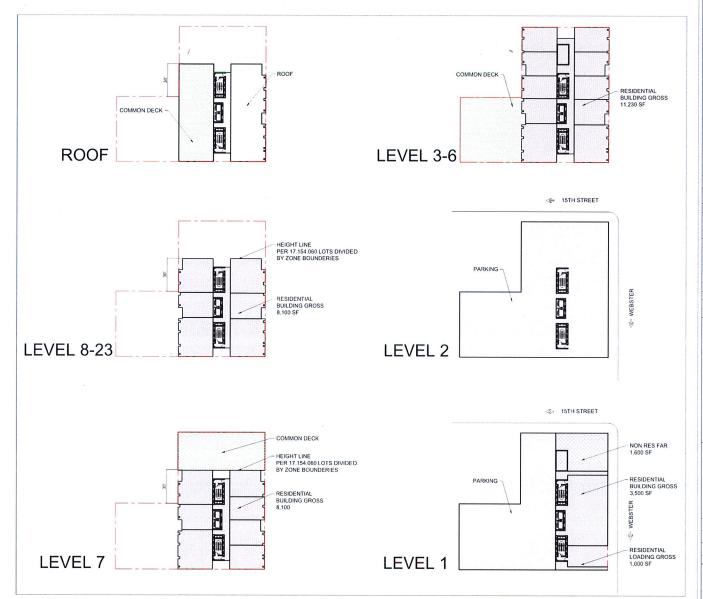

BASE PROJECT PLAN



RAD BUILD P.O. Box 70975 , Oakland, CA 94612

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OWNER

VILLAGE GLENN OAKLAND 1, LLC P.O. Box 70975, OAKLAND, CA 94612

GENERAL CONTRACTOR

RAD BUILD P.O. Box 70975, OAKLAND, CA 94612 1, 510 343 5593

ARCHITECT OF RECORD

RAD BUILD

PROJECT DESIGN

RAD DESIGN/ SDG 230 E. OHIO ST. SUITE 4

CIVIL

SANDIS CIVIL ENGINEERS SURVEY 636 9TH STREET. OAKLAND, CA 94607

AGENCY APPROVALS

PLAN CHECK#

ISSUE RECORD

ZONING PRE-APPLICATION BASIC APPLICATION FOR DEV. REVIEW	2-10-2016 4-22-2016
BASIC APPLICATION FOR DEV. REVIEW	4-22-2016
BASIC APPLICATION FOR DEV. REVIEW	7-22-2016
BASIC APPLICATION FOR DEV. REVIEW	9-15-2016
BASIC APPLICATION FOR DESIGN REVIEW	10-12-2016

1433 Webster Ave.

Oakland, CA 94609

RAD BUILD P.O. Box 70975 Oakland, CA 94612 Tel: 510.343.5593

NEMO Building Systems, LLC 18231 Muprhy Pkwy Lathrop, CA 95330

DENSITY BONUS BASE PROJECT

 RAD Project Number
 0001

 Date
 12, OCT 2016

 Drawn by
 SDG

A0.3


NTS









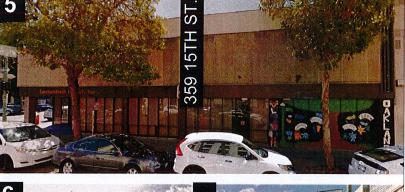





SIDE



FRONT

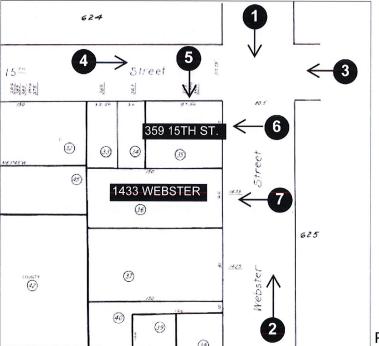


PHOTO LOCATION

SITE PHOTOGRAPHY: PROJECT SITE



ARCHITECT OF RECORD

PROJECT DESIGN

AGENCY APPROVALS

PLAN CHECK #

No.	Description	Date		
001	ZONING PRE-APPLICATION	2-10-2016		
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003	BASIC APPLICATION FOR DEV. REVIEW	7-22-2016		
004	BASIC APPLICATION FOR DEV. REVIEW	9-15-2016		
005	BASIC APPLICATION FOR DESIGN REVIEW	10-12-2016		

1433 Webster Ave.

Oakland, CA 94609

RAD BUILD P.O. Box 70975 Oakland, CA 94612 Tel: 510.343.5593

NEMO Building Systems, LLC 18231 Muprhy Pkwy Lathrop, CA 95330

EXISTING CONDITION

RAD Project Number Date 12, OCT 2016

NTS

0001

,SAME, SIDE OF PROJECT SITE: 15TH STREET



359 15TH STREET

(PROJECT SITE)



363 15TH STREET 369 15TH STREET

377-389 15TH STREET

SAME SIDE OF PROJECT SITE: WEBSTER STREET



PARKING LOT

PARKING LOT

1433 WEBSTER STREET (PROJECT SITE)

359 15TH STREET (PROJECT SITE)

YWCA

1523 WEBSTER

ACROSS FROM PROJECT SITE: 15TH STREET









330 15TH STREET

336 15TH STREET

ACROSS FROM PROJECT SITE: WEBSTER STREET











330 15TH STREET

1438 15TH STREET

1410 WEBSTER

340 14TH STREET

NTS

SITE PHOTOGRAPHY: ADJACENT BUILDINGS

AGENCY APPROVALS

ISSUE RECORD

GENERAL CONTRACTOR

ARCHITECT OF RECORD RAD BUILD P.O. Box 70975, OAKLAND, CA 94612 1, 510,343,5593

PROJECT DESIGN

PLAN CHECK #

1433 Webster Ave.


Oakland, CA 94609

RAD BUILD P.O. Box 70975 Oakland, CA 94612 Tel: 510.343.5593

NEMO Building Systems, LLC 18231 Muprhy Pkwy Lathrop, CA 95330

EXISTING CONDITION

RAD Project Number 0001 12, OCT 2016 Drawn by

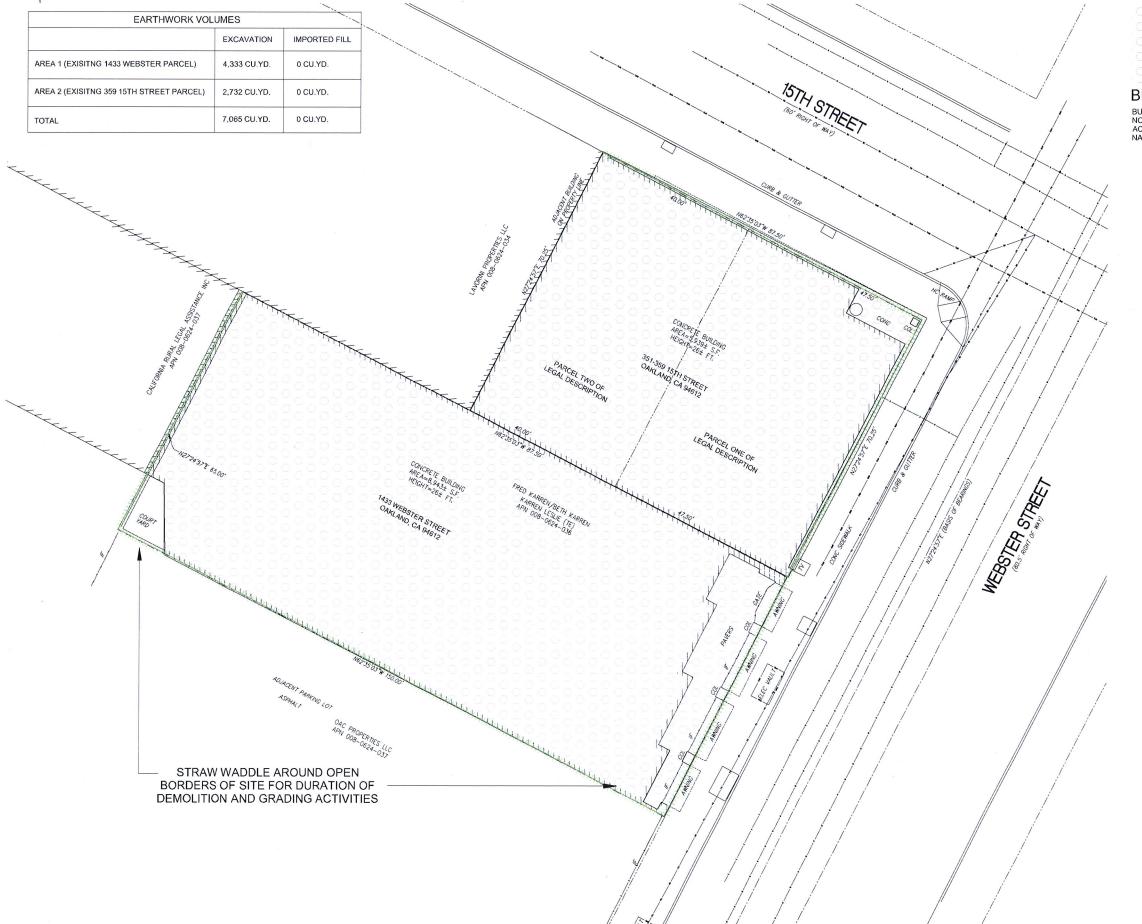



BUILDING DEMO

BUILDINGS SHOWN FOR DEMOLITION ARE NON-HISTORIC RESOURCES IN ACCORDANCE WITH THE LOCAL AND NATIONAL REGISTRIES.

RAD BUILD P.O. Box 70975 , Oakland, CA 94612 Tel: 510.343.5593

VILLAGE GLENN OAKLAND 1, LLC P.O. Box 70975, OAKLAND, CA 94612 L 510.343.5593

GENERAL CONTRACTOR

ARCHITECT OF RECORD RAD BUILD P.O. Box 70975, OAKLAND, CA 94612 1, 510,343,5593

PROJECT DESIGN

AGENCY APPROVALS

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ISSUE RECORD

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1433 Webster Ave.

Oakland, CA 94609


RAD BUILD P.O. Box 70975 Oakland, CA 94612 Tel: 510.343.5593

NEMO Building Systems, LLC 18231 Muprhy Pkwy Lathrop, CA 95330

DEMO PLAN

	RAD Project Number	000
	Date	12, OCT 201
	Drawn by	SDO
- 1		

3/32" = 1'-0"

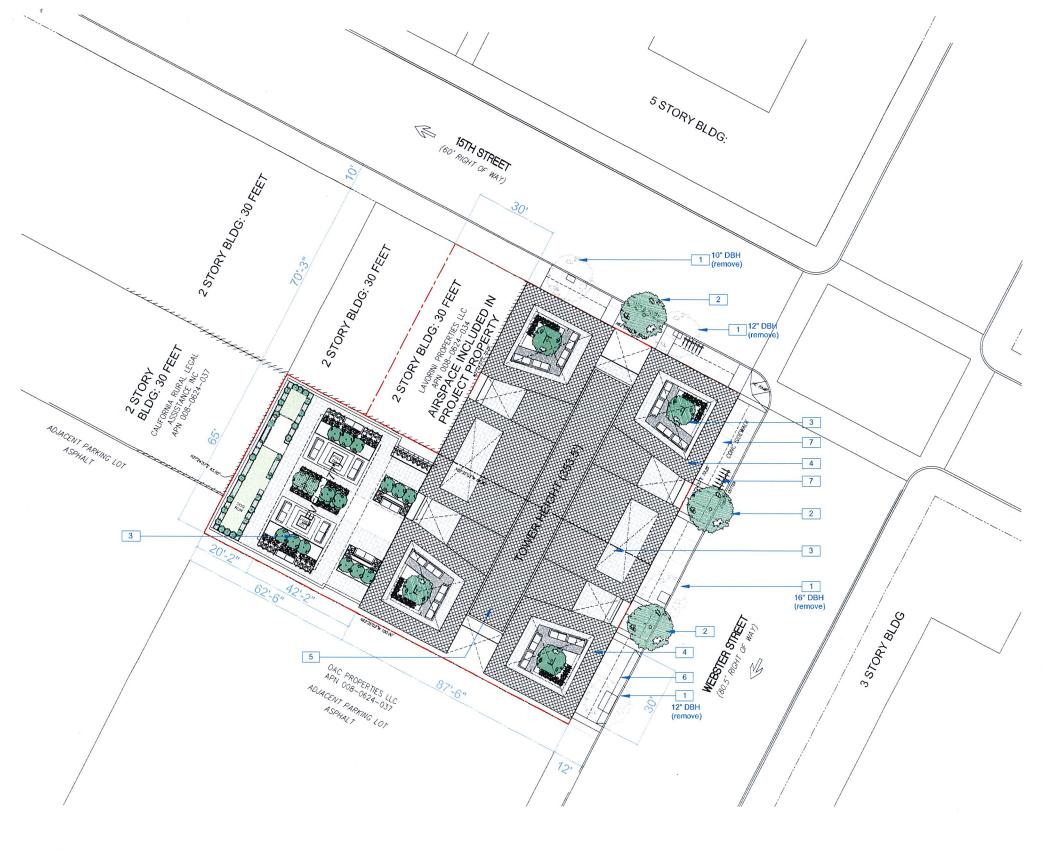

NOTATION KEY

- 1 STREET TREE TO BE REMOVED
- 2 NEW STREET TREE
- 3 GROUP OPEN SPACE
- 4 ROOF SUNSHADE: 15 FEET ABOVE ROOF
- 5 MECHANICAL PENTHOUSE
- 6 30 FOOT CITY STANDARD CURB CUT
- 7 CANOPY ENCROACHING 5 FEET BEYOND PROPERTY LINE.
- 7 SHORT TERM BIKE PARKING

SPECIAL NOTES

GROUP OPEN SPACE

LEVEL 6: 3,720 SF ROOF: 6,600 SF

PRIVATE OPEN SPACE

20 BALCONIES: 80 SF X 2 X 20= 3,200

TOTAL OPEN SPACE

13,520 SF



SITE PLAN



RAD BUILD P.O. Box 70975 , Oakland, CA 94612 Tel: 510.343.5593

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OWNER

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GENERAL CONTRACTOR

RAD BUILD P.O. Box 70975, OAKLAND, CA 94612 L 510.343 5593

ARCHITECT OF RECORD

RAD BUILD P.O. Box 70975, OAKLAND, CA 94612 1, 510,343 5593

PROJECT DESIGN

RAD DESIGN/ SDG

1. 510.450

ANDIS CIVIL ENGINEERS SUI

AGENCY APPROVALS

PLAN CHECK

ISSUE RECORD

 No.
 Description
 Date

 001
 ZONING PREAPPLICATION
 2-10-2016

 002
 BASIC APPLICATION FOR DEV. REVIEW
 4-22-2016

 003
 BASIC APPLICATION FOR DEV. REVIEW
 9-15-2016

 004
 BASIC APPLICATION FOR DESIGN REVIEW
 9-15-2016

 005
 BASIC APPLICATION FOR DESIGN REVIEW
 10-12-2016

1433 Webster Ave.

Oakland, CA 94609

RAD BUILD P.O. Box 70975 Oakland, CA 94612 Tel: 510.343.5593

NEMO Building Systems, LLC 18231 Muprhy Pkwy Lathrop, CA 95330

SITE PLAN

 RAD Project Number
 0001


 Date
 12, OCT 2016

 Drawn by
 SDG

A0.7

1/16" = 1'-0"

FOUND CITY MONUMENT SYMBOLS & ABBREVIATIONS LEGAL DESCRIPTION **LEGEND** GRADE BREAK N65'35'03"W 2.00' THE LAND REFERRED TO HEREIN BELOW IS SITUATED IN THE CITY OF OAKLAND, IN THE COUNTY OF ALAMEDA, STATE OF CALIFORNIA, AND IS DESCRIBED AS FOLLOWS: BLDC BUILDING CORNER FENCE IRON MISCELLANEOUS MANHOLE MISCELLANEOUS PULLBOX SANITARY SEWER UNE CATV-MH ₪ CABLE TV MANHOLE COMMENCING AT A POINT ON THE WESTERN LINE OF WEBSTER STREET, DISTANT THEREON NORTHERLY FROM THE NORTHERLY LINE OF FOURTEENTH STREET, ONE HUNDRED AND NINETY-ONE (191) FEET; THENCE RUNNING NORTHERLY ALONG SAID WESTERN LINE OF WEBSTER STREET, PROPERTY LINES WATER LINE CATCH BASIN CENTERLINE GAS LINE PAVEMENT SANDIS CONCRETE FENCE LINE COMMUNICATION LINE SCALE: 1"=2 STORM DRAIN MANHOLE SIXTY-FIVE (65) FEET; THENCE AT RIGHT ANGLES WESTERLY ONE HUNDRED AND FIFTY (150) FEET; THENCE AT RIGHT ANGLES SOUTHERLY SIXTY-FIVE (65) FEET; THENCE AT RIGHT ANGLES EASTERLY ONE HUNDRED AND FIFTY (150) FEET TO THE WESTERLY LINE OF WEBSTER STREET AND POINT OF ELECTRIC MANHOLE EDGE OF PAVEMENT ELEC-MH (E) — F0 — FIBER OPTIC LINE SANITARY CLEANOUT FG@DOOR FINISHED GRADE AT DOOR FLOW LINE SANITARY MANHOLE STL-T O-STREET LIGHT TRAFF SIGNAL FND-MON (FOUND STANDARD MONMNT APN: 008-0624-036-00 GATE POLE WATER METER THE LAND REFERRED TO HEREIN BELOW IS SITUATED IN THE CITY OF OAKLAND, IN THE COUNTY OF ALAMEDA, STATE OF CALIFORNIA, AND IS DESCRIBED AS FOLLOWS: BEGINNING AT THE POINT OF INTERSECTION OF THE WESTERN LINE OF WEBSTER STREET WITH THE SOUTHERN LINE OF 15TH STREET; RUNNING THENCE WESTERLY ALONG SAID LINE OF 15TH STREET, 47.50 FEET; THENCE AT RIGHT ANGLES SOUTHERLY, 70.25 FEET; THENCE AT RIGHT ANGLES SOUTHERLY, 70.25 FEET; THENCE AT RIGHT ANGLES CASTERLY, 47.50 FEET TO THE WESTERN LINE OF WEBSTER STREET; AND THENCE NORTHERLY ALONG SAID LINE OF WEBSTER STREET, 70.25 FEET TO THE POINT OF BEGINNING. N62'35'07"W 51.25' SOMH RIM 33.83 INV 15*THRU(NW-SE) 25.40 (PER PLAN NOT FIELD VERIFIED) INV 15*THRU(SW-NE) 22.75(PER PLAN NOT FIELD VERIFIED) SSMH RIN 33.73 INV 15*IN(NW) 20.60 (PER PLAN NOT FIELD VERIFIED, BEGINNING AT A POINT ON THE SOUTHERN LINE OF 15TH STREET, DISTANT THEREON 47.50 FEET WESTERLY FROM THE WESTERN LINE OF WEBSTER STREET; RUNNING THENCE WESTERLY ALONG SAID LINE OF 15TH STREET, 40 FEET; THENCE AT RIGHT ANGLES SOUTHERLY, 70.25 FEET; THENCE AT RIGHT ANGLES NORTHERLY, 70.25 FEET TO THE INV 15"OUT(SE) 25 to (PER PLAN NOT FIELD VERIFIE SD ISTH STREET - FOUND CITY (60' RIGHT OF WAY) SDMH RIM 33.61 INV 15"THRU(NW-SE) 25.40 (PER PLAN NOT FIELD VERIFIED) INV 15"THRU(SW-NE) 22.75 (PER PLAN NOT FIELD VERIFIED) SSMH RIM (NOT FIELD LOCATED) INV 15"OUT(SE) 20.60 (PER PLAN, NOT FIELD VERIFIED) APN: 008-0624-035-00 SSMH RIM 33.66 INV 15*M(SE) 23.90 (PER PLAN NOT FIELD VERIFIED) INV 15*THRU(SW-NE) 17.74 (PER PLAN NOT FIELD VERIFIED) SURVEY NOTES ALL DISTANCES AND DIMENSIONS ARE SHOWN IN FEET AND DECIMALS THEREOF. THIS SURVEY WAS PREPARED FROM INFORMATION FURNISHED IN A PRELIMINARY THE REPORT, PREPARED BY FIDELITY NATIONAL TITLE COMPANY DATED AS OF AUGUST 4, 2015, ORDER NUMBER 991-23068599-SLO, FUNNISHED TO SANDIS ENGINEERS, FOR USE WITH THIS TRANSACTION ONLY. NO LIABILITY IS ASSUMED FOR MATTERS OF RECORD NOT STATED IN SAID REPORT THAT MAY AFFECT THE TITLE LINES, OR EXCEPTIONS, OR EASEMENTS OF THE PROPERTY. FROM CORNER APN 008+0624-035 THE SUBJECT PROPERTY HAS DIRECT ACCESS TO AND FROM WEBSTER STREET WHICH IS A DULY DEDICATED AND ACCEPTED PUBLIC STREETS. CONCRETE BUILDING AREA=5,939± S.F. HEIGHT=26± FT. BUILDING AREAS SHOWN HEREON ARE BASED UPON FIELD LOCATIONS AND MEASUREMENTS (ROUNDED TO THE MEAREST TENTH OF A FOOT (0.11) FOR THE SUBJECT BUILDINGS TAKEN AT THE OUTSIDE BUILDING ENVELOPE AT GROUND LEVEL AS DIMENSIONED HEREON AND DOES NOT REPRESENT "ORP. INIC" OR THE ENTIRE BUILDING AREA AT ALL LEVELS OR REPRESENT THE EXISTENCE OF OR NON-EXISTENCE OF ANY MEZZANINES. N62'35'07"W 87.50" N62'35'07"W 30.00 FLOOD ZONE CLASSIFICATION THE SUBJECT PROPERTY IS LOCATED WITHIN FLOOD ZONE X - AREAS DETERMINED TO BE OUTSIDE THE 0.2% ANNUAL CHANCE FLOODPLAIN, AS PER FEDERAL EMERGENCY MANAGEMENT AGENCY FLOOD INSURANCE RATE MAP NUMBER PROPURCES AS A SECOND OF THE PROPURCES AS A SECOND OF BASIS OF BEARINGS OAKLAND, CA 94612 THE BEARING OF N 27'24'57" E FOR THE MONUMENT LINE OF WEBSTER STREET AS SHOWN ON THAT CERTAIN PARCEL MAP FILED ON MAY 11, 2000, IN BOOK 252 OF MAPS AT PAGE 1-2, ALAMEDA COUNTY RECORDS WAS TAKEN AS THE BASIS OF THE BEARINGS SHOWN THIS CHIEFE. 46.07 TOW 37.61 ALL DISTANCES AND DIMENSIONS ARE SHOWN IN FEET AND DECIMALS THEREOF. 2. DATES OF FIELD SURVEY: FEBRUARY 2016 UNDERGROUND UTILITY NOTE THE TYPES, LOCATIONS, SIZES AND/OR DEPTHS OF EXISTING UNDERGROUND UTILITIES AS SHOWN ON THIS TOPOGRAPHIC SURVEY ARE APPROXIMATE AND WERE OBTAINED FROM SOURCES OF VARYING RELIABILITY. ONLY ACTUAL EXCAVATION WILL REVEAL THE TYPES, EXTENT, SIZES, LOCATIONS AND DEPTHS OF SUCH UNDERGROUND UTILITIES. A REASONABLE EFFORT HAS BEEN MADE TO LOCATE AND DELINEATE ALL KNOWN UNDERGROUND UTILITIES. HOWEVER, THE ENGINEER CAN ASSUME NO RESPONSIBILITY FOR THE COMPLETENESS OR ACCURACY OF ITS DELINEATION OF SUCH UNDERGROUND UTILITIES WHICH MAY BE ENCOUNTERED, BUT WHICH ARE NOT SHOWN ON THIS SURVEY. TOPOGRAPHIC SURVEYOR 'S STATEMENT THIS MAP CORRECTLY REPRESENTS A TOPOGRAPHIC SURVEY MADE BY ME OR UNDER MY DIRECTION IN CONFORMANCE WITH THE REQUIREMENTS OF THE LAND SURVEYORS ACT AT THE REQUEST OF ANALYLUS GROUP ON MARCH 21, 2016. Purcay 14TH STREET SSMH RIM (NOT FIELD LOCATED) INV 15"THRU(SW-NE) 25.50 (PER PLAN NOT FIELD VERIFIED) V62'35'07"W 1.84 MONUMENT FOUND CITY SANDIS CIVIL ENGINEERS TOPOGRAPHIC SURVEY SURVEYORS DRAW N BY: 1433 WEBSTER STREET/351-359 15TH STREET 1700 Winchester Boulevard, Campbell, CA 95008 | P. 408.636.0900 | F. 408.636.0999 | www.sandis.nel OAKLAND CALIFORNIA SILICON VALLEY TRI-VALLEY CENTRAL VALLEY SACRAMENTO EAST BAY/SF

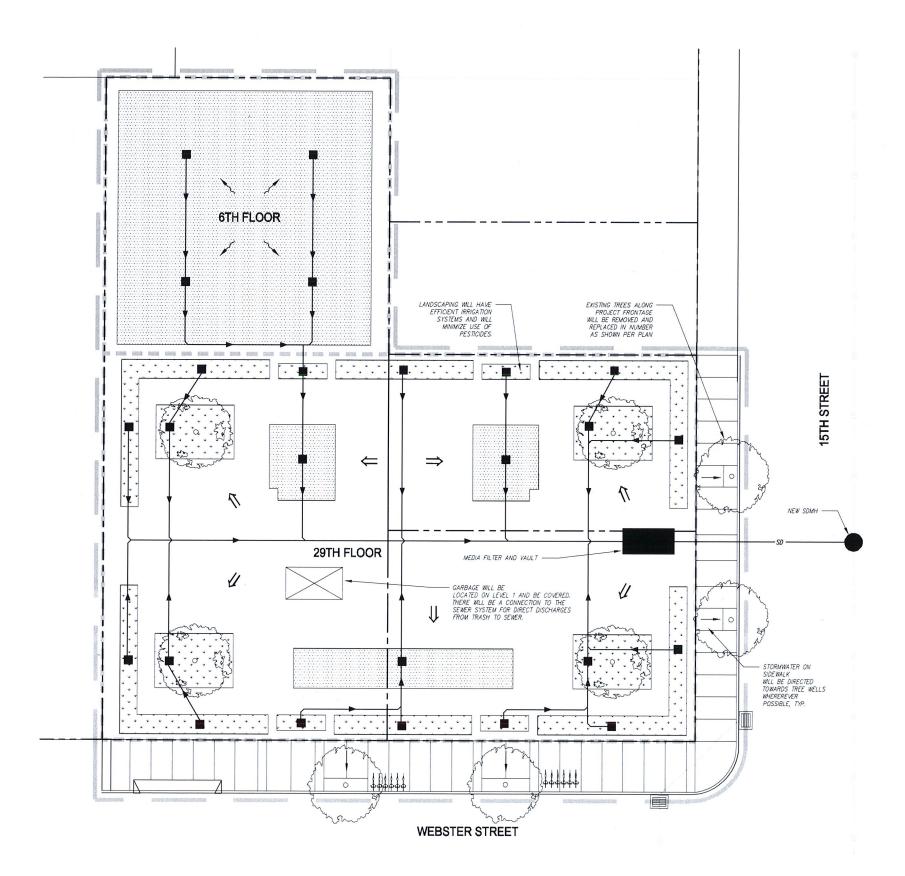



AREA SUMMARY

TOTAL ⁶ SITE AREA	TOTAL ¹ AREA DISTURBED	TOTAL EXISTING/PRE-PROJECT 2 IMPERMOUS SURFACE	REPLACED 3 IMPERVIOUS SURFACE		TOTAL POST PROJECT 5 IMPERVIOUS SURFACE	TOTAL POST PROJECT PERVIOUS SURFACE
15,896 SF	15,896 SF	15,896 SF	9,248 SF	0 SF	9,248 SF	6,648 SF

- 1. LAND AREA DISTURBED = SURFACE AREA OF CONSTRUCTION ACTIVITIES, INCLUDING GRADING, CONSTRUCTION, STAGING, AND STORAGE AREAS.

- 2. EXISTING/PRE-PROJECT IMPERVOUS SURFACE = TOTAL AMOUNT OF IMPERVOUS SURFACE ON-SITE PRIOR TO THE PROJECT.


 3. REPLACED IMPERVOUS SURFACE = PROJECT IMPERVOUS SURFACE THAT REPLACES EXISTING/PRE-PROJECT IMPERVOUS SURFACE.

 4. NEW IMPERVOUS SURFACE = PROJECT IMPERVOUS SURFACE THAT REPLACES EXISTING/PRE-PROJECT EMPERVOUS SURFACE.

 5. POST-PROJECT IMPERVOUS SURFACE = TOTAL AMOUNT OF IMPERVOUS SURFACE ON-SITE AFTER COMPLETION OF THE PROJECT.

 6. SITE AREA IS ASSUMED TO BE AREA WITHIN PROPERTY LINES AND DOES NOT INCLUDE AREA IN PUBLIC RIGHT OF WAY.

LEGEND

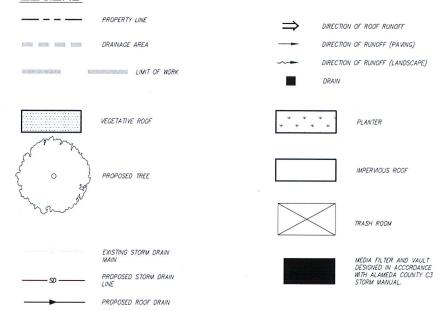

STORMWATER MANAGEMENT PLAN NOTES

- THE PROPOSED PROJECT WILL INCLUDE MORE THAN 10,000 SQUARE FEET OF IMPERVIOUS SURFACE AND HAS THEREBY BEEN PLANNED TO COMPLY WITH THE PROVISION C.3 NEW DEVELOPMENT AND REDEVELOPMENT OF THE MUNICIPAL REGIONAL STORMWATER PERMIT (ORDER NO. R2-2009-0074).
- 50% RULE CHECK WHERE A REDEVELOPMENT PROJECT RESULTS IN AN ALTERATION OF MORE THAN 50 PERCENT OF THE IMPERVIOUS SURFACE OF A PREVIOUSLY EXISTING DEVELOPMENT, THE ENTIRE PROJECT, CONSISTING OF ALL EXISTING, NEW, AND/OR REPLACED IMPERVIOUS SURFACES, MUST BE INCLUDED IN THE TREATMENT SYSTEM DESIGN.

AREA OF EXISTING IMPERVIOUS SURFACES WITHIN PROJECT SITE = 15,896 SF AREA OF REPLACED IMPERVIOUS SURFACES WITHIN PROJECT SITE = 15,896 SF TOTAL PERCENT OF ALTERED OR REPLACED IMPERVIOUS SURFACE = 100%

THEREFORE THE PROJECT IS REQUIRED TO PROVIDE TREATMENT FOR ALL EXISTING, NEW, AND/OR REPLACED IMPERVIOUS SURFACES.

- GENERAL STORMWATER QUALITY APPROACH STORMWATER QUALITY FEATURES WILL INCLUDE MINIMIZING IMPERVIOUS SURFACES, PLANTER BOXES, VEGETATIVE ROOF, AND DIRECTING STORMWATER TO A MEDIA FILTER LOCATED IN THE BASEMENT WHICH WILL REMOVE SUSPENDED SOLIDS AND SEDIMENT FROM THE STORMWATER BEFORE IT LEAVES THE SITE.
- 4. SIZING CRITERIA STORMWATER QUALITY FEATURES WILL BE SIZED TO COMPLY WITH THE NPDES PERMIT PROVISION C.3 AND THE LATEST EDITION (2013) OF THE ALAMEDA COUNTY STORMWATER MANUAL. THE BIORETENTION AREAS SHOWN HAVE BEEN SIZED USING THE 4% RULE (BIORETENTION AREAS SIZED TO 4% OF THE CONTRIBUTING IMPERVIOUS AREAS) AND UNIFORM FLOW METHOD, ASSUMING A 0.2 IN/HR INTENSITY RATE AND A 5 IN /HR PERCOLATION RATE.
- MANAGING PEAK FLOWS THE POST-DEVELOPMENT STORMWATER PEAK FLOWS FOR THE 10-YR, 10-MINUTE STORM (PER CITY OF OAKLAND STORMWATER MANUAL) MILL BE MITGATED ON-SITE BY USING BIORETENTION FACILITIES, VEGETATION ROOFS, TREE PLANTER BOYES, AND MEDIA FLIETE. THIS WILL PROVIDE A COMBINATION OF ON-SITE RETENTION AND DETENTION BY SIZING THEIR OUTLETS TO LIMIT PEAK FLOW TO BE EQUAL TO OR LESS THAN THE CURRENT, PRE-DEVELOPMENT CONDITION. THERE WILL BE NO INDREASE IN FLOW RATE FOR THE DESIGN STORM FROM THIS
- HYDROMODIFICATION THE PROJECT IS NOT LOCATED IN AN AREA THAT IS REQUIRED TO DESIGN STORMWATER CONVEYANCES TO ACCOUNT FOR HYDROMODIFICATION.
- THIS PROJECT IS CONSIDERED SPECIAL CATEGORY TYPE A. THEREFORE THE SITE CAN USE LID OR NON-LID STORMWATER TREATMENT PER THE ALAMEDA COUNTY C.3 TECHNICAL MANUAL (2015).



RAD BUILD P.O. Box 70975 , Oakland, CA 94612 Tel: 510.343.5593

OWNER

VILLAGE GLENN OAKLAND 1, LLC P.O. Box 70975, OAKLAND, CA 94612 1 510:343:5593

GENERAL CONTRACTOR

RAD BUILD P.O. Box 70975, OAKLAND, CA 94612 1, 510 343 5593

ARCHITECT OF RECORD

RAD BUILD P.O. Box 70975, OAKLAND, CA 94612 1, 510.343,5593

PROJECT DESIGN



EAST BAY/SF

ISSUE RECORD						
No.	Description	Date				
001	ZONING PRE-APPLICATION	2-10-2016				
002	BASIC APPLICATION FOR DEV. REVIEW	4-22-2016				
003	BASIC APPLICATION FOR DEV. REVIEW	7-22-2016				
004	BASIC APPLICATION FOR DEV. REVIEW	9-15-2016				
005	BASIC APPLICATION FOR DESIGN REVIEW	10-12-2016				

1433 Webster Ave.

Oakland, CA 94609

RAD BUILD P.O. Box 70975 Oakland, CA 94612 Tel: 510.343.5593


NEMO Building Systems, LLC 18231 Muprhy Pkwy Lathrop, CA 95330

STORMWATER **MANAGEMENT**

RAD Project Number 0001 22, JULY 2016 EA Drawn by

NTS

File: X: \P\616011\PLAN SETS\PRELIMINARY\C1.0.dwg Date: Jul 08, 2016 - 4:31pm

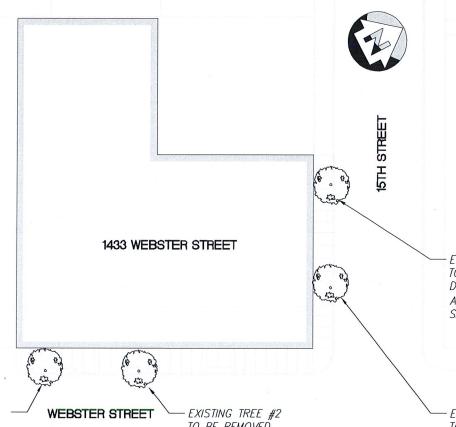

- EXISTING TREE #4 TO BE REMOVED DBH = DIAMETER OF TREE AT 4.5' ABOVE BASE = 11" SPECIES: LOPHOSTEMON CONFERTUS


EXISTING TREE #1 TO BE REMOVED DBH = DIAMETER OF TREE AT 4.5' ABOVE BASE = 12.5" SPECIES: LOPHOSTEMON CONFERTUS

- EXISTING TREE #2 TO BE REMOVED DBH = DIAMETER OF TREE AT 4.5' ABOVE BASE = 14.5" SPECIES: LOPHOSTEMON CONFERTUS - EXISTING TREE #3 TO BE REMOVED DBH = DIAMETER OF TREE AT 4.5' ABOVE BASE = 14" SPECIES: LOPHOSTEMON CONFERTUS






TREE #2

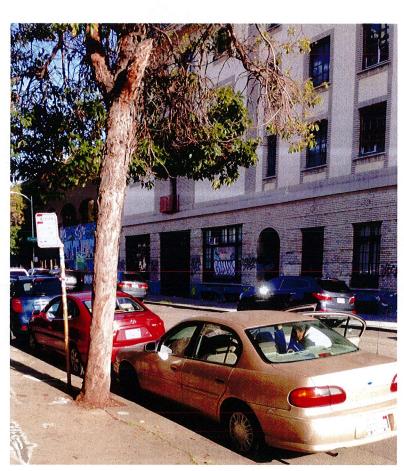

TREE #3

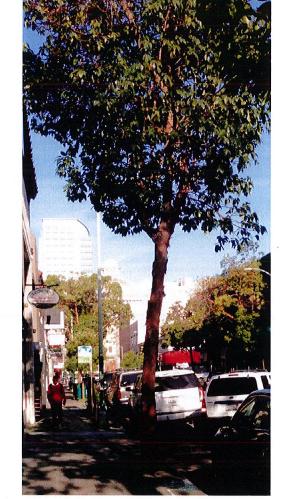

TREE #4



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OWNER

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GENERAL CONTRACTOR

P.O. Box 70975, OAKLAND, CA 94612 1, 510 343 5593

ARCHITECT OF RECORD

AD BUILD O. Box 70975, OAKLAND, CA 94612

PROJECT DESIGN

230 E OHIO ST SUITE 4" CHICAGO, IL 60611

CIVIL

ANDIS CIVIL ENGINEERS SURVEYORS, INC



EAST BAY/SF

PLAN CHECK #

ISSUE DECOR

No.	Description	Date
601	ZONING PRE-APPLICATION	2-10-2016
002	BASIC APPLICATION FOR DEV. REVIEW	4-22-2016
003	BASIC APPLICATION FOR DEV. REVIEW	7-22-2016
004	BASIC APPLICATION FOR DEV. REVIEW	9-15-2016
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Oakland, CA 94609

RAD BUILD P.O. Box 70975 Oakland, CA 94612 Tel: 510.343.5593

NEMO Building Systems, LLC 18231 Muprhy Pkwy Lathrop, CA 95330

TREE EXHIBIT

RAD Project Number

0001 22, JULY 2016

Drawn by


Date

C2.0

Scale

NTS

TREE #1

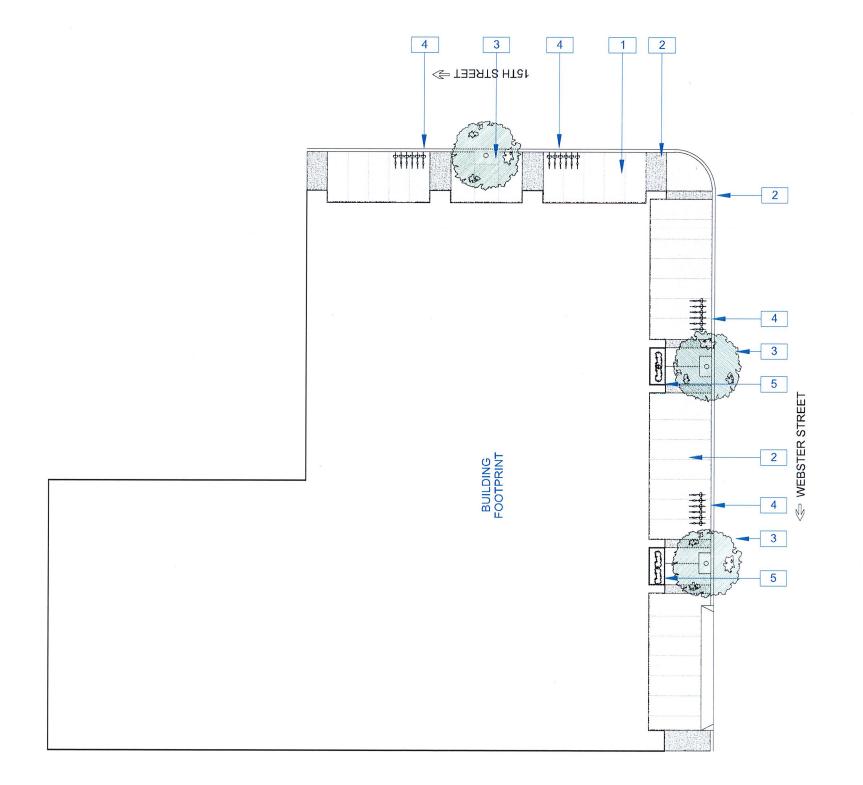





1 CONCRETE SIDEWALK



2 CONCRETE SIDEWALK ACCENT COLOR



3 NEW STREET TREE 'ACER BUERGERIANUM'



4 SHORT TERM BIKE PARKING





5 METAL PLANTER BOX WITH 'CAREX MORROWII' AND 'SORGHASTROM NUTANS'



GENERAL CONTRACTOR

ARCHITECT OF RECORD

RAD BUILD P.O. Box 70975, OAKLAND, CA 94612 L 510 343 5593

RAD DESIGN/ SDG 230 E. OHIO ST. SUITE 410 CHICAGO, IL 60611 1, 510,459 3795

AGENCY APPROVALS

PLAN CHECK #

ISSUE RECORD

 901
 ZONING PRE-APPLICATION
 2-10-2016

 902
 BASIC APPLICATION FOR DEV. REVIEW
 4-22-2016

1433 Webster Ave.

Oakland, CA 94609


RAD BUILD P.O. Box 70975 Oakland, CA 94612 Tel: 510.343.5593

NEMO Building Systems, LLC 18231 Muprhy Pkwy Lathrop, CA 95330

LANDSCAPE

RAD Project Number 0001 Date 12, OCT 2016

3/32" = 1'-0"

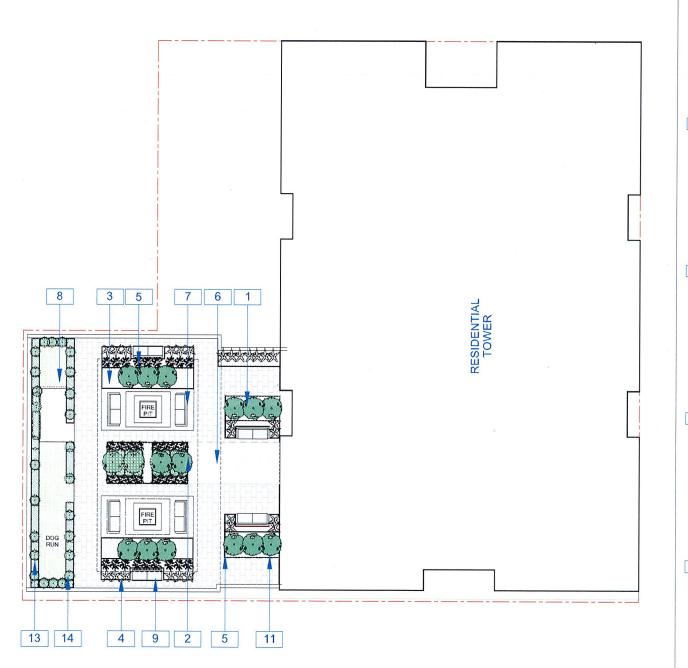

NOTATION KEY



1 CERCIS OCCIDENTALIS IN RAISED PLANTER



2 ACER PALMATUM IN RAISED PLANTER



3 DANIELLA TASMANICA



4 SALVIA 'DARA'S CHOICE'



5 CHONDROPETALUM TECTORUM

NOTATION KEY

- 6 TYPICAL GRASS GROUND COVER
- 7 SEATING AREA WITH FIRE PIT
- 8 ARTIFICIAL TURF
- 9 SEATING AREA



10 CHINESE PISTACHE IN RAISED METAL PLANTER



11 CONCRETE PAVER



12 CONCRETE PAVER ACCENT



13 METAL PLANTER BOX WITH 'BENI KAZE'



PROTASPARAGUS DENSIFLORUS 'MEYERS'

15 6' GLASS WINDBREAK/ GUARDRAIL



RAD BUILD P.O. Box 70975 , Oakland, CA 94612 Tel: 510.343.5593

VILLAGE GLENN OAKLAND 1, LLC P.O. Box 70975, OAKLAND, CA 94612 L 510:343:5593

GENERAL CONTRACTOR

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ARCHITECT OF RECORD

PROJECT DESIGN

AGENCY APPROVALS

PLAN CHECK # ISSUE RECORD

No. Description

Doi: ZONING PRE-APPLICATION

1433 Webster Ave.

Oakland, CA 94609

RAD BUILD P.O. Box 70975 Oakland, CA 94612 Tel: 510.343.5593


NEMO Building Systems, LLC 18231 Muprhy Pkwy Lathrop, CA 95330

LANDSCAPE

Date 12, OCT 2016

3/32" = 1'-0"

LANDSCAPE PLAN: LEVEL 6

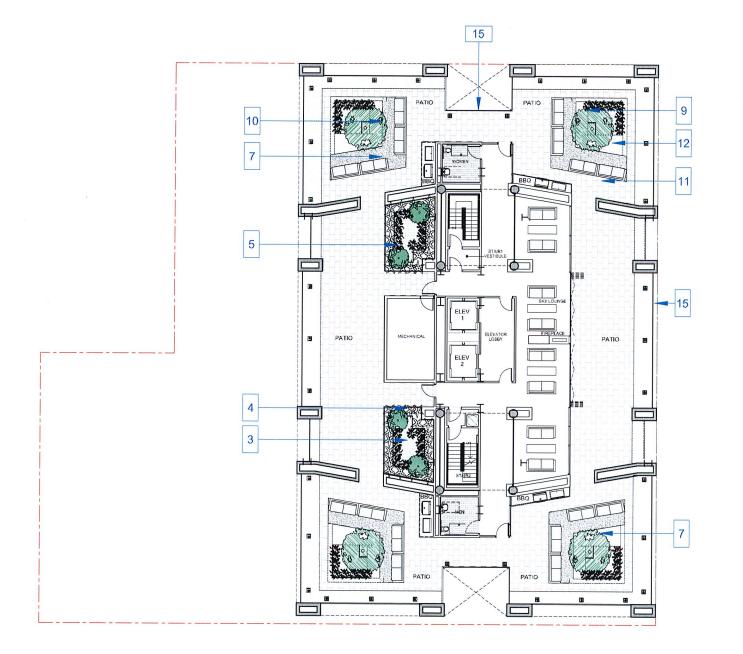

NOTATION KEY



1 CERCIS OCCIDENTALIS IN RAISED PLANTER



2 ACER PALMATUM IN RAISED PLANTER



3 DANIELLA TASMANICA



SALVIA 'DARA'S CHOICE'



5 CHONDROPETALUM TECTORUM

NOTATION KEY

- 6 CONCRETE ACCENT PAVER
- 7 SEATING AREA WITH FIRE PIT
- 8 WATER STUB OUT
- 9 SEATING AREA



CHINESE PISTACHE IN RAISED METAL PLANTER



11 CONCRETE PAVER



12 CONCRETE PAVER ACCENT



13 METAL PLANTER BOX WITH 'BENI KAZE'



PROTASPARAGUS DENSIFLORUS 'MEYERS'

15 6' GLASS WINDBREAK/ GUARDRAIL



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1433 Webster Ave.


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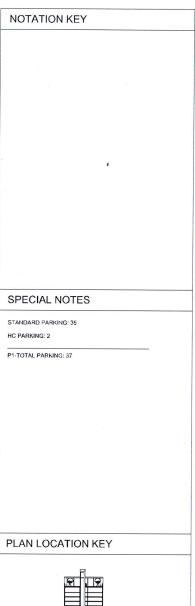
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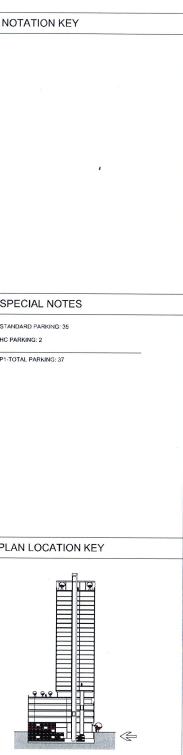
NEMO Building Systems, LLC 18231 Muprhy Pkwy Lathrop, CA 95330


LANDSCAPE

RAD Project Number 12, OCT 2016 Drawn by





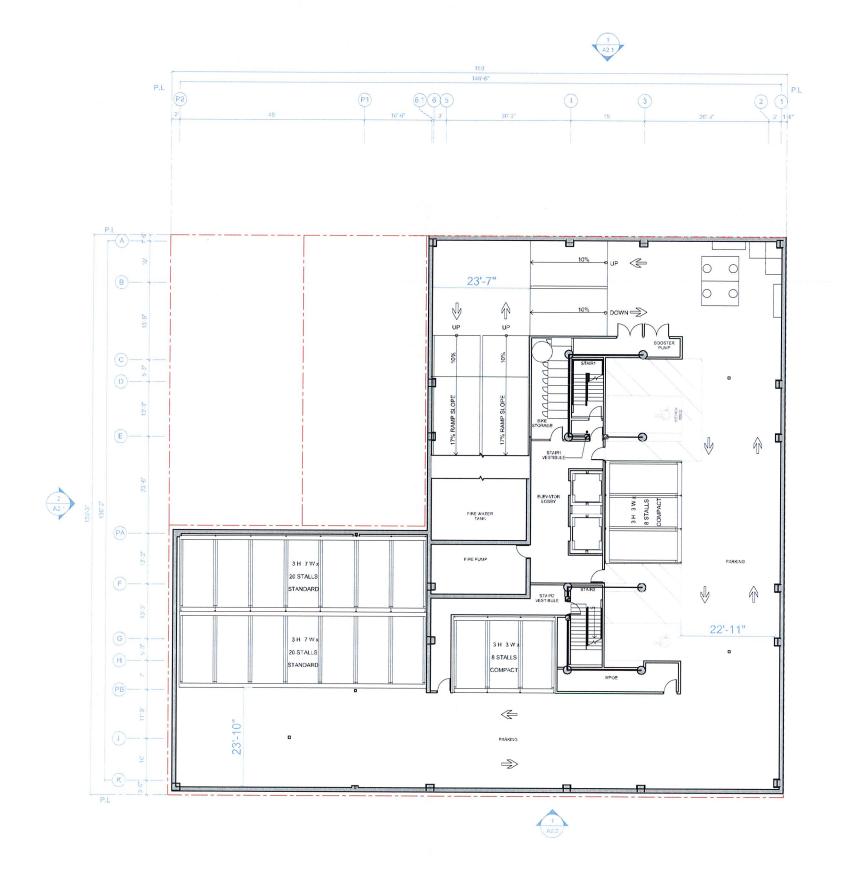

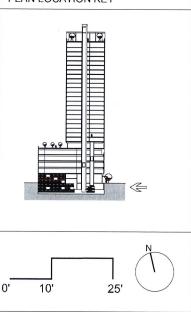



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ARCHITECT OF RECORD

RAD BUILD P.O. Box 70975, OAKLAND, CA 94612 t 510:343 5593

PROJECT DESIGN

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1433 Webster Ave.

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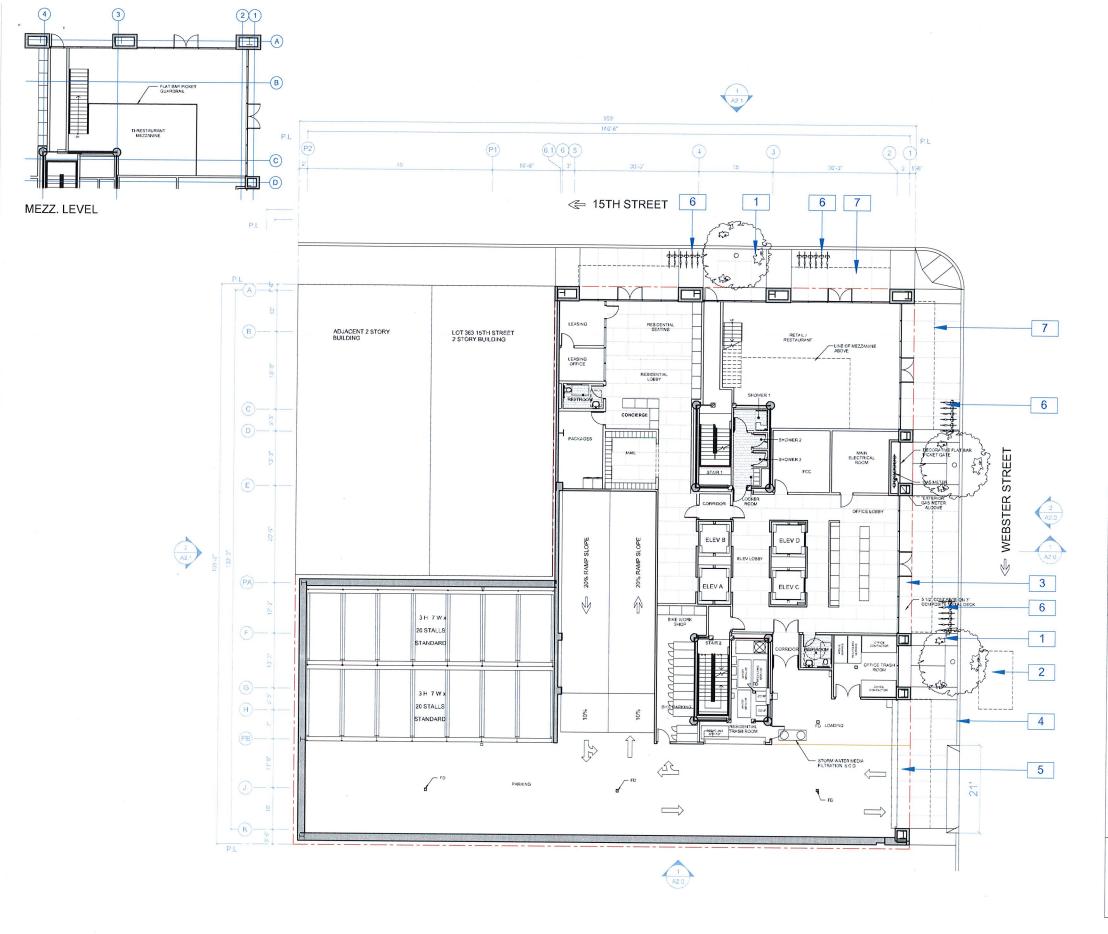
PLAN

RAD Project Number Date

12, OCT 2016

3/32" = 1'-0"

LEVEL P1 PLAN





- 1 NEW STREET TREES
- UNDERGROUND VAUL
- 3 STOREFRONT GLAZING
- 4 CITY STANDARD CURB CUT
- 5 RESIDENTIAL VEHICLE ENTRY
- 6 SHORT TERM BIKE PARKING
- 7 CANOPY ENCROACHING 5 FEET BEYOND PROPERTY LINE

SPECIAL NOTES

STANDARD PARKING: 40

HC PARKING: 0

L1-TOTAL PARKING: 40

COMMERCIAL BIKE PARKING: 8 LONG TERM, 5 SHORT TERM

RESIDENTIAL TRASH
COMPACTED TRASH

3 BINS PROVIDED (2.3 cubic yard ea.)

COMPACTED RECYCLE

2 BINS PROVIDED (2.3 cubic yard ea.)


OFFICE RECYCLE

2 BINS PROVIDED (1 cubic yard ea.)

OFFICE TRASH

5 BINS PROVIDED (1 cubic yard ea. 2 compacted, 3 loose)

PLAN LOCATION KEY

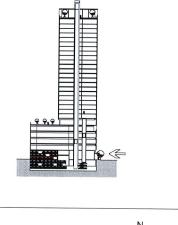

10' 25' N

RAD

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VILLAGE GLENN QAKLAND 1, LLC P.O. Box 70975, QAKLAND, CA 9461:

t. 510.343.5593

GENERAL CONTRACTOR

P.O. Box 70975, OAKLAND, CA

ARCHITECT OF RECORD

RAD BUILD P.O. Box 70975, OAKLAND, CA 94612 1, 510 343 5593

PROJECT DESIGN

RAD DESIGN/ SDG 230 E. OHIO ST. SU

230 E. OHIO ST. SUIT CHICAGO, IL 60611

SANDIS CIVIL ENGINEERS SU

6 9TH STREET. AKLAND, CA 94607 510 873 8966

AGENCY APPROVALS

PLAN CHECK#

ISSUE RECORD

1433 Webster Ave.

Oakland, CA 94609

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NEMO Building Systems, LLC 18231 Muprhy Pkwy Lathrop, CA 95330

PLAN


 RAD Project Number
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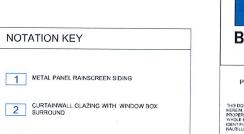
 Date
 12, OCT 2016

Δ1 Δ

3/32" = 1'-0"

LEVEL 1 PLAN



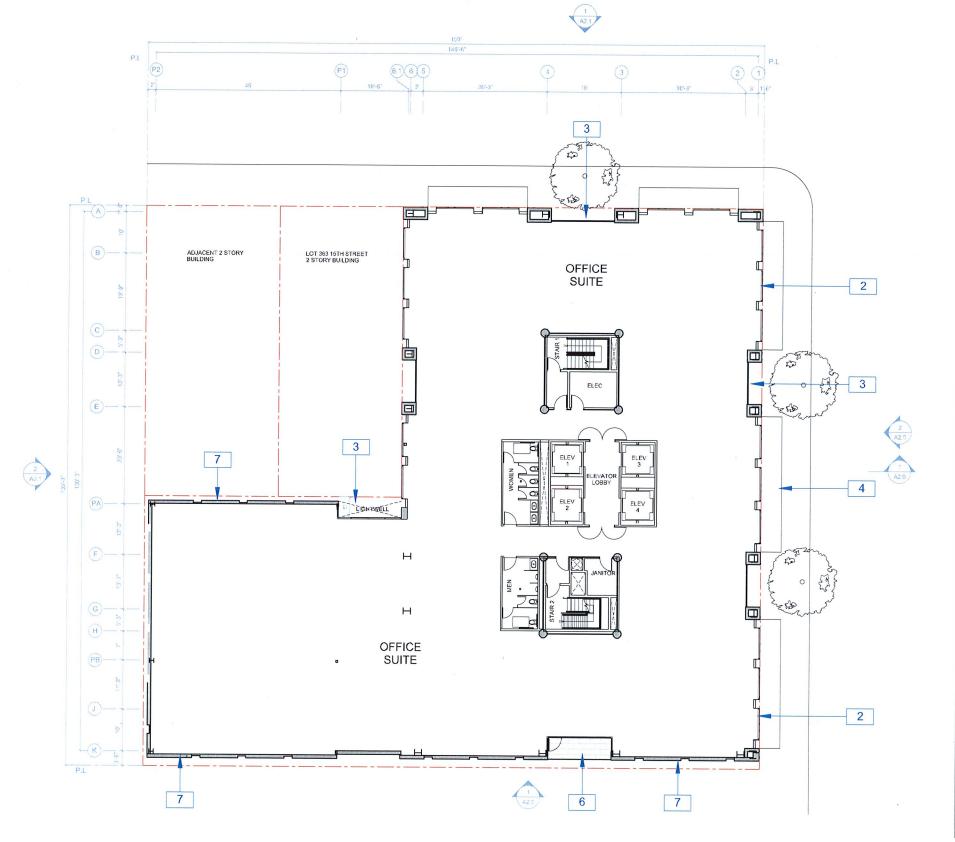

3 CURTAINWALL GLAZING

4 CANOPY ENCROACHING 5 FEET BEYOND PROPERTY LINE.

5 FIRE RATED WINDOW

6 BALCONY

7 CEMENT PLASTER

SPECIAL NOTES

PLAN LOCATION KEY 29.9 10' 25'

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ARCHITECT OF RECORD

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PROJECT DESIGN

AGENCY APPROVALS

PLAN CHECK #

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 ZONING PRE-APPLICATION
 2-10-2016

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 BASIC APPLICATION FOR DEV. REVIEW
 4-22-2016

 003
 BASIC APPLICATION FOR DEV. REVIEW
 7-22-2016

 604
 BASIC APPLICATION FOR DEV. REVIEW
 8-15-2016

1433 Webster Ave.

Oakland, CA 94609

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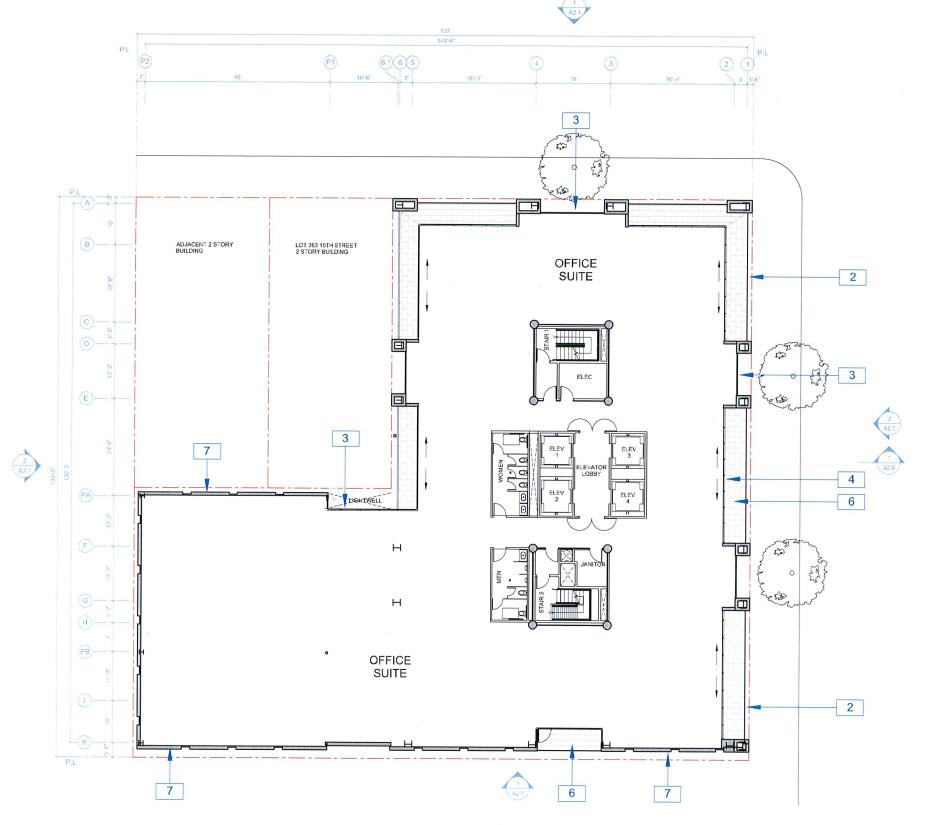
PLAN


RAD Project Number Date


12, OCT 2016

3/32" = 1'-0"

0001



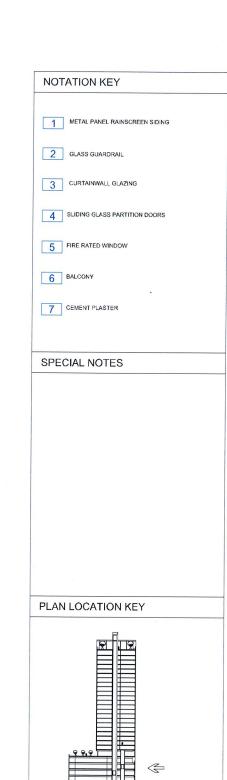

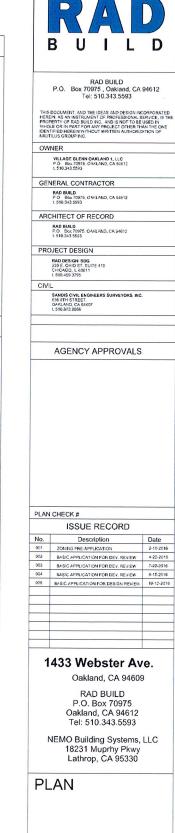

 RAD Project Number
 0001


 Date
 12, OCT 2016


 Drawn by
 SDG

A1.6

3/32" = 1'-0"

10'

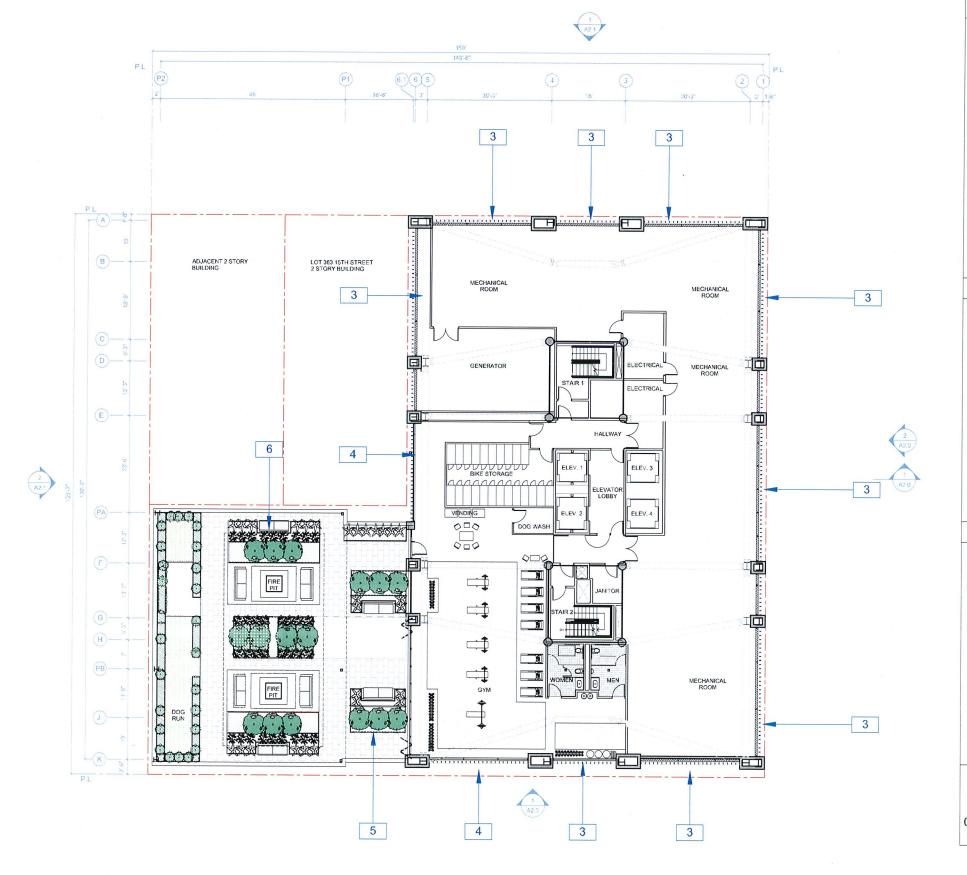

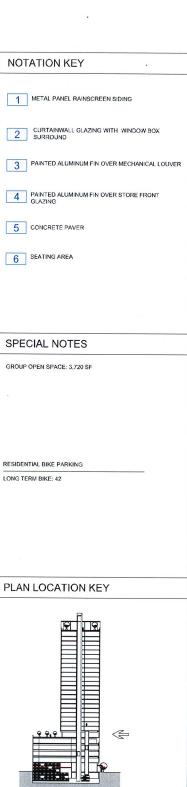



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ARCHITECT OF RECORD

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PROJECT DESIGN

AGENCY APPROVALS

PLAN CHECK # ISSUE RECORD

Description 001 ZONING PRE-APPLICATION
 002
 BASIC APPLICATION FOR DEV. REVIEW
 4-22-2016

 003
 BASIC APPLICATION FOR DEV. REVIEW
 7-22-2016
 004 BASIC APPLICATION FOR DEV. REVIEW 8-15-2016 005 BASIC APPLICATION FOR DESIGN REVIEW 10-12-2016

1433 Webster Ave.

Oakland, CA 94609

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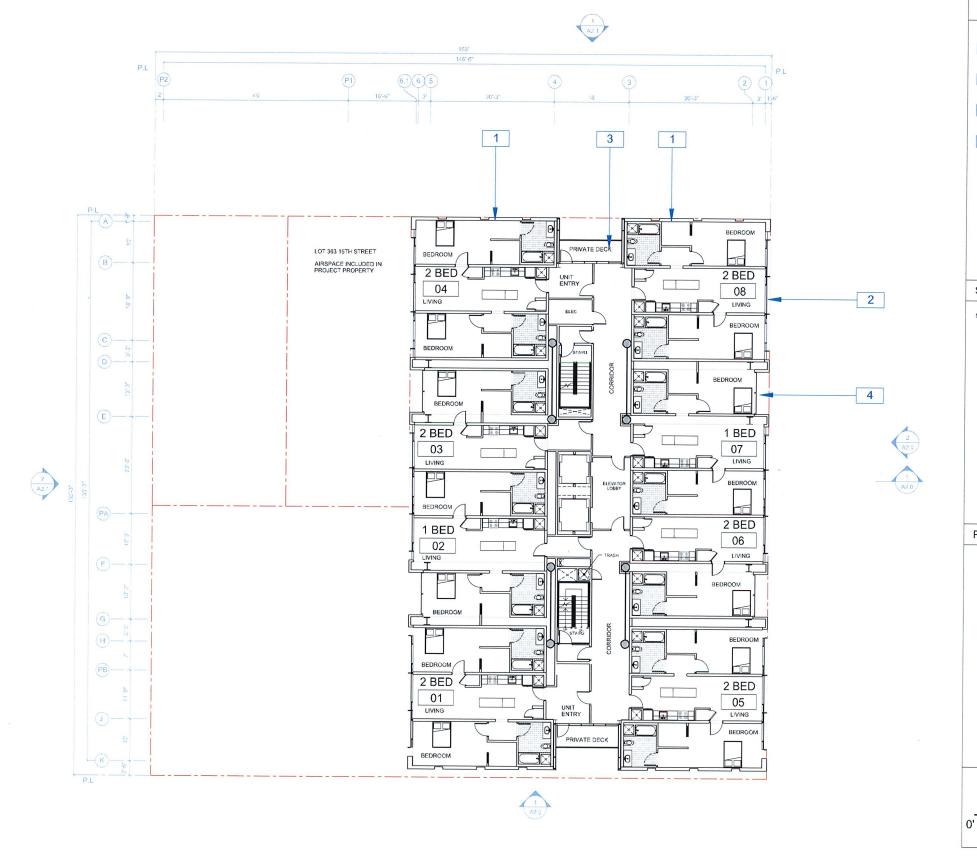
PLAN

RAD Project Number

12, OCT 2016 Drawn by SDG

3/32" = 1'-0"

25'







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ARCHITECT OF RECORD

RAD BUILD P.O. Box 70975, OAKLAND, CA 94612 L 510,343 5593

PROJECT DESIGN

230 E. OHIO ST. SUITE 4 CHICAGO, IL 60611

L 510.459.3795

636 9TH STREET. OAKLAND, CA 94607 L 510.873.8866

AGENCY APPROVALS

PLAN CHECK #

1433 Webster Ave.

Oakland, CA 94609

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NEMO Building Systems, LLC 18231 Muprhy Pkwy Lathrop, CA 95330

PLAN

RAD Project Number

 Date
 12, OCT 2016


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 SDG


A1.8

3/32" = 1'-0"

0001

10'

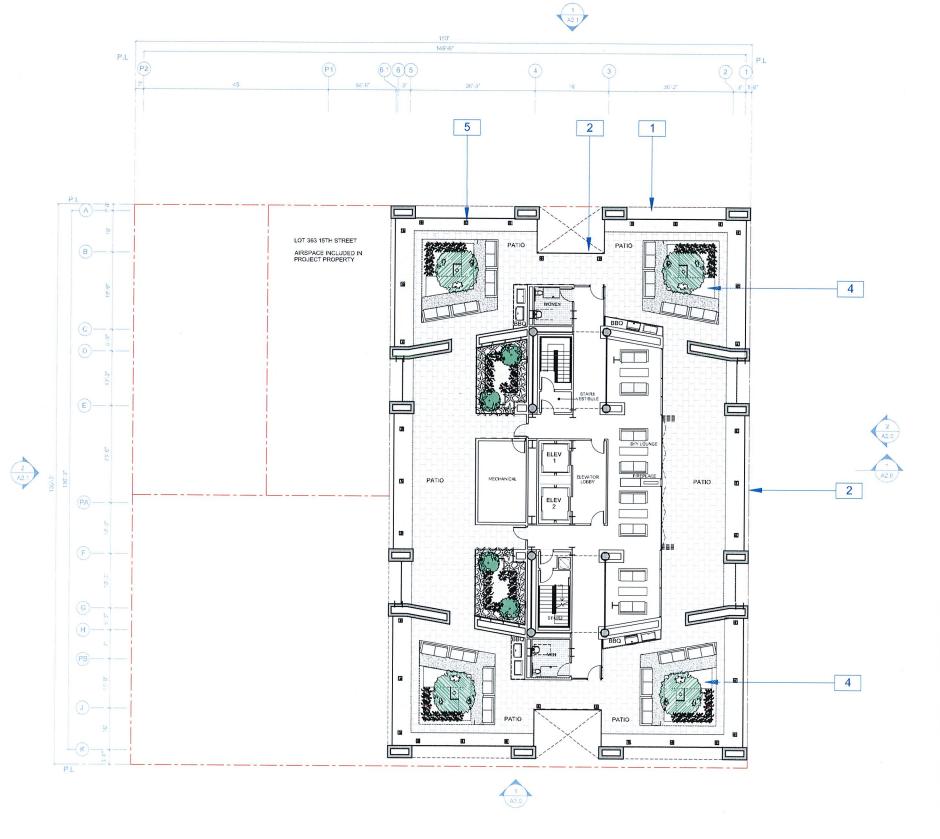

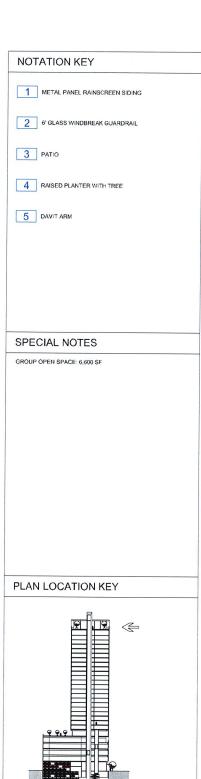



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VILLAGE GLENN OAKLAND 1, LI P.O. Box 70975, OAKLAND, CA 9

GENERAL CONTRACTOR

P.O. Box 70975, CAKLAND, CA

1 310.343 3393

ARCHITECT OF RECORD

RAD BUILD
P.O. Box 70975, OAKLAND, CA 94612
L 510 343 5593

L 510.343 5593

PROJECT DESIGN

RAD DESIGN/ SDG 230 E. OHIO ST. SUITE CHICAGO, IL 60611

L 510.459.3795

IDIS CIVIL ENGINEERS SURVEYO 9TH STREET. (LAND. CA 94607

AGENCY APPROVALS

PLAN CHECK

ISSUE RECORD

 No.
 Description
 Date

 601
 ZONNO PREAPPLICATION
 2:10-2016

 602
 BASIC APPLICATION FOR DEV. REVIEW
 4:22-2018

 603
 BASIC APPLICATION FOR DEV. REVIEW
 7:22-2016

 604
 BASIC APPLICATION FOR DEV. REVIEW
 8:15-2016

994 BASIC APPLICATION FOR DEV. REVIEW 8-1
995 BASIC APPLICATION FOR DESIGN REVIEW 10

1433 Webster Ave.

Oakland, CA 94609

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NEMO Building Systems, LLC 18231 Muprhy Pkwy Lathrop, CA 95330

PLAN

 RAD Project Number
 0001


 Date
 12, OCT 2016

A19

3/32" = 1'-0"

LEVEL 29 PLAN

10'

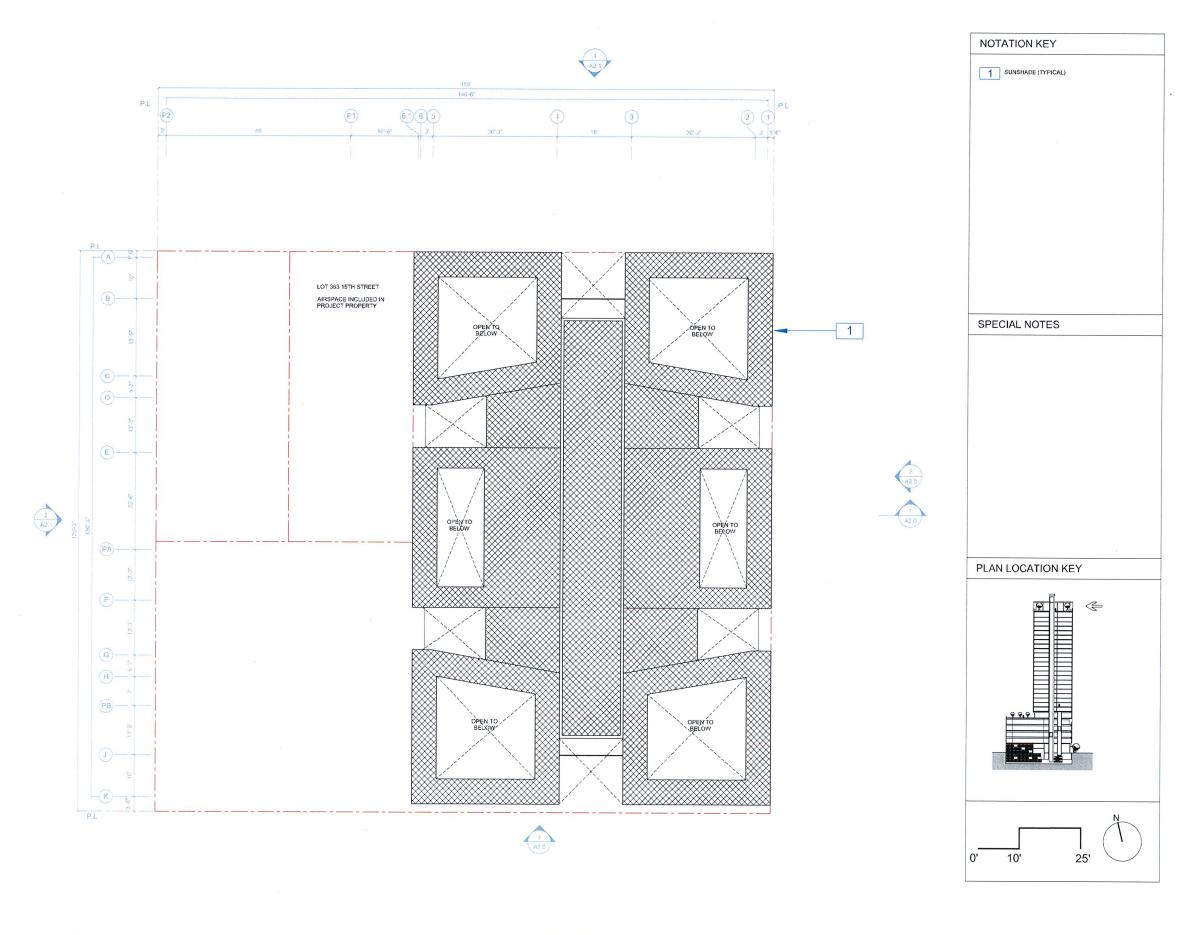



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PROJECT DESIGN

CHICAGO, IL 60611 L 510.459 3795

/IL

36 9TH STREET. AKLAND, CA 94607

AGENCY APPROVALS

PLAN CHECK #

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	ISSUE RECORD	SUE RECORD		
0.	Description	Date		
01	ZONING PRE-APPLICATION	2-10-2016		
)2	BASIC APPLICATION FOR DEV. REVIEW	4-22-2016		
3	BASIC APPLICATION FOR DEV. REVIEW	7-22-2016		
04	BASIC APPLICATION FOR DEV. REVIEW	9-15-2016		
15	BASIC APPLICATION FOR DESIGN REVIEW	10-12-201		

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NEMO Building Systems, LLC 18231 Muprhy Pkwy Lathrop, CA 95330

PLAN

RAD Project Number

Date 12,

 Date
 12, OCT 2016


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 SDG

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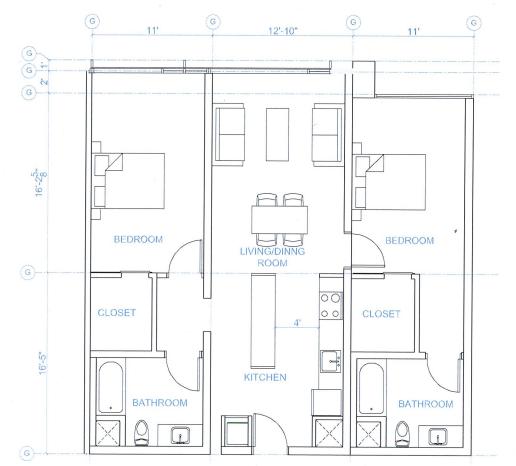
3/32" = 1'-0"

0001


ROOF PLAN

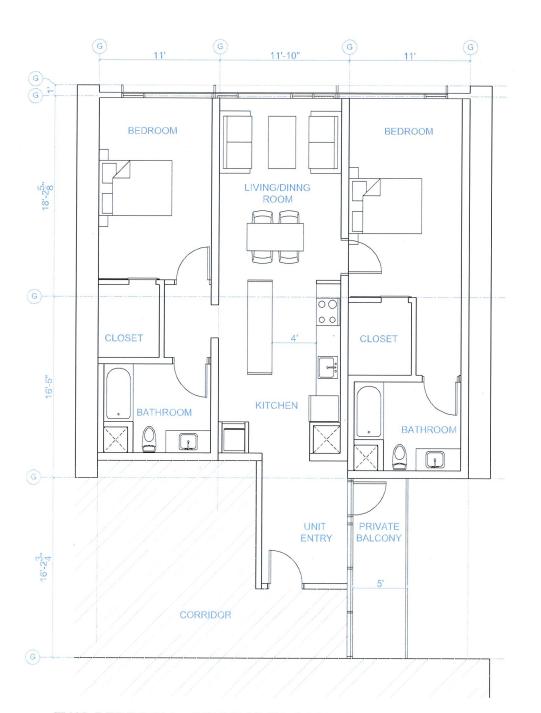

TWO BEDROOM + FOYER UNIT: 1,360 SF



TWO BEDROOM UNIT: 1,200 SF

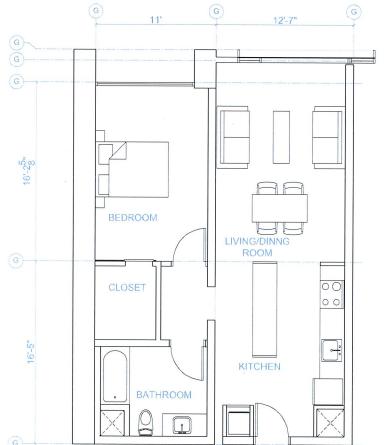

ONE BEDROOM UNIT: 820 SF

ENLARGED UNIT PLANS

1/4" = 1'-0"

PLAN CHECK # ISSUE RECORD
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AGENCY APPROVALS

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PROJECT DESIGN

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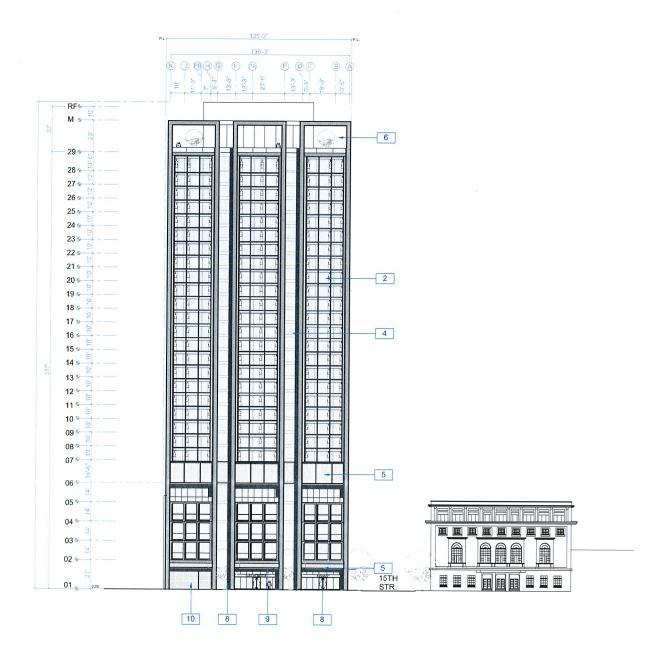
1433 Webster Ave. Oakland, CA 94609


> RAD BUILD P.O. Box 70975 Oakland, CA 94612 Tel: 510.343.5593

NEMO Building Systems, LLC 18231 Muprhy Pkwy Lathrop, CA 95330

ENLARGED PLANS

RAD Project Number 0001 Date 12, OCT 2016 SDG



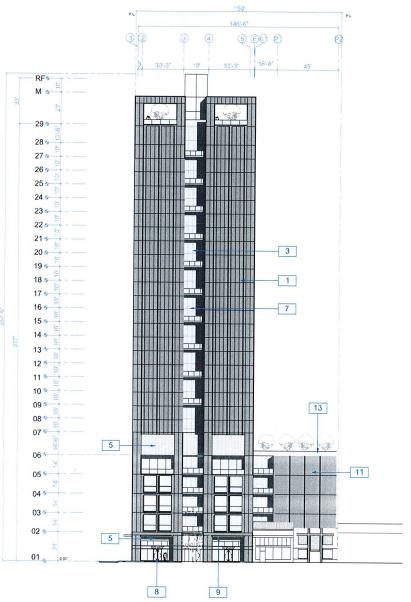

NOTATION KEY

1 METAL PANEL RAINSCREEN SIDING
2 CURTAINWALL GLAZING WITH OPERABLE LIGHT AND EXTRUDED MULLION CAP
3 STOREFRONT GLAZING
4 RECESSED WINDOWS
5 MECHANICAL LOUVER
6 GROUP OPEN SPACE WITH SUNSHADE
7 BALCONY WITH GLASS GUARDRAIL
8 STOREFRONT GLAZING
9 CANOPY ENCROACHING 6 FEET OVER PROPERTY LINE AT A HEIGHT OP 18 FEET ABOVE GRADE
10 RESIDENTIAL PARKING ENTRANCE PERFORATED OVERHEAD DOOR
11 CEMENT PLASTER
12 PAINTED CMU

RAD

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GENERAL CONTRACTOR

RAD BUILD P.O. Box 70975, OAKLAND, CA 94612 L 510.343 5593

ARCHITECT OF RECORD

RAD BUILD P.O. Box 70975, OAKLAND, CA 94612 L 510.343 5593

PROJECT DESIGN

RAD DESIGN/ SDG 230 E. OHIO ST. SUIT

CIVIL

SANDIS CIVIL ENGINEERS SURV 636 9TH STREET. OAKLAND, CA 94607

AGENCY APPROVALS

PLAN CHECK

ISSUE RECORD

1000211200112				
No.	Description	Date		
001	ZONING PRE-APPLICATION	2-10-2016		
002	BASIC APPLICATION FOR DEV. REVIEW	4-22-2016		
003	BASIC APPLICATION FOR DEV. REVIEW	7-22-2016		
004	BASIC APPLICATION FOR DEV. REVIEW	9-15-2016		
005	BASIC APPLICATION FOR DESIGN REVIEW	10-12-2016		

1433 Webster Ave.

Oakland, CA 94609

RAD BUILD P.O. Box 70975 Oakland, CA 94612 Tel: 510.343.5593

NEMO Building Systems, LLC 18231 Muprhy Pkwy Lathrop, CA 95330

ELEVATION

2

 RAD Project Number
 0001

 Date
 12, OCT 2016


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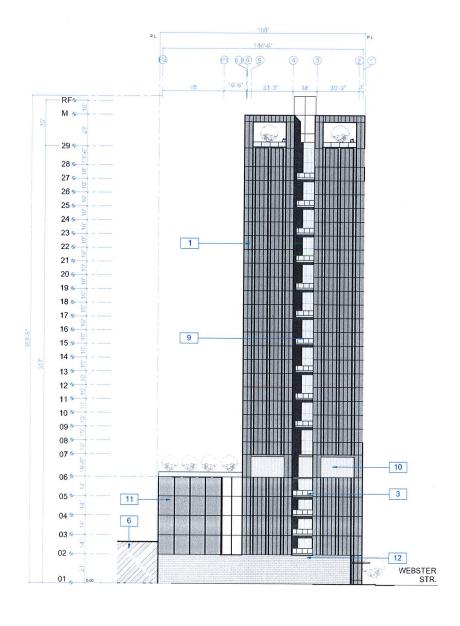
A2.0

1/16" = 1'-0"

FRONT ELEVATION (WEBSTER STREET)

SIDE ELEVATION (15TH STREET)



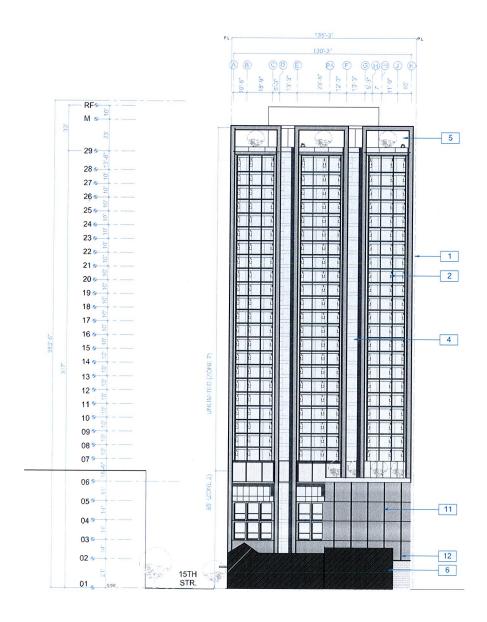





P.O. Box 70975 , Oakland, CA 9461

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OWNER

VILLAGE GLENN OAKLAND 1, LLC P.O. Box 70975, OAKLAND, CA 94612 1, 510,343,5593

GENERAL CONTRACTOR

RAD BUILD P.O. Box 70975, OAKLAND, CA 94612 L 510:343 5593

ARCHITECT OF RECORD

RAD BUILD

RAD BUILD

RAD BOX 70975 CANLAND CASE

PROJECT DESIGN

RAD DESIGN/ SDG 230 E. OHIO ST. SL

230 E. OHIO ST. SI CHICAGO, IL 6061 L 510.459 3795

VIL

6 9TH STREET. AKLAND, CA 94607 510.873.8866

AGENCY APPROVALS

PLAN CHECK #

ISSUE RECORD

1433 Webster Ave.

Oakland, CA 94609

RAD BUILD P.O. Box 70975 Oakland, CA 94612 Tel: 510.343.5593

NEMO Building Systems, LLC 18231 Muprhy Pkwy Lathrop, CA 95330

ELEVATION

RAD Project Number


Date 12, OCT 2016

A2.1

1/16" = 1'-0"

BACK ELEVATION (WEST)

SIDE ELEVATION (SOUTH LOT LINE) 2

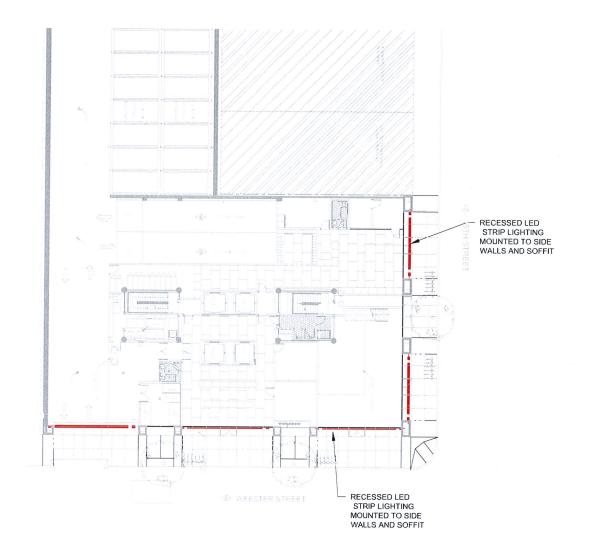



METAL SIGNAGE ATTACHED TO AN OBSCURED GLASS BACKING PANEL

SIGNAGE ILLUMINATED BY DOWNLIGHTS IN THE CANOPY



LED FEATURE LIGHTING AT THE ROOF CANOPY

31'-0" RAISED METAL SIGNAGE ATTACHED TO DOSCURED GLASS BACKING

LIGHTING



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P.O. Box 70975, OAKLAND, CA 94612
L 510,343 5593

ARCHITECT OF RECORD

RAD BUILD
P.O. Box 70975, OAKLAND, CA 94612
1, 510,343 5593

PROJECT DESIGN

PLAN CHECK #

AGENCY APPROVALS

1433 Webster Ave.

Oakland, CA 94609

RAD BUILD P.O. Box 70975 Oakland, CA 94612 Tel: 510.343.5593

NEMO Building Systems, LLC 18231 Muprhy Pkwy Lathrop, CA 95330

LIGHTING & SIGNAGE

 RAD Project Number
 0001

 Date
 12, OCT 2016


 Drawn by
 SDG

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Scale

N.T.S.

SIGNAGE



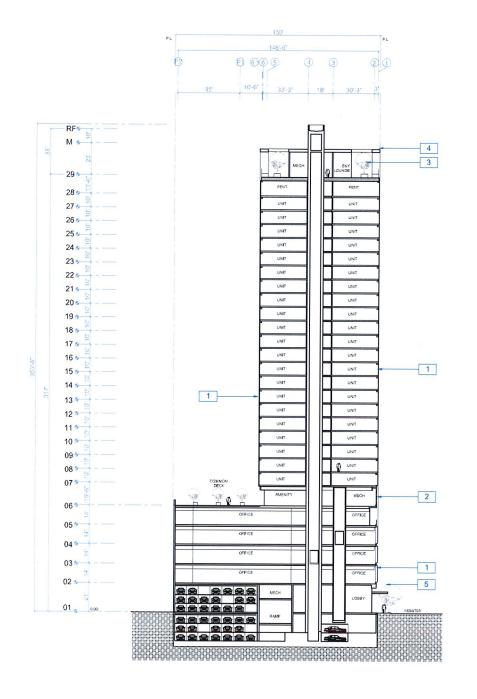



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VILLAGE GLENN OAKLAND 1, LLC P.O. Box 70975, OAKLAND, CA 94612 L 510,343,5593

GENERAL CONTRACTOR

RAD BUILD P.O. Box 70975, OAKLAND, CA 94612 L 510.343 5593

ARCHITECT OF RECORD

RAD BUILD P.O. Box 70975, OAKLAND, CA 94612 L 510:343 5593

PROJECT DESIGN

CIVIL

SANDIS CIVIL ENGINEERS SU 636 9TH STREET. OAKLAND, CA 94607 L 510.873.8866

AGENCY APPROVALS

PLAN CHECK #

1433 Webster Ave.

ISSUE RECORD

 No.
 Description
 Date

 001
 ZONING PRE-APPLICATION
 2-10-2016

 002
 BASIC APPLICATION FOR DEV. REVIEW
 4-22-2016

 903
 BASIC APPLICATION FOR DEV. REVIEW
 7-22-2016

 604
 BASIC APPLICATION FOR DEV. REVIEW
 9-15-2016

Oakland, CA 94609

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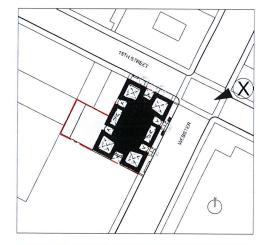
NEMO Building Systems, LLC 18231 Muprhy Pkwy Lathrop, CA 95330

SECTION

RAD Project Number 0001 Date 12, OCT 2016

1/16" = 1'-0"





GENERAL CONTRACTOR

ARCHITECT OF RECORD

RAD BUILD P.O. Box 70975, OAKLAND, CA 94612 1, 510,343 5593

PROJECT DESIGN

AGENCY APPROVALS

PLAN CHECK #

No.	Description	Date
001	ZONING PRE-APPLICATION	2-10-2016
902	BASIC APPLICATION FOR DEV. REVIEW	4-22-2016
003	BASIC APPLICATION FOR DEV. REVIEW	7-22-2016
004	BASIC APPLICATION FOR DEV. REVIEW	9-15-2016
005	BASIC APPLICATION FOR DESIGN REVIEW	10-12-2016

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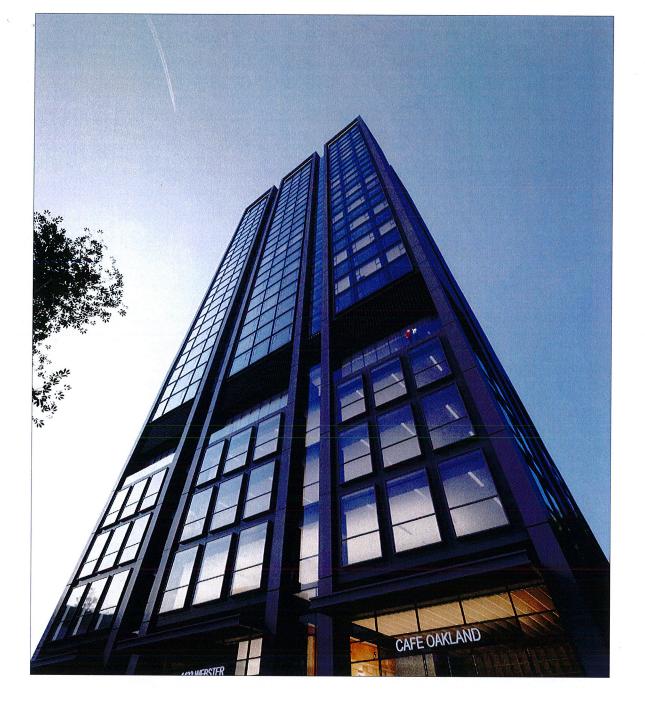
NEMO Building Systems, LLC 18231 Muprhy Pkwy Lathrop, CA 95330

RENDERING


RAD Project Number 0001 12, OCT 2016

NTS

VIEW LOOKING SOUTH ON WEBSTER



VIEW LOCATION PLAN

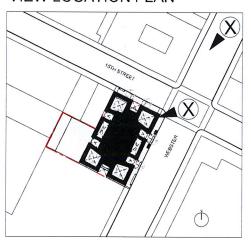



ARCHITECT OF RECORD

AGENCY APPROVALS

ISSUE RECORD Description

1433 Webster Ave. Oakland, CA 94609

RAD BUILD P.O. Box 70975 Oakland, CA 94612 Tel: 510.343.5593

NEMO Building Systems, LLC 18231 Muprhy Pkwy Lathrop, CA 95330


RENDERING

RAD Project Number

0001 12, OCT 2016

VIEW LOCATION PLAN

4 ...

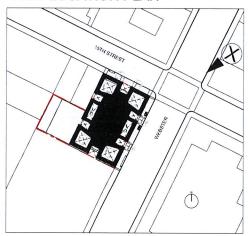

WEBSTER AND 15TH STREET



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GENERAL CONTRACTOR

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ARCHITECT OF RECORD

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PROJECT DESIGN

AGENCY APPROVALS

ENVISION

ACADEMY

OF

ARTS

TECHNOLOGY

PLAN CHECK # ISSUE RECORD Description

 No.
 Description
 Date

 001
 ZONING PRE-APPLICATION
 2:10-2016

 002
 BASIC APPLICATION FOR DEV. REVIEW
 4:22-2016

 003
 BASIC APPLICATION FOR DEV. REVIEW
 7-22-2016

 004
 BASIC APPLICATION FOR DEV. REVIEW
 9-15-2016

1433 Webster Ave.

Oakland, CA 94609

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NEMO Building Systems, LLC 18231 Muprhy Pkwy Lathrop, CA 95330

RENDERING

RAD Project Number

12, OCT 2016


NTS

0001



RETAIL AT THE CORNER OF WEBSTER AND 15TH STREET

VIEW LOCATION PLAN

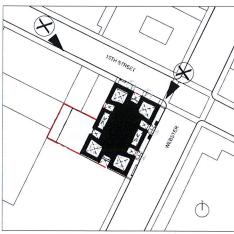



VIEW LOOKING EAST ON 15th STREET

RAD

P.O. Box 70975 , Oakland, CA 946

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OWNER

VILLAGE GLENN OAKLAND 1, LLC P.O. Box 70975, OAKLAND, CA 9461

SENERAL CONTRACTOR

RAD BUILD

P.O. Box 70975, OAKLAND, CA 94 t. 510.343 5593

ARCHITECT OF RECORD

L 510.343 5593

RAD DESIGN/ SDG

CHICAGO, IL 60611 1, 510,459,3795

. 510.459.3795

INDIS CIVIL ENGINEERS SURVEYORS, IN 8 9TH STREET. KLAND, CA 94507

AGENCY APPROVALS

PLAN CHECK #

ISSUE PECOPO

No.	Description	Date
001	ZONING PRE-APPLICATION	2-10-2016
002	BASIC APPLICATION FOR DEV. REVIEW	4-22-2016
003	BASIC APPLICATION FOR DEV. REVIEW	7-22-2016
004	BASIC APPLICATION FOR DEV. REVIEW	9-15-2016
005	BASIC APPLICATION FOR DESIGN REVIEW	10-12-201

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RAD Project Number


12, OCT 2016

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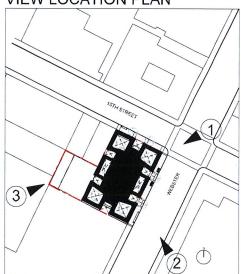
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RAD BUILD P.O. Box 70975, OAKLAND, CA

1. 510.343 5593

ARCHITECT OF RECORD

1 310,043 3503

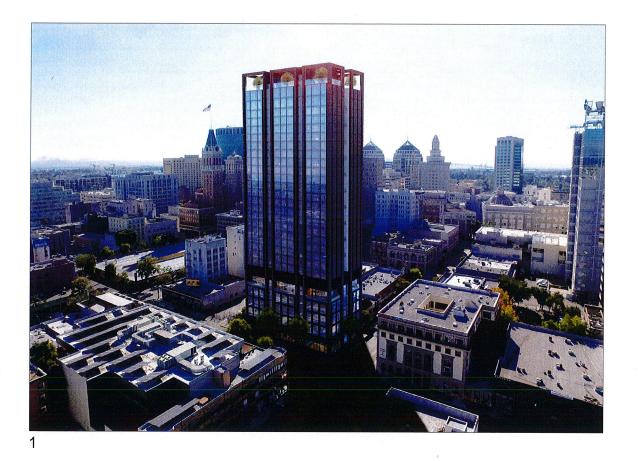RAD DESIGN/ SDG

230 E. OHIO ST. SUITE -CHICAGO, IL 60611 1,510,459,3795

CIV

SANDIS CIVIL ENGINEERS SURVEYOR 636 9TH STREET.

AGENCY APPROVALS

PLAN CHECK #

ISSUE RECORD

Description

DESCRIPTION

SOURCE PRESCRIPTION

ASSIC APPLICATION FOR DEV. REVIEW

004 BASIC APPLICATION FOR DESIGN REVIEW 0-005 BASIC APPLICATION FOR DESIGN REVIEW 10

1433 Webster Ave.

Oakland, CA 94609

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NEMO Building Systems, LLC 18231 Muprhy Pkwy Lathrop, CA 95330

RENDERING

 RAD Project Number
 0001


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 12, OCT 2016


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MATERIALS AND COLORS



GENERAL CONTRACTOR

ARCHITECT OF RECORD

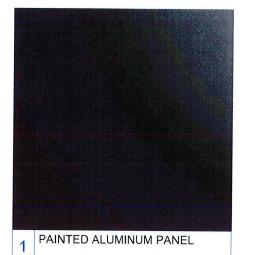PROJECT DESIGN

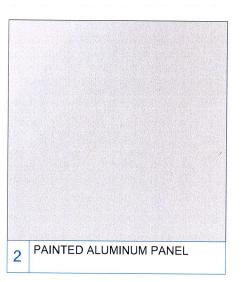AGENCY APPROVALS

ISSUE RECORD

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Oakland, CA 94609

RAD BUILD P.O. Box 70975 Oakland, CA 94612 Tel: 510.343.5593

NEMO Building Systems, LLC 18231 Muprhy Pkwy Lathrop, CA 95330

MATERIALS

RAD Project Number Date 12, OCT 2016