

# **MONTCLAIR PRESBYTERIAN CHURCH**

**5701 THORNHILL DR** OAKLAND, CA



Miller Landscape Architecture

1815 Clement Ave, SPC 24 Alameda, CA 94501 510.846.5504

### **FRAMESTUDIO**

38 WASHINGTON AVE, SUITE B POINT RICHMOND, CA 510 740 9172 www.framestud.io



EXISTING F	PLANT LEGEND	
SYMBOL	DESCRIPTION	
#1	WESTERN REDBUD	
#2	COASTAL OAK	
#3	CAMELLIA	
#4	RHODODENDRON	
#5	PITTOSPORUM	
#6	DOGWOOD	
#7	FERN	
#8	PRINCESS FLOWER	

Center Line

Equal

Diameter at Breast

Finish Grade

TOP OF BANK

Step Indicator Refer to Grading

Align with Parallel Face

Typical

With

DEMOLITI	ON LEGEND
SYMBOL	DESCRIPTION
	EXISTING PLANT TO REMAIN
$\bigcirc$	EXISTING PLANT TO BE REMOVED
	TO BE REMOVED
	LIMIT OF WORK
	AREA TO BE REMOVED

8 Feet

Scale: 1/4" = 1'-0"


#	DATE	REVISIONS	BY
1	05/27/22	PLAN CHECK RESPONSE 1	


### **DEMOLITION PLAN**



	SCALE:	1/4" = 1'-0"
A CHILL	DATE:	11/28/18
	PROJECT NO.	1098
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3./		

L-1.01

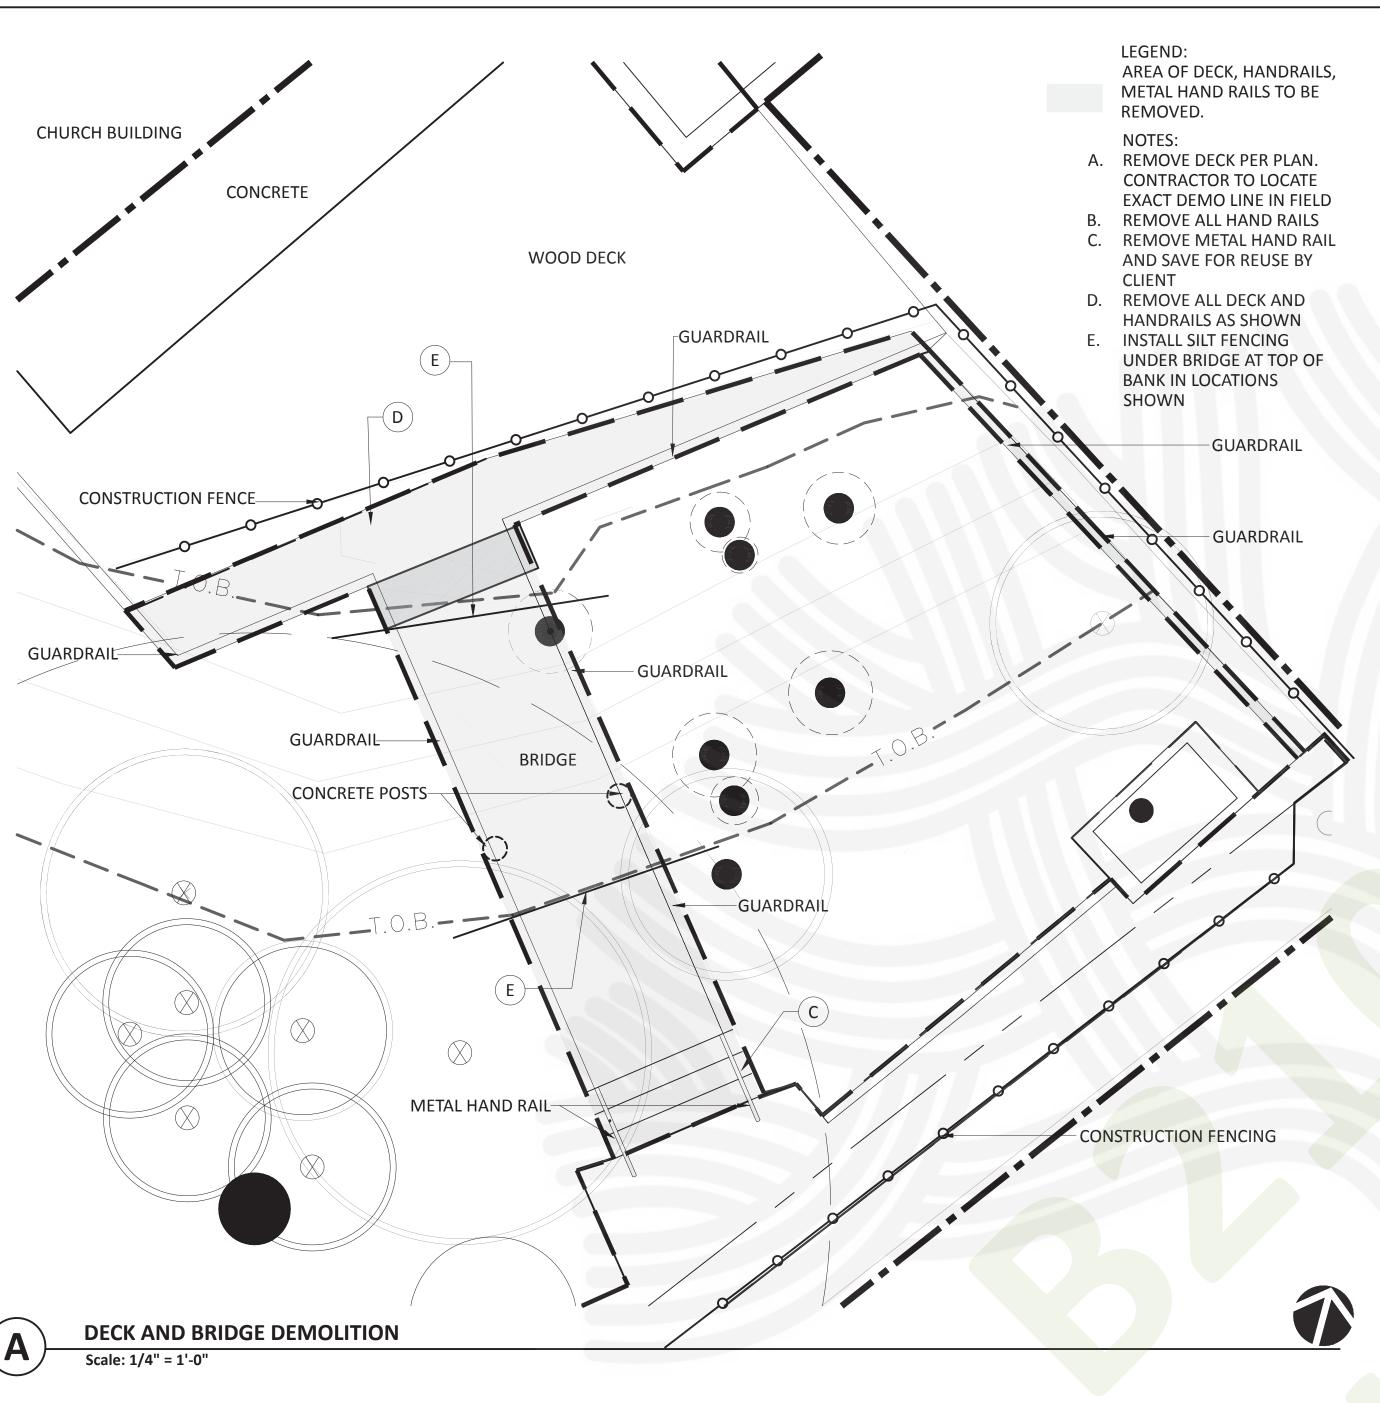

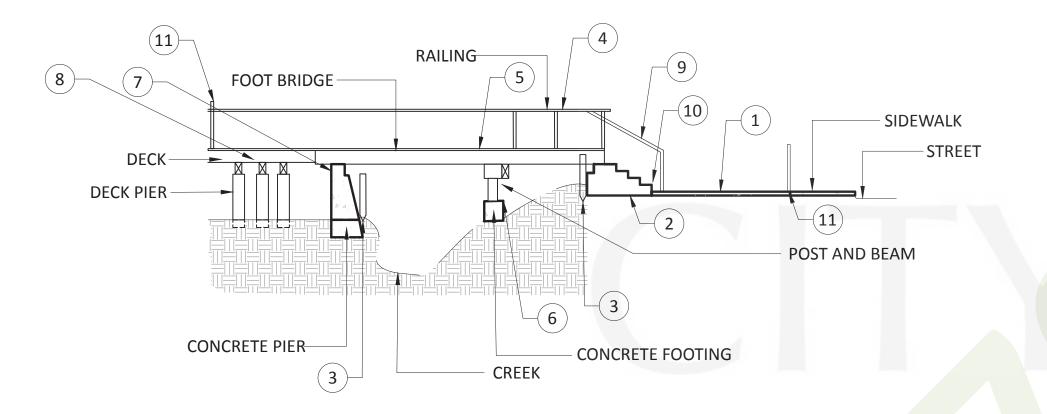

NOTES:

REMOVE CONCRETE TO SIDEWALK

AS SHOWN IN 1.01 REMOVE EXISTING ABUTMENT

INSTALL 20" - 30" SILT FENCING AT TOP OF BANK UNDER BRIDGE

REMOVE RAILING

REMOVE FOOTBRIDGE

REMOVED

CULVERT WALL.

REMOVE CONCRETE FOOTING, POST, AND BEAM

CONCRETE PIER TO REMAIN UNTIL

FUNDING IS AVAILABLE 8. REMOVE DECK PER DETAIL A

9. METAL HANDRAIL TO BE REMOVED

10. STONE AND WOOD STEPS AND STAIR CONCRETE FOOTING TO BE

11. INSTALL CONSTRUCTION FENCING AT SIDEWALK. ADD FREE-STANDING CONSTRUCTION FENCING ON DECK AND BETWEEN SIDEWALK AND DECK. ADD CONSTRUCTION FENCING ALONG WALKWAY AT

INCORPORATE **INTEGRATED PEST** MANAGEMENT TECHNIQUES INTO LANDSCAPE MANAGEMENT TO HELP PREVENT POLLUTANTS FROM **ENTERING THE** CREEK.

> **APPROVED** By Jason Madani at 3:29 pm, Jul 15, 2022

B2104815

**APPROVED CITY OF OAKLAND BUILDING SERVICES** 

**PLAN CHECK SECTION** For Substantial Compliance With Codes and Ordinances

**REVISIONS NEED APPROVAL** 

Subject to CBC Sections 105.4, 107.3 and CRC R105.4 and R106.3

SURVEY (REVIEW ONLY) PLOT PLAN REVIEW PARKING/DRIVEWAY LAYOUT **GRADING & EROSION CONTROL** 

**ELEC/MECH/PLUMB NOT CHECKED** 

SOILS REPORT ON FILE

06/08/2022

### **DEMOLITION NOTES**

- A. INSTALL SILT FENCE AND WATTLES AND CONSTRUCTION FENCING PRIOR TO BEGINNING WORK.
- B. INSTALL PROTECTIVE TARP UNDER WORK AREA, INCLUDING UNDER BRIDGE BEFORE ANY DEMOLITION TAKES PLACE. MAINTAIN TARP THROUGHOUT ALL DEMO WORK. VACUUM AND/OR REMOVE ANY SAWDUST OR WOOD DEBRIS THAT FALLS INTO TARP OR OUTSIDE AREA. SEE NOTE L (BELOW) FOR TARP INSTALLATION
- MINIMIZE CUTTING OF STRUCTURE IN PLACE. WHEN MAKING CUTS, UTILIZE MINIMAL DUST PROTOCOLS. USE CITY OF OAKLAND'S BEST PRACTICES FOR DUST CONTROL. SIMULTANEOUSLY VACUUM SAW CUT DEBRIS WHILE CUTTING.
- D. REMOVE RAILINGS IN THREE (3) PIECES OR LESS ON EACH SIDE, IF POSSIBLE.
- REMOVE BRIDGE DECK BOARDS BY HAND
- HAND RAILS AND POSTS AT CULVERT TO BE REMOVED. STONE TOP OF CULVERT WALL TO REMAIN
- CUT AND REMOVE BRIDGE JOISTS. CUT AT DECK SIDE AND CUT AT INTERMEDIATE BEAM FIRST. THEN, PULL OUT FRAMING TOWARD STREET AND CONTINUE ANY DISMANTLING ON SIDEWALK
- H. LARGE DECK PIER ON NORTH SIDE OF FOOTBRIDGE TO BE REMOVED WHEN FUNDING IS AVAILABLE
- WHEN REMOVING CONCRETE FOOTINGS UNDER FOOTBRIDGE (SEE DETAIL B), DO NOT DISTURB EMBANKMENT
- INTERMEDIATE BEAM, POSTS, AND FOOTINGS TO BE REMOVED
- K. ENTIRE FOOTBRIDGE TO BE REMOVED
- TARP SHALL BE TIED ON FOUR EDGES TO CATCH SAWDUST AND NAILS THAT MAY FALL. TARP SHALL BE 16' X 30' MINIMUM. TARP SHALL BE FOLDED CAREFULLY TO ENSURE THAT DEBRIS DOES NOT
- M. DO NOT DISTURB CREEK BANK OR BED DURING DEMOLITION PREVENTION MEASURES SHALL BE TAKEN TO PREVENT ANY MATERIAL FROM ENTERING THE CREEK ZONE. ACCESS TO T.O.B. SHALL BE RESTRICTED EXCEPT WHEN ABSOLUTELY NECESSARY. N. INSTALL CONSTRUCTION FENCING AT TOP OF CREEK BANK. SEE
- REMOVE ALL PLANT MATERIAL NOT DESIGNATED TO BE RETAINED WITHIN LIMIT OF WORK. THIS INCLUDES ALL ENGLISH IVY,
- NON-NATIVE GRASSES, AGAPANTHUS, HIMALAYAN BLACKBERRY, AND ANY OTHER INVASIVE SPECIES. ALL STEM, ROOT, AND CORM MATERIAL TO BE REMOVED AND PROPERLY DISPOSED OF OFF SITE.
- P. DISTURBANCE TO NATIVE SHRUBS, WOODY PERENNIALS, FERNS, OR TREE REMOVAL ON THE STREAMBANK OR IN THE STREAM CHANNEL WILL BE AVOIDED OR MINIMIZED TO THE FULLEST EXTENT POSSIBLE.
- PEACE POLE SHALL BE REMOVED BUT KEPT FOR RE-USE BY CLIENT R. ALL DEMO WORK WILL FOLLOW CITY OF OAKLAND'S STANDARD
- **CONDITIONS OF APPROVAL** S. ALL PROTECTIVE MATERIAL SHALL BE REMOVED AT COMPLETION OF
- WORKER TRAINING ON BEST PRACTICES SHALL OCCUR BEFORE
- WORK COMMENCES BY A QUALIFIED BIOLOGIST U. ALL WORK SHALL FOLLOW REGIONAL WATER CONTROL BOARD STORMWATER DISCHARGE PERMIT BEST MANAGEMENT PRACTICES
- FOR CONSTRUCTION SITES V. IF FOLLOW-UP CHEMICAL TREATMENT OF INVASIVE SPECIES IS REQUIRED, MUST BE APPLIED AND TIMED SO AS NOT TO INTERFERE WITH ESTABLISHMENT OF NEW NATIVE PLANTINGS
- W. TOP OF BANK EAST OF BRIDGE IS NOT NOTED ON SURVEY. TOB IN THIS SECTION IS ASSUMED. TOP OF BANK IS APPROXIMATE. DO NOT

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1	05/27/22	PLAN CHECK RESPONSE 1	
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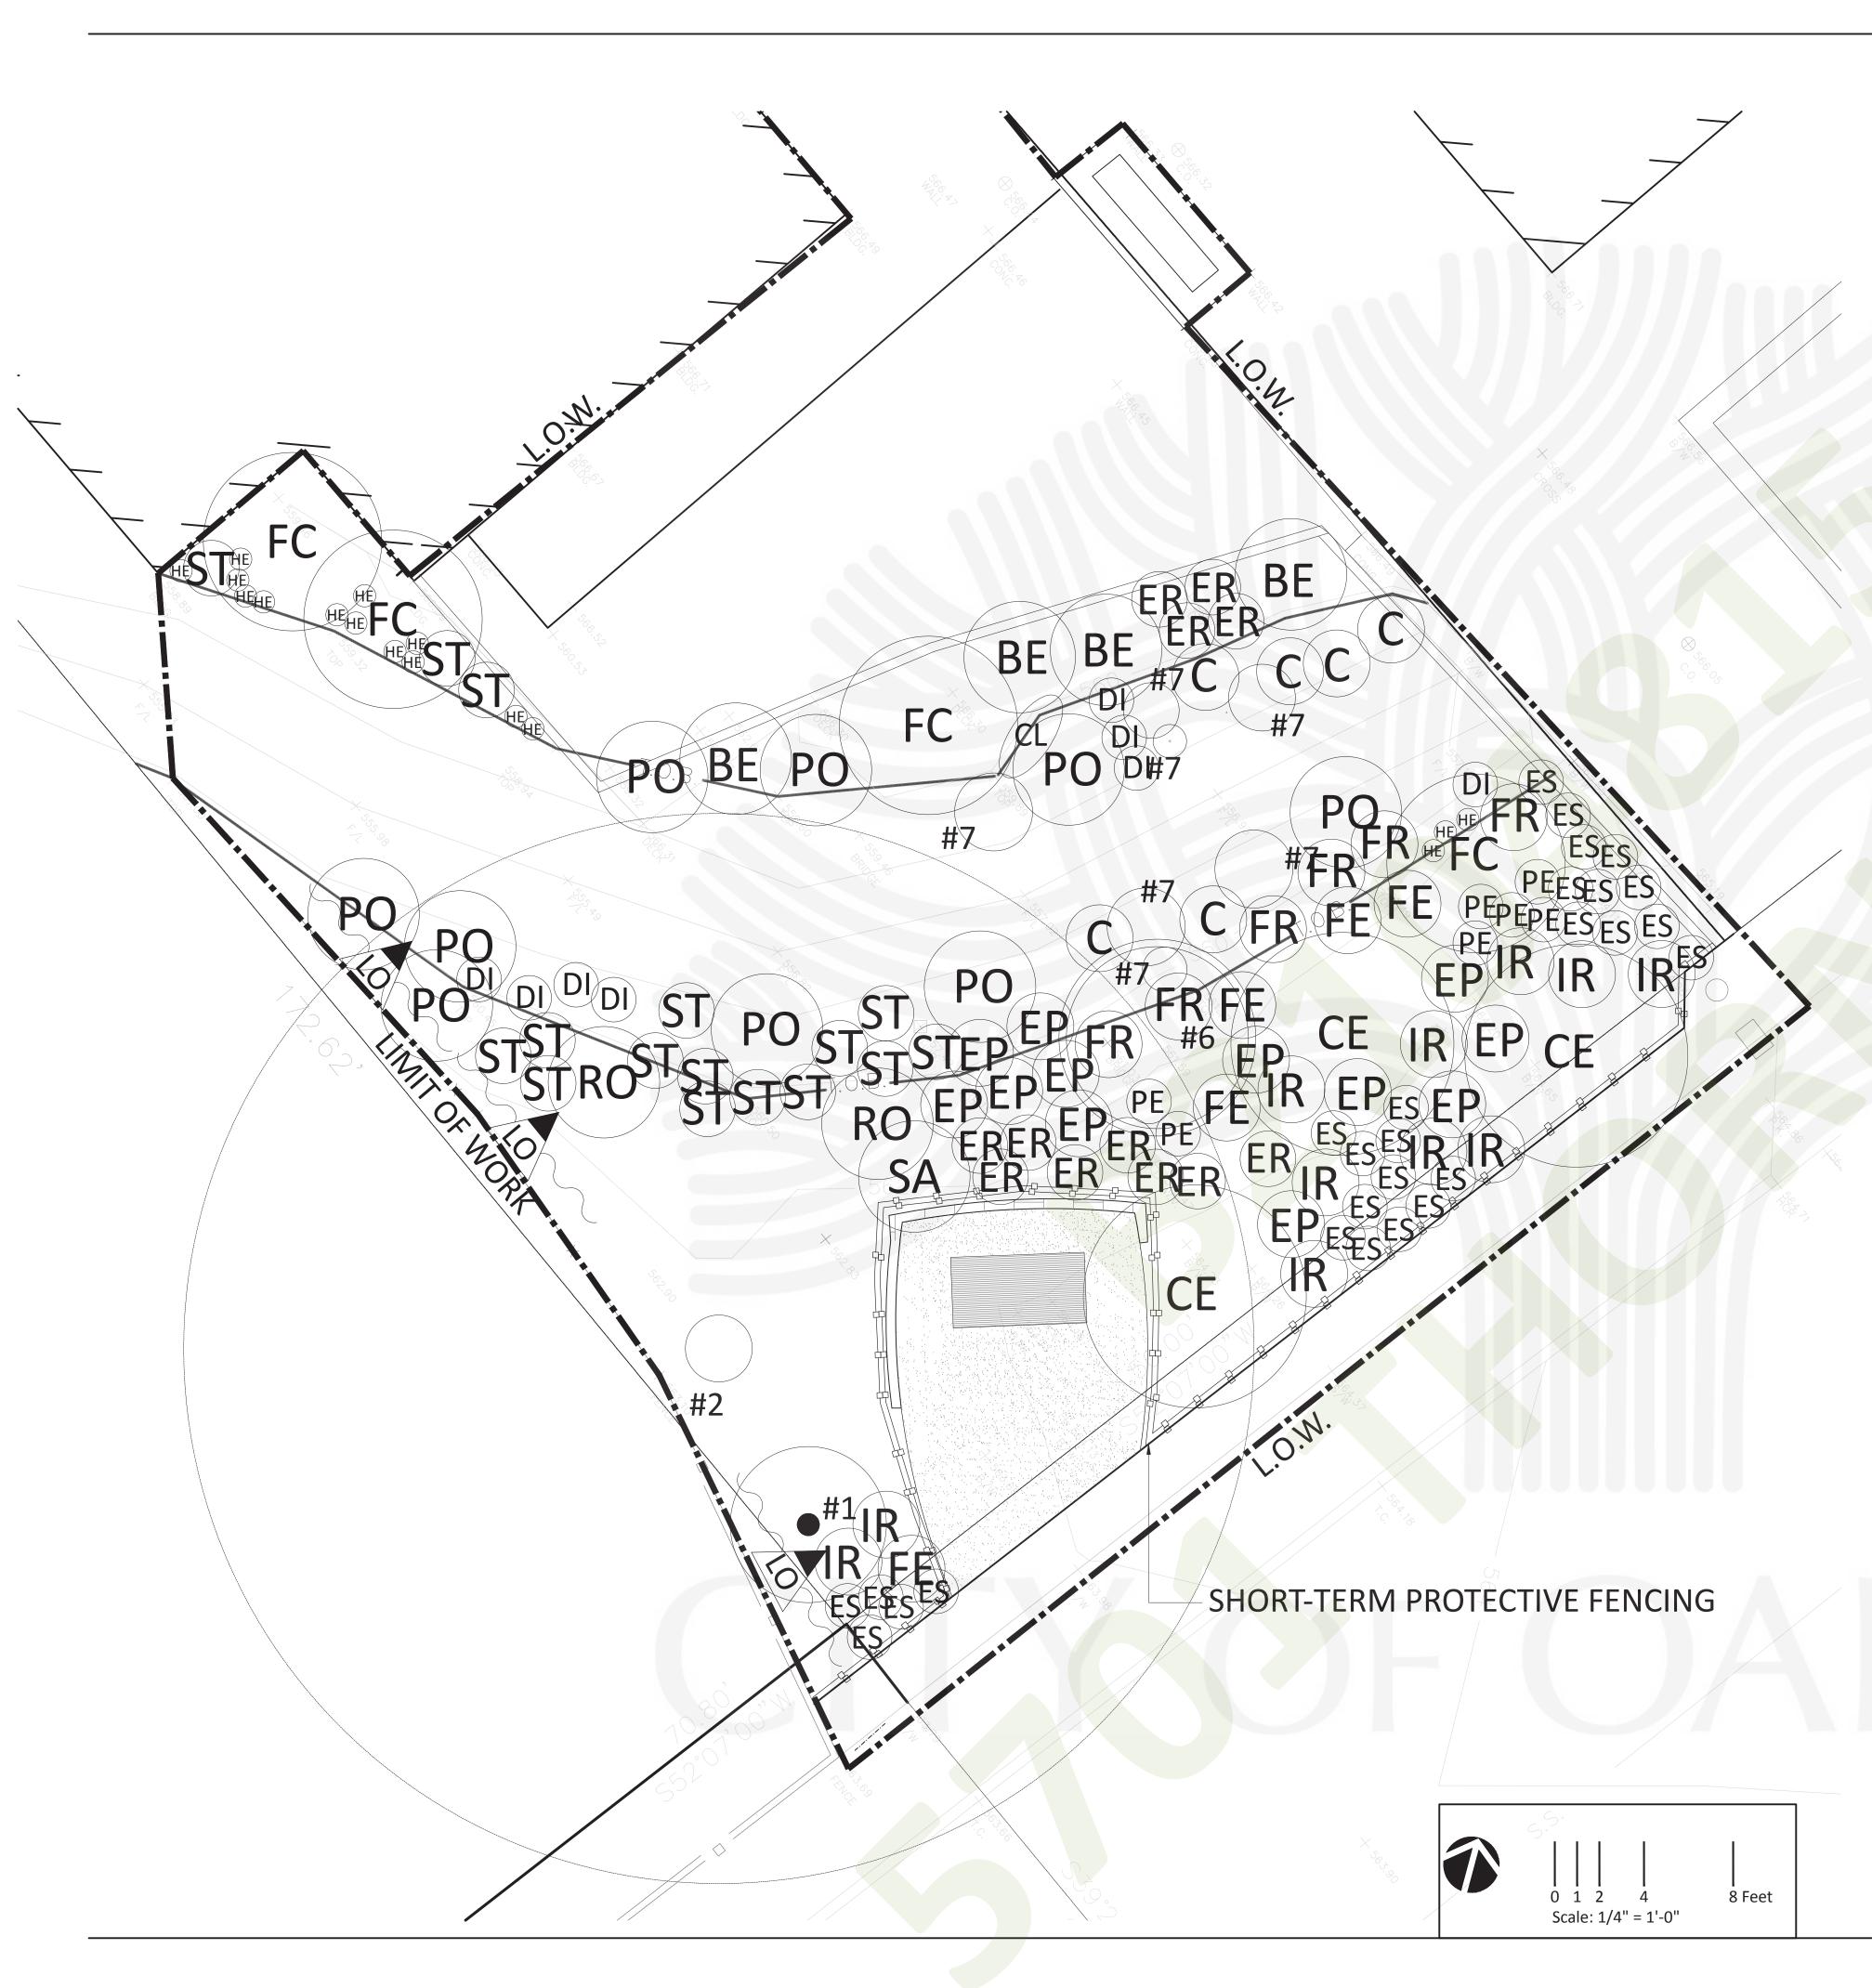
### **DEMOLITION PLAN**



1/4" = 1'-0" SCALE: DATE: 11/28/18 1098 PROJECT NO. **DRAWN BY:** 

L-1.02

**FOOTBRIDGE DEMOLITION** Scale: 1/8" = 1'-0"



SYMBOL	BOTANICAL NAME / COMMON NAME	QUANTITY	SIZE	WUCOLS
BE	Berberis pinnata / Coast Barberry	4	5 Gal.	Low
(C)	Carex nudata / Torrent Sedge	6	1 Gal.	Moderate / High
CE	Ceanothus thyrsiflorus var. repens / Creeping Blueblossum ceanothus	3	5 Gal.	Low/Mod
CL	Clematis ligustacifolia / Western Virgin's Bower	1	5 Gal.	Low/Moist
DI	Dicentra formosa / Bleeding Hearts	8	1 Gal.	Moderate
(EP)	Epilobium canum / California Fuchsia	12	1 Gal.	Low/Mod
ER	Eriogonum grande var. rubescens / Rosey Buckwheat	6	1 Gal.	Low/Mod
ES	Eschscholzia californica / California Poppy	27	1 Gal.	Low/Mod
FE	Festuca californica / California Fescue	5	1 Gal.	Moderate
FR	Fragaria vesca var. californica / Woodland Strawberry	6	1 Gal.	Moderate
FC	Frangula californica / Coffeeberry	4	5 Gal.	Low/Mod
HE	Heuchera micrantha / Alum Root	16	1 Gal.	Low/Mod
(IR)	Iris douglasiana / Douglas Iris	11	1 Gal.	Low / Moderate
~~ <u>^</u>	Lonicera hispidula / California Honeysuckle	3	5 Gal.	Mod/Reg
PE	Penstemon heterophyllus 'Margarita Bop' / Margarita Bop Penstemon	7	1 Gal.	Low/Mod
RO	Rosa californica / California Rose	2	5 Gal.	Moderate / High
SA	Satureja douglasii / Yerba Buena	1	5 Gal.	Low / Moderate
(ST)	Stachys bullata / California Wood Mint	16	1 Gal.	Moderate / High
PO	Polystichum munitum / Sword Fern	9	1 Gal.	Low

### **EXISTING PLANT LEGEND** SYMBOL DESCRIPTION WESTERN REDBUD COASTAL OAK CAMELLIA-REMOVED RHODODENDRON-REMOVED PITTOSPORUM-REMOVED DOGWOOD **FERN**

PRINCESS FLOWER-REMOVED

### **APPROVED** By Jason Madani at 3:29 pm, Jul 15, 2022

#### **PLANTING PLAN**

- **NOTES** A. TOP OF BANK (T.O.B.) EAST OF BRIDGE IS NOT NOTED ON SURVEY. T.O.B. IN THIS LOCATION
- B. FINAL PLANT LOCATIONS TO BE DETERMINED IN FIELD. MINOR ADJUSTMENTS MAY BE REQUIRED DUE TO EXISTING OBSTRUCTIONS
- C. DEER PROTECTION TO BE PROVIDED FOR PLANTS AT RISK. SEE PLANTING DETAIL FOR DEER PROTECTION PROTOCOLS
- D. ALL SOIL MIXTURES, PLANTING OPERATIONS AND PLANTS MUST FOLLOW SOIL DECONTAMINATION PROTOCOLS, BEST MANAGEMENT PROTOCOLS, AND TESTING REQUIREMENTS TO REDUCE THE POSSIBILITY OF THE SPREAD OF SUDDEN OAK DEATH
- RESTRICT PLANTING IN AREAS AT RISK OF S.O.D. TO THE DRY SEASON (MAY OCTOBER) OR DURING DRY SPELLS IF ADHERENCE TO THIS SCHEDULE IS NOT FEASIBLE
- F. USE CERTIFICATION AND/OR TESTING TO DOCUMENT THAT NURSERY STOCK THAT IS BROUGHT INTO THE SITE IS FREE OF PHYTOPHTHORA SPECIES
- G. DO NOT PLANT ADDITONAL CALIFORNIA BAY WITHIN THE PROJECT AREAS
- H. THE SITE PLANTINGS WILL REQUIRE IRRIGATION FOR AT LEAST THE FIRST 3 YEARS DURING DEPEND ON SITE CONDITIONS, THE PLANT SPECIES INSTALLED, COST, AND OTHER CONSIDERATIONS. DRIP AND BUBBLER IRRIGATION SYSTEMS ARE RECOMMENDED. AFTER THE FIRST YEAR FOLLOWING PLANT INSTALLATION (YEAR 1), THE PLANTS SHOULD BE IRRIGATED WITH ENOUGH REGULARITY TO KEEP THE SOILS WITHIN THE ROOT ZONE MOIST FROM APPROXIMATELY MARCH THROUGH OCTOBER. THE IRRIGATION SCHEDULE IN YEAR 2 SHOULD BE BASED ON THE WATER REQUIREMENTS OF THE PLANTS AND IS ANTICIPATED TO BE CONSIDERABLY LESS. IN YEAR 3, MINIMAL IRRIGATION SHOULD BE REQUIRED. THE PROGRESS OF THE PLANTS SHOULD BE CONSIDERED BEFORE IRRIGATION IS REDUCED FURTHER OR DISCONTINUED FOLLOWING YEAR 3.
- SHORT-TERM PROTECTIVE FENCING TO SURROUND DG/BENCH AREA TO PREVENT FOOT TRAMPLING. FENCING TO BE LEFT IN PLACE FOR AT LEAST ONE YEAR AND UNTIL PLANTINGS ARE ESTABLISHED.

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510.846.5504

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#	DATE	REVISIONS	BY
$\Lambda$	05/27/22	PLAN CHECK RESPONSE 1	


PLANTING PLAN




ANDSCAPE	SCALE:	1/4" = 1'-0"
Miller Licence ACH	DATE:	11/28/18
ME / B	PROJECT NO.	1098
Repowal Date 9	DRAWN BY:	DS
OF CALIFORNI		

L-2.01

### 4' - 0" - 6" WIRE HOLDDOWN STAPLE WEED CONTROL FABRIC NON-CORROSIVE WIRE FASTENER 3 PER CAGE WATER RETENTION BERM 6" STEEL TEE POST, 3 PER CAGE 60" WELDED WIRE FENCE 6X6X12 ga WATER FLOW PLAN

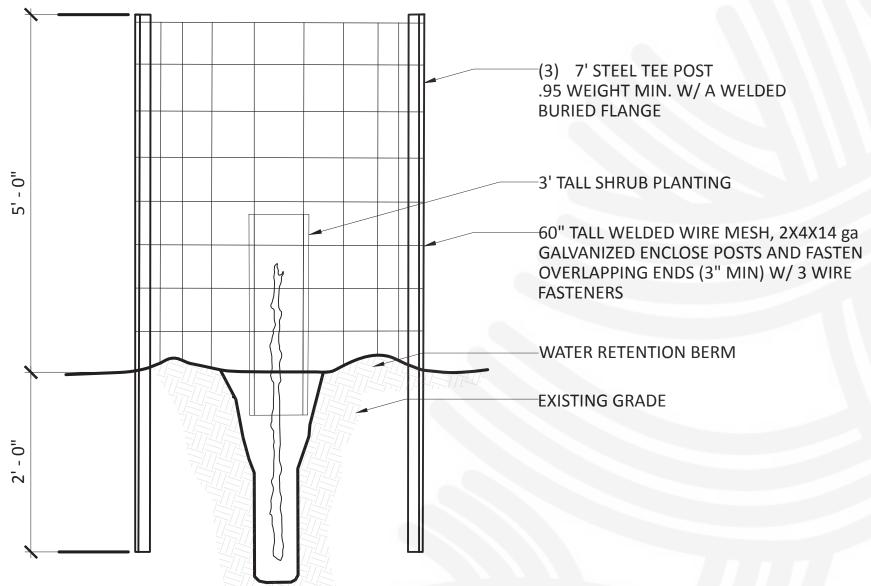

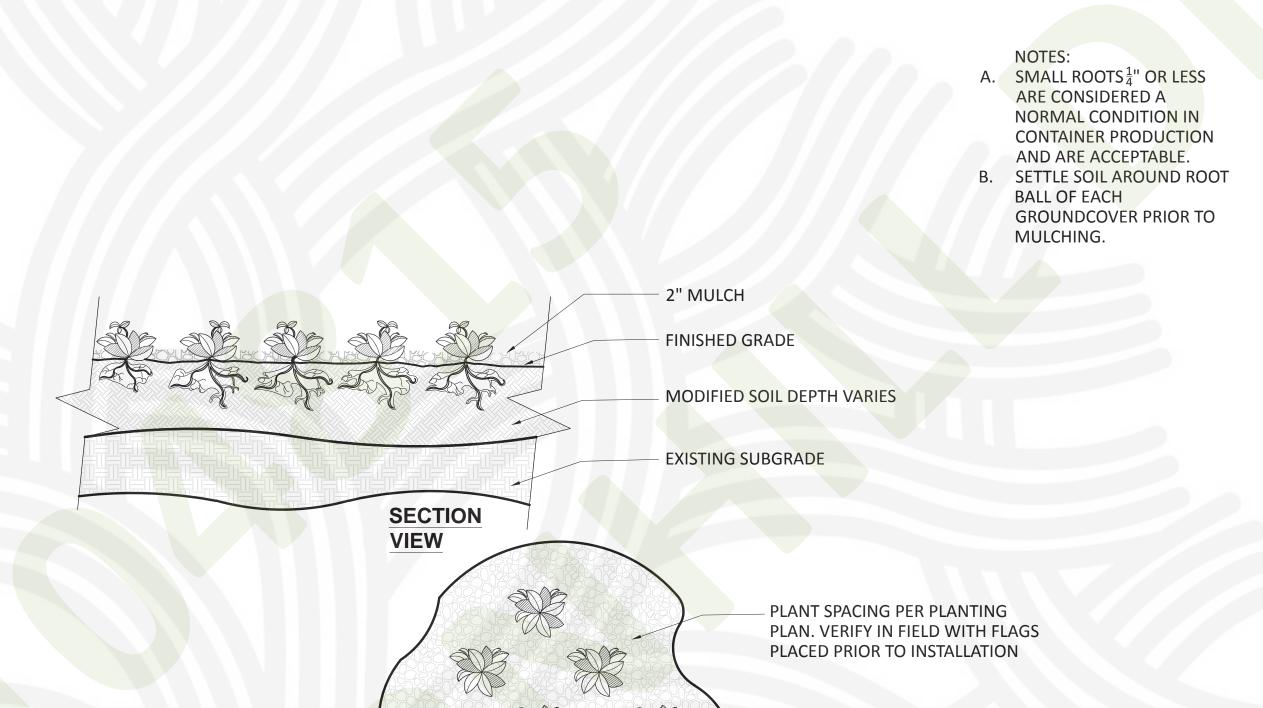

PLAN

2" MULCH

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#	DATE	REVISIONS	BY
1	05/27/22	PLAN CHECK RESPONSE 1	
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PLANTING DETAILS



AS NOTED 11/28/18 DRAWN BY:

L-2.02



GROUNDCOVER PLANTING


Scale: 1/4" = 1'-0"

3" HIGH BY 36" DIAMETER WATER RETENTION BASIN, CONTINUOUS. BASIN
MAY BE EXCAVATED AS NECESSARY TO
PROVIDE SUFFICIENT SOIL AT DEPTH WEED CONTROL MULCH TO COMPLETELY COVER WATER RETENTION BASIN EXISTING GRADE VARIES WITH SLOPE - UNDISTURBED SUBGRADE

**PLANTING DETAIL** 

**DEER PROTECTION DETAIL** 

Scale: 3/4" = 1'-0"

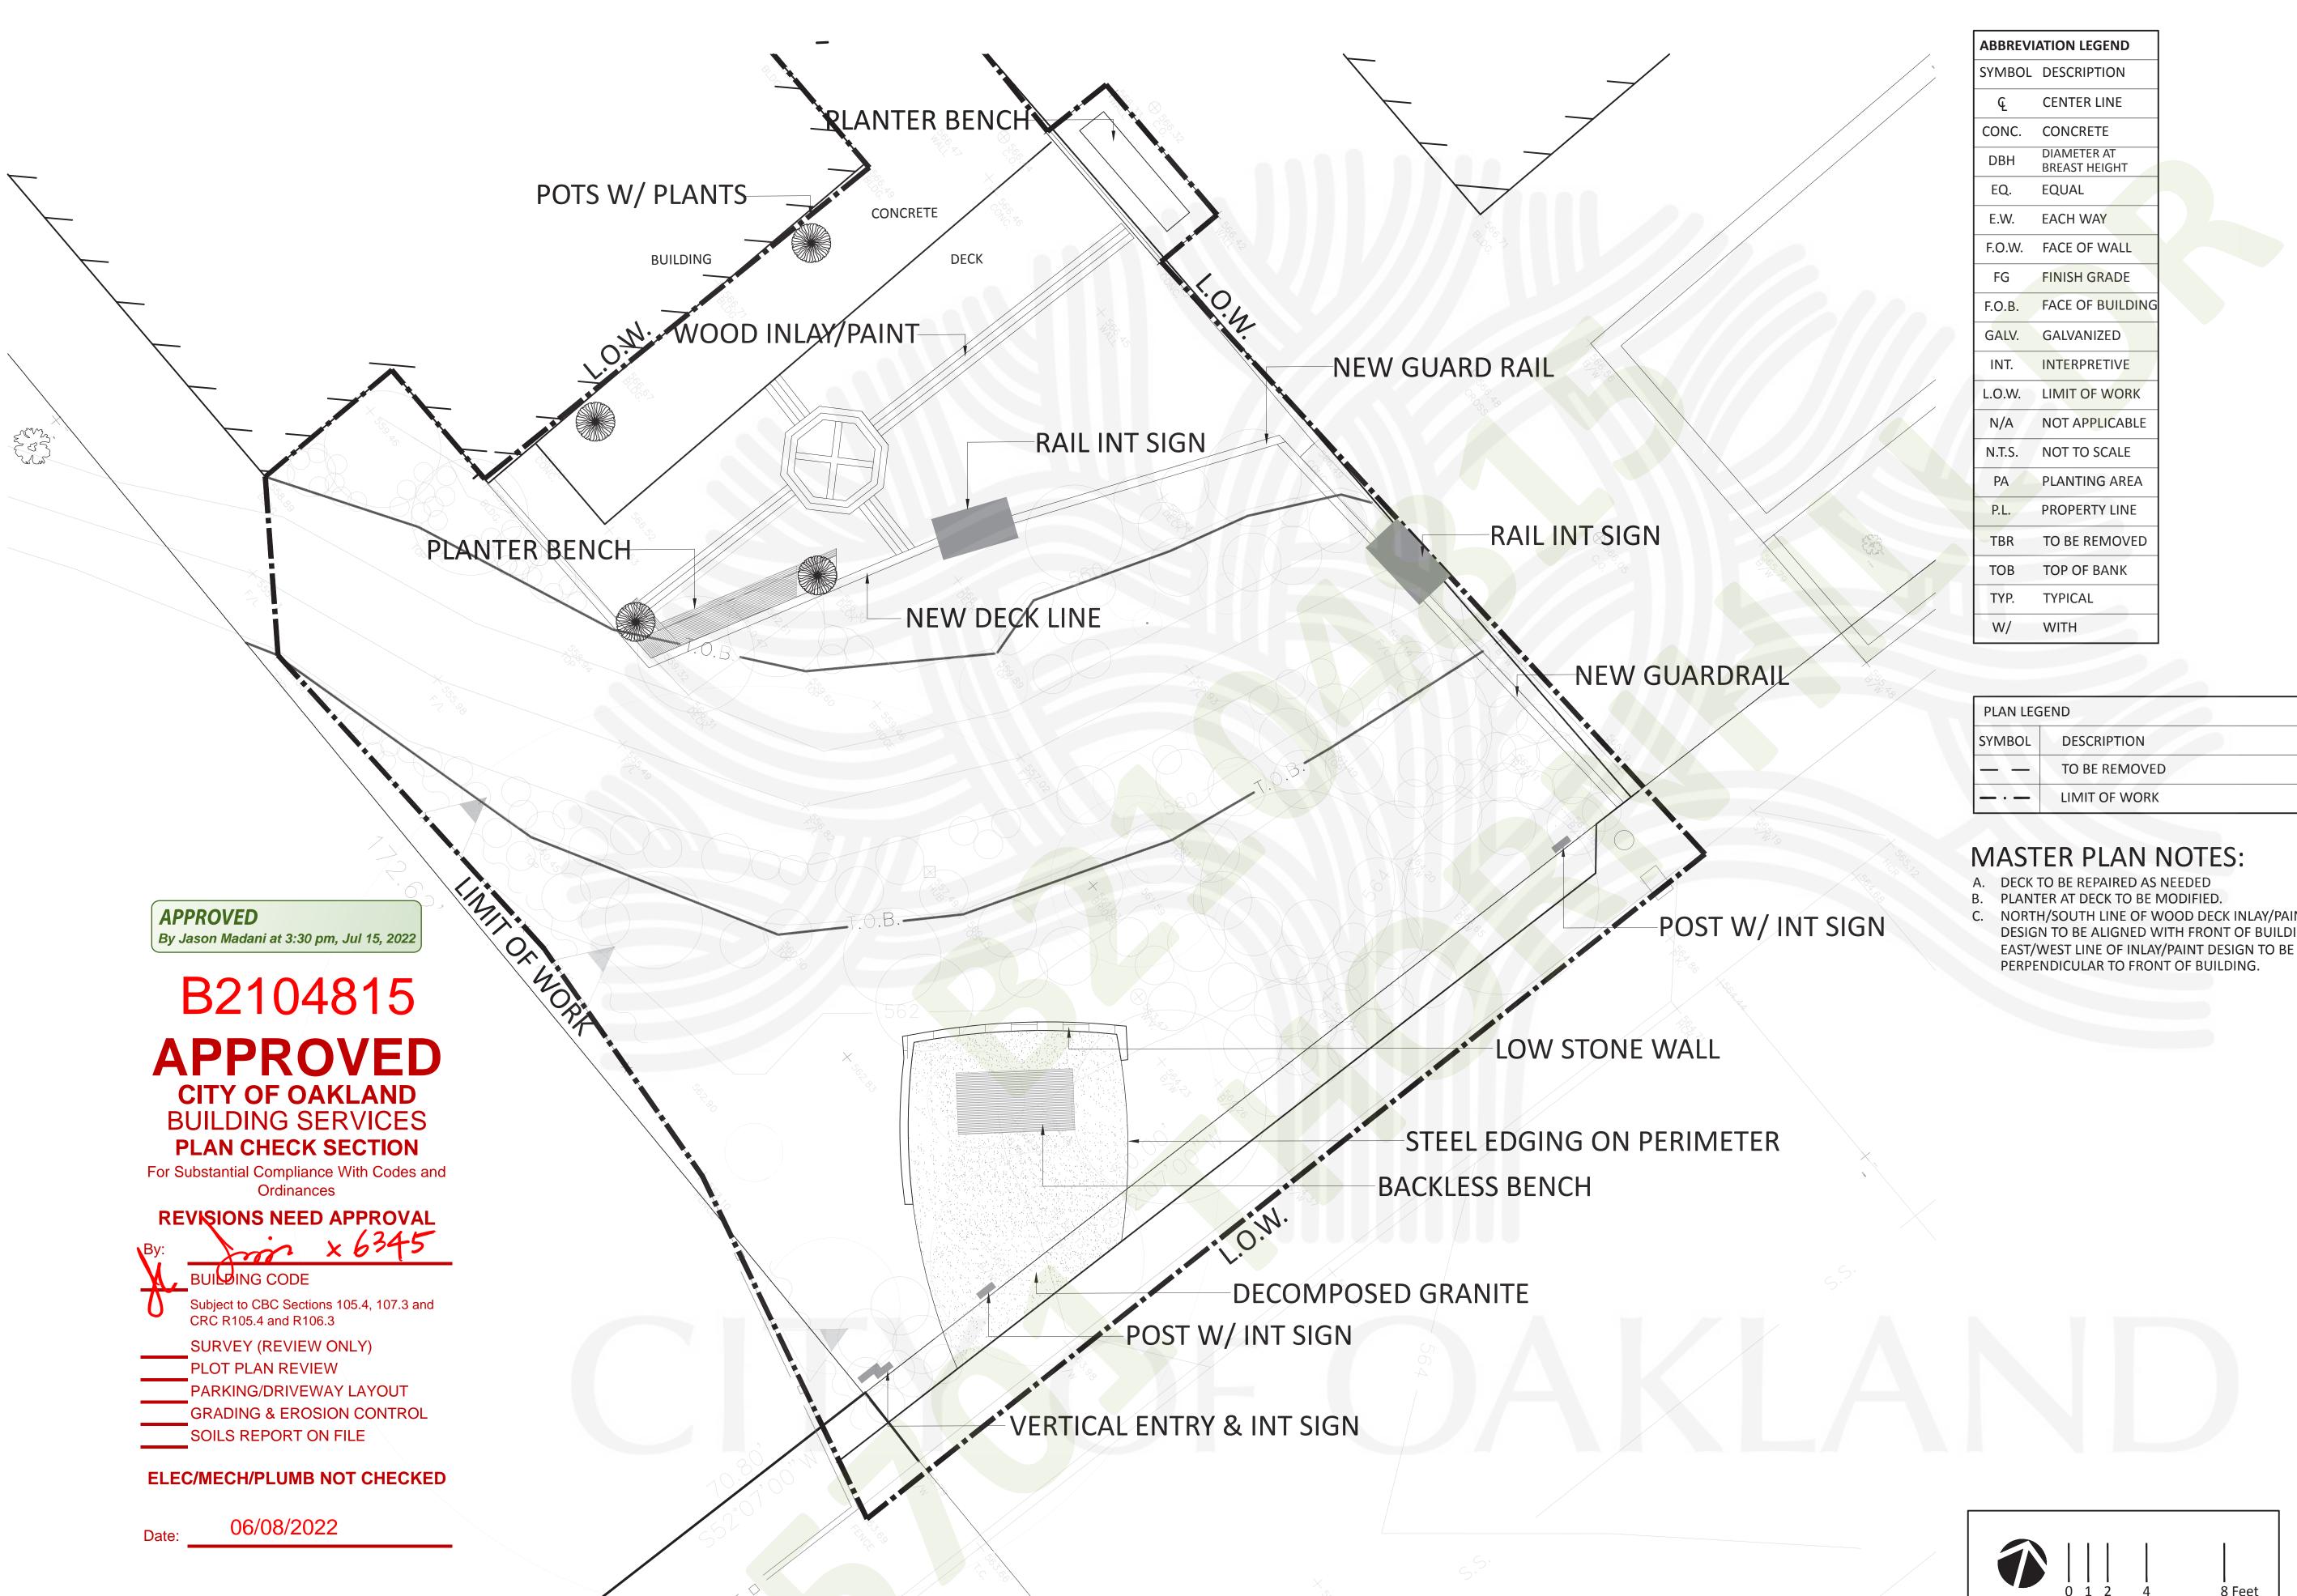

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PLAN LEGEND DESCRIPTION TO BE REMOVED LIMIT OF WORK

### **MASTER PLAN NOTES:**

A. DECK TO BE REPAIRED AS NEEDED

**CENTER LINE** 

DIAMETER AT BREAST HEIGHT


B. PLANTER AT DECK TO BE MODIFIED. C. NORTH/SOUTH LINE OF WOOD DECK INLAY/PAINT

8 Feet

Scale: 1/4" = 1'-0"


DATE	REVISIONS	BY
05/27/22	PLAN CHECK RESPONSE 1	
		PLAN CHECK

### MASTER PLAN

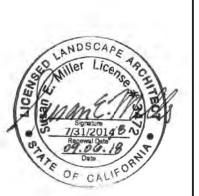

	SCALE:	1/4" = 1'-0"
20	DATE:	11/28/18
9	PROJECT NO.	1098
	DRAWN BY:	DS

L-3.01

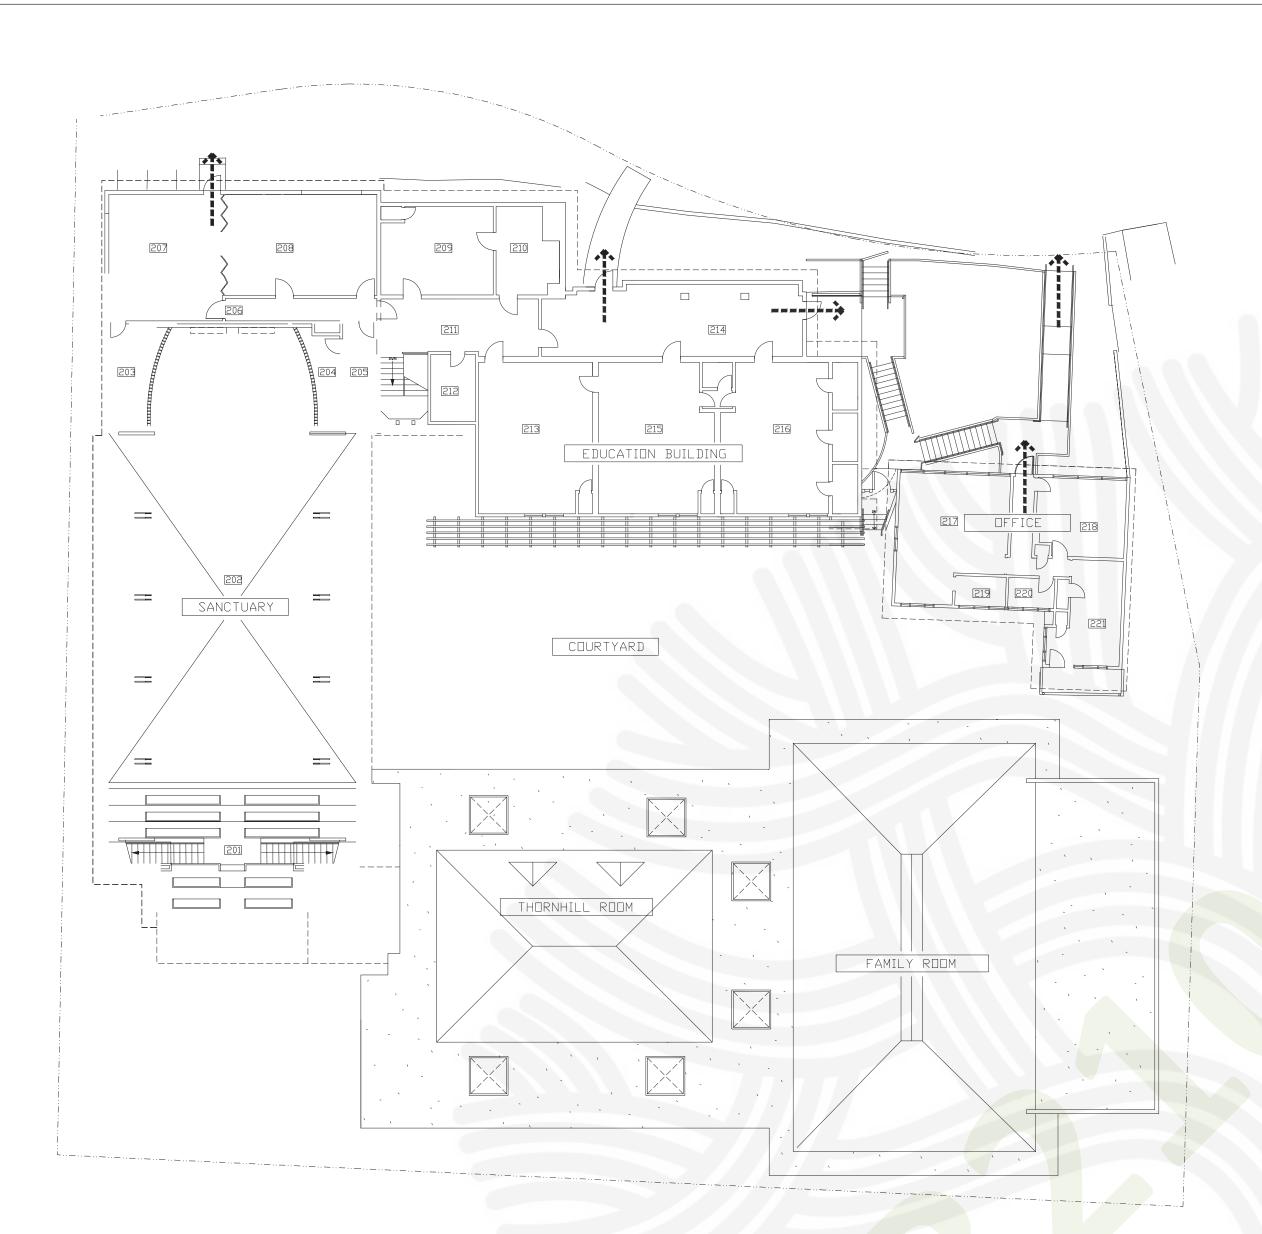

B2104815 SECOND FLOOR EXITING PLAN - FOR REFERENCE ONLY APPROVED

1/16"=1'-0"

CITY OF OAKLAND **BUILDING SERVICES PLAN CHECK SECTION** 

For Substantial Compliance With Codes and Ordinances

**REVISIONS NEED APPROVAL** 




Subject to CBC Sections 105.4, 107.3 and CRC R105.4 and R106.3

SURVEY (REVIEW ONLY) PLOT PLAN REVIEW PARKING/DRIVEWAY LAYOUT GRADING & EROSION CONTROL SOILS REPORT ON FILE

**ELEC/MECH/PLUMB NOT CHECKED** 

06/08/2022

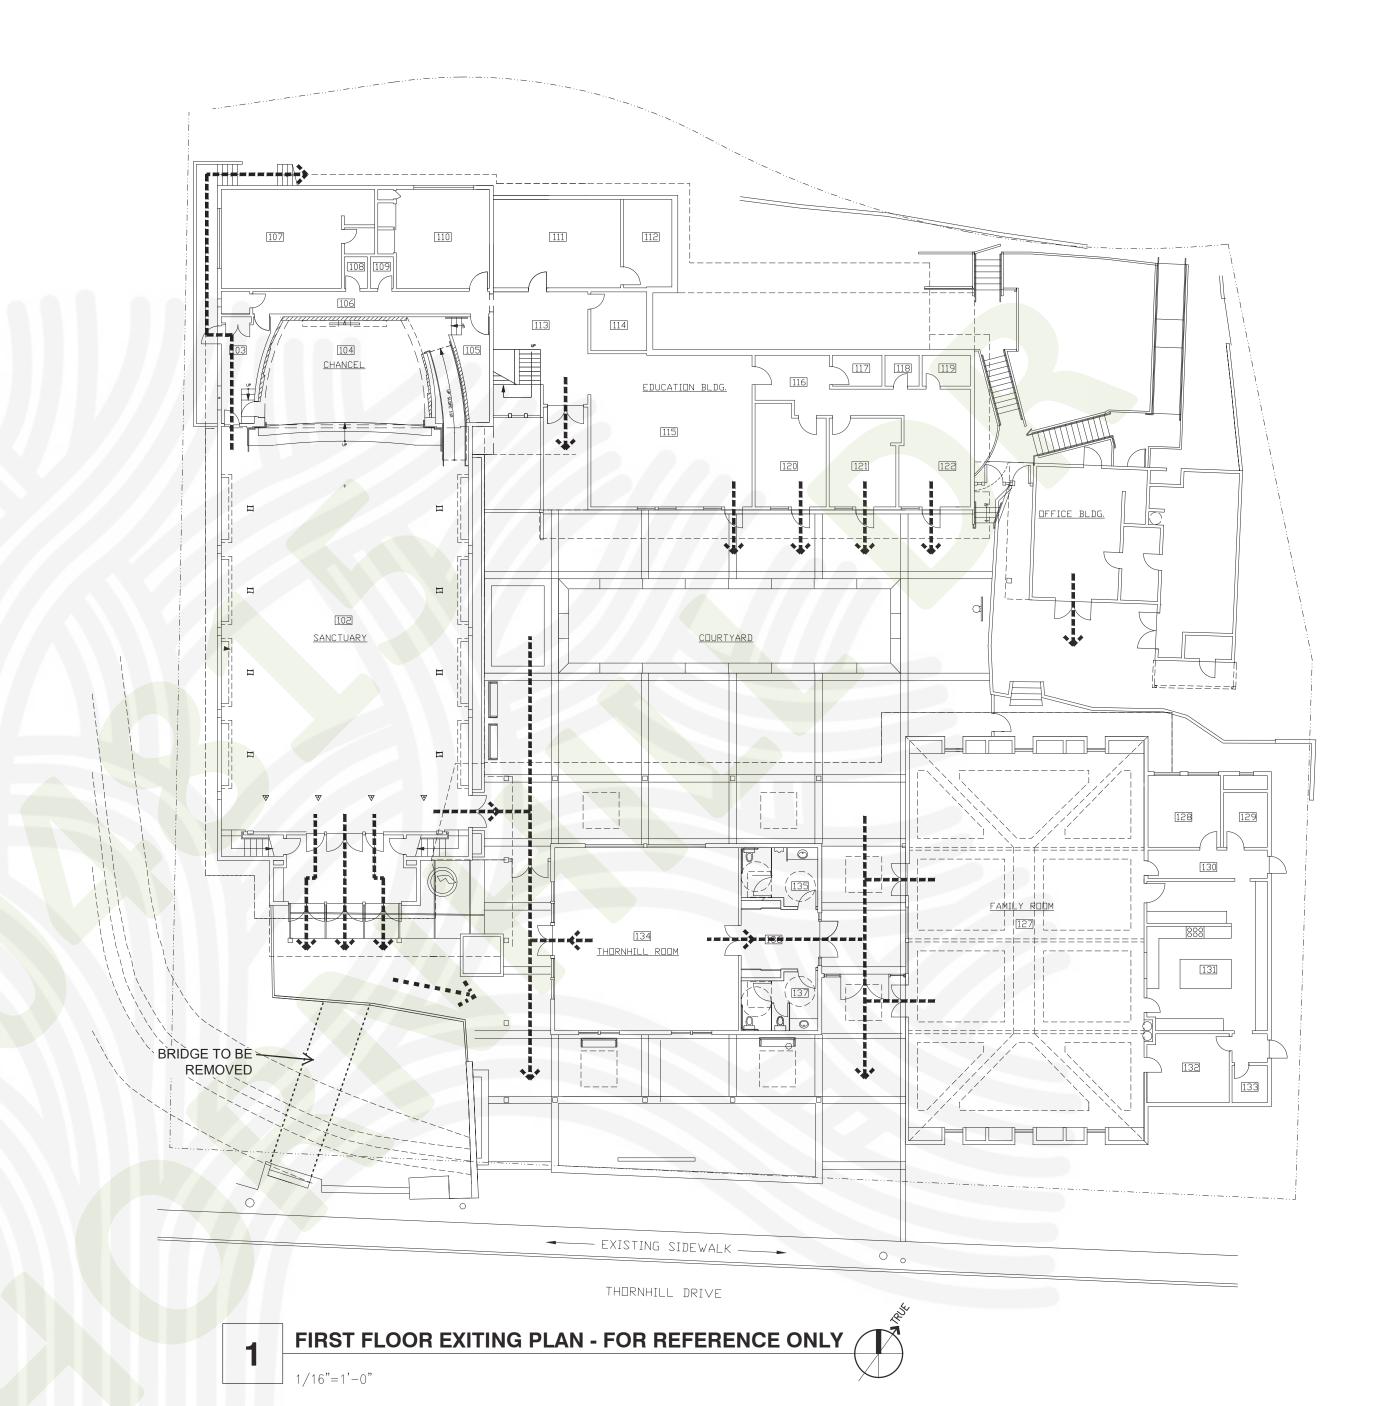

(E) OCCUPANCY GROUPS - NO CHANGE	PROJECT DAT	ΓΑ
SANCTUARY: GROUP A-2 (E) 4,595 SQ FT INCLUDING BALCONY AND ORGAN LOFT	ASSESSOR'S PARCEL NO.: ZONING CLASSIFICATION:	48G-7420-9-2 RH-4
EDUCATION BUILDING: GROUP E-3 (E) 8,263 SQ FT ON TWO FLOORS	LAND USE DESIGNATION:	CHURCH
OFFICE BUIILDING: GROUP B (E) 1,891 SQ FT	LOT SIZE:  CONSTRUCTION TYPE:	31,612 SF TYPE V
FAMILY ROOM: GROUP A-3 (E) 3,872 SQ FT	GROSS AREA:	(E) 20,000 SQ FT IN FIVE BUILDINGS - NO CHANGE
THORNHILL ROOM: GROUP B (E) 1,429 SQ FT		
LEGEND		
(E) EXIT ACCESS		
(L) L/III /100230		



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#### **MONTCLAIR PRESBYTERIAN**

5701 THORNHILL DRIVE OAKLAND, CA

APN: 48G-7420-9-2

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Rev		Ву	
1	05/27/22	AC	PLAN CHECK RESPONSE 1

Drawn By: Reviewed By: Job No:

Issue Date: Sheet Scale :

Drawing Title

**EXITING** 

A0.0

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#### **MONTCLAIR PRESBYTERIAN**

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Issue

Rev		Ву	
	03/26/20	AC	CLIENT REVIEW
	03/31/20	AC	PERMIT SUBMITTA
1	05/27/22	AC	PLAN CHECK RESPONSE 1

Drawn By: 03/31/2020 Issue Date:

Drawing Title

Sheet Scale:

**PROPOSED RAILING PLAN** 

A1.0

PROPOSED RAILING PLAN

APPROVED

By Jason Madani at 3:31 pm, Jul 15, 2022

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CITY OF OAKLAND

**BUILDING SERVICES** 

PLAN CHECK SECTION

Ordinances

SURVEY (REVIEW ONLY)

SOILS REPORT ON FILE

06/08/2022

PARKING/DRIVEWAY LAYOUT

GRADING & EROSION CONTROL

PLOT PLAN REVIEW

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**APPROVED** By Jason Madani at 3:31 pm, Jul 15, 2022

## B2104815

### **APPROVED**

CITY OF OAKLAND **BUILDING SERVICES** PLAN CHECK SECTION

For Substantial Compliance With Codes and Ordinances

### **REVISIONS NEED APPROVAL**


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SURVEY (REVIEW ONLY) PLOT PLAN REVIEW

PARKING/DRIVEWAY LAYOUT GRADING & EROSION CONTROL SOILS REPORT ON FILE


**ELEC/MECH/PLUMB NOT CHECKED** 

06/08/2022

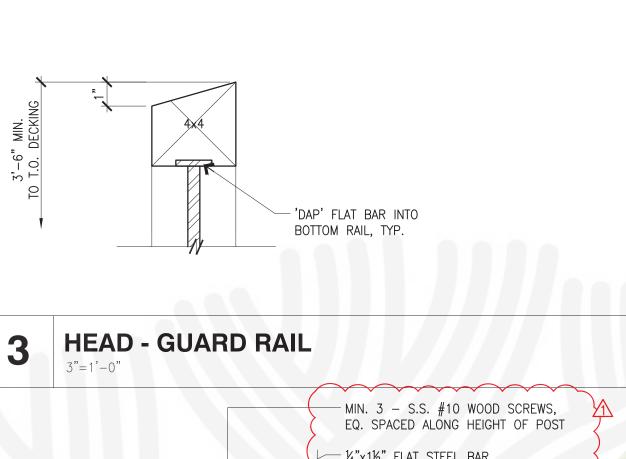


—¼"x1½" FLAT STEEL BAR, SEE DETAIL 2 - METAL HANDRAIL TYP, SEE DETAIL 2


**JAMB - CORNER POST** 

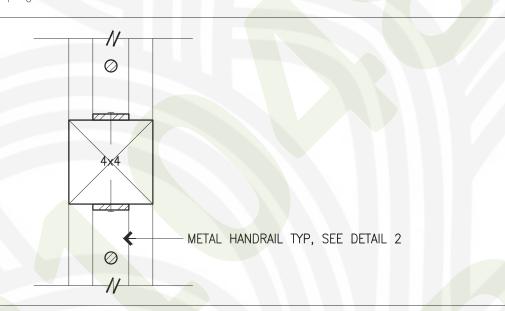

JAMB - TYP. POST 5

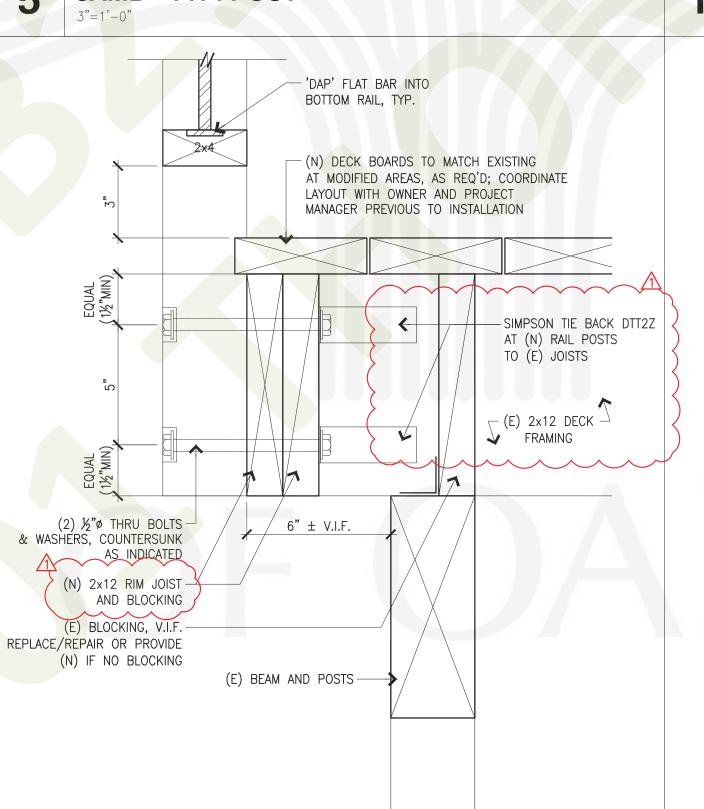

**ELEVATION OF 'C' HANDRAIL SECTION** 

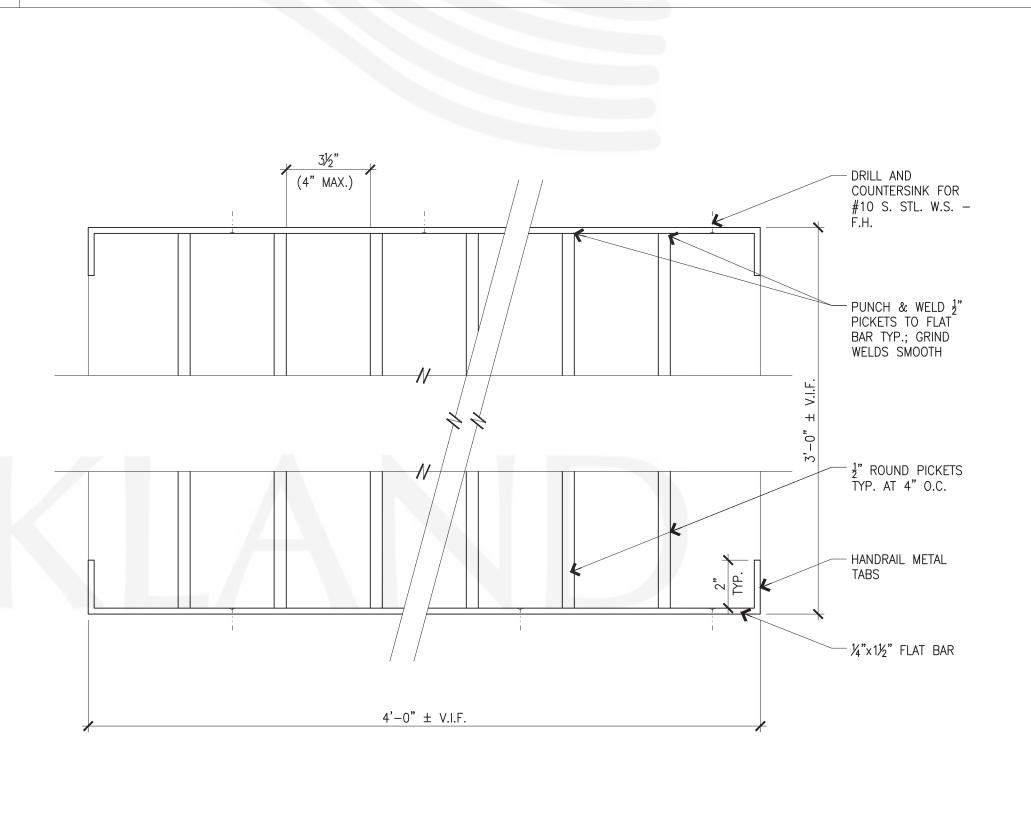

SECTION ELEVATION - 'C'

16'-0" ± V.I.F. / (4) EQUAL SPACES



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APN: 48G-7420-9-2

TURNING POINT — HANDRAIL

SECTION 'B'

	Issue			
	Rev		Ву	
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		03/31/20	AC	PERMIT SUBMITTA
	1	05/27/22	AC	PLAN CHECK RESPONSE 1
		1	_	

Drawn By: Reviewed By: 03/31/2020 Issue Date: Sheet Scale :

Drawing Title

### **PROPOSED RAILING DETAILS**

**A2.0** 

6

**SILL** 3"=1'-0"

TYP ELEVATION OF HANDRAIL PANEL

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