

## Know what's **below**.

## Call before you dig.

THE CONTRACTOR SHALL NOTIFY UNDERGROUND SERVICE ALERT AND THE CITY PUBLIC WORKS AGENCY AT (510)622-5741 AT LEAST 48 HOURS (2 WORKING DAYS) PRIOR TO BEGINNING ANY EXCAVATION IN THE VICINITY OF LINDERGROUND FACILITIES


THE CONTRACTOR SHALL MARK, COVER, PROTECT, AND REMOVE ANY MATERIAL PLACED OVER UTILITIES (ANY CITY OR PRIVATE UTILITY MANHOLE COVER/VALVE LID) PRIOR TO MILL/PAVE OPERATION. THE CONTRACTOR IS RESPONSIBLE FOR WORKING DIRECTLY WITH UTILITY OWNERS IN MAKING ADJUSTMENTS TO UTILITIES; LOWER TO MILL SURFACE (DRIVING SURFACE) IF OPEN TO TRAFFIC, AND RAISE TO FINISH GRADE.

# PLANS FOR THE CONSTRUCTION OF LAKESHORE AVENUE SEPARATED BIKE LANES PROJECT FROM E. 18TH STREET TO MACARTHUR BOULEVARD IN THE CITY OF OAKLAND, IN ALAMEDA COUNTY

TO BE SUPPLEMENTED BY CITY OF OAKLAND STANDARD DETAILS DATED JANUARY 2002, CALTRANS STANDARD PLANS AND SPECIFICATIONS DATED 2023, AND THE LATEST REVISION OF THE CALIFORNIA MUTCD DATED MARCH 2014

## SHEET INDEX


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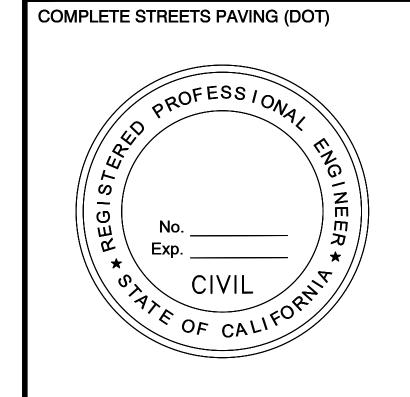
## LOCATION MAP

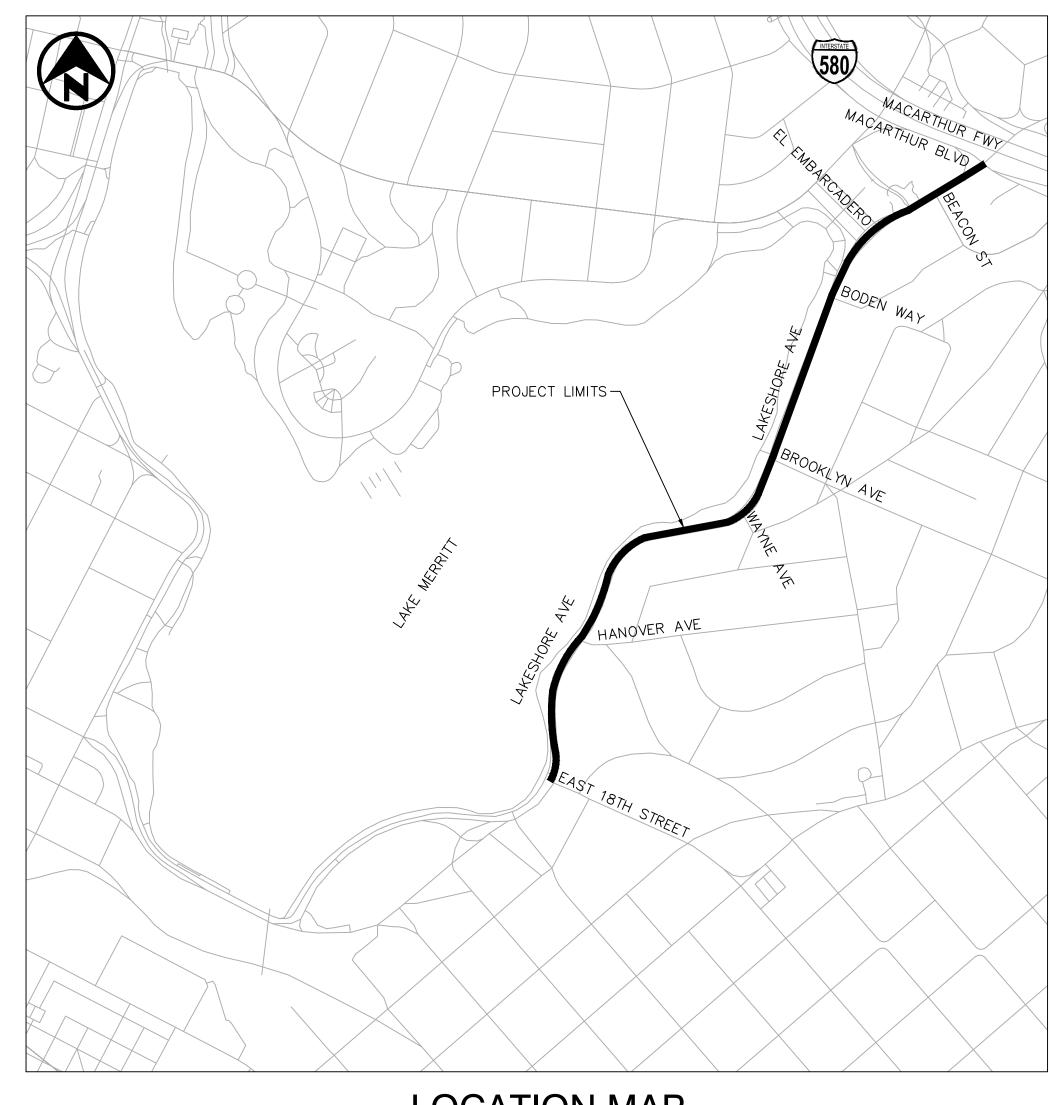NOT TO SCALE

CITY OF OAKLAND
COUNCIL DISTRICT MAP





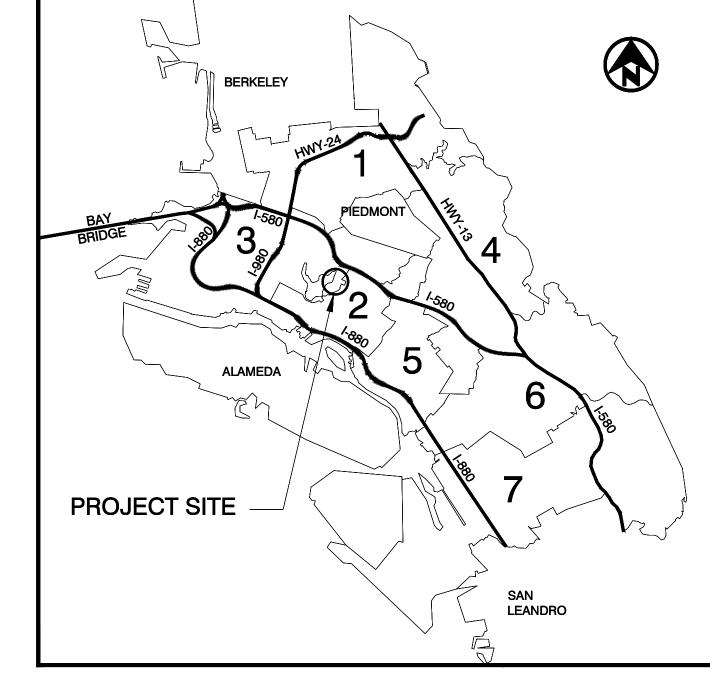

PRINCIPAL CIVIL ENGINEER

CONSTRUCTION MANAGEMENT

PRINCIPAL CIVIL ENGINEER

Kimley» Horn

1300 CLAY STREET, STE 900 OAKLAND, CA 94612 (510) 625-0712

CHECKED BY RYAN DOLE, P.E.							
DESIGNED	DESIGNED BY JORGE MORALES						
DRAWN BY	TESS	A KEMPER/PRIY	A PALLIVATHUCAL				
No.	DATE	BY	REFERENCE				
PROJECT NO.							
1007299							

MEGAN WIER

OAKLAND DEPARTMENT OF TRANSPORTATION
ASSISTANT DIRECTOR

100% SUBMITTAL NOT FOR BID OR CONSTRUCTION ANY INCREASE IN DISTURBED AREA, OR CHANGE TO PAVING LIMITS, IS REQUIRED TO BE REVIEWED BY THE RESIDENT ENGINEER PRIOR TO DEMOLITION AND/OR CONSTRUCTION.

THE CONTRACTOR SHALL PROVIDE WRITTEN NOTICE TO RESIDENTS AND BUSINESSES AT LEAST 72-HOURS IN ADVANCE OF CONSTRUCTION OPERATIONS.

THE CONTRACTOR SHALL COORDINATE WITH BUILDING OWNERS PRIOR TO THE START OF CONSTRUCTION ADJACENT TO AND IN FRONT OF EXISTING DRIVEWAYS.

THE CONTRACTOR SHALL BE RESPONSIBLE FOR COORDINATING ALL WORK TO BE PERFORMED BY SUBCONTRACTORS INCLUDING TRAFFIC CONTROL, CONCRETE CONSTRUCTION, AND OTHER WORK.

THE EXACT LOCATION OF ASPHALT AND CONCRETE CONFORM LINES SHALL BE DETERMINED BY THE ENGINEER IN THE FIELD. SAWCUTTING OF CONCRETE SIDEWALK ALONG CONFORM LINES SHALL BE LOCATED TO THE NEAREST SCORE LINE. UNLESS OTHERWISE NOTED, ELEVATION OF EXISTING SUFFACE AT CONFORM SHOWN IS APPROXIMATE. CONTRACTOR SHALL COORDINATE WITH THE RESIDENT ENGINEER TO FINALIZE GEOMETRY AT CONFORM PRIOR TO CONSTRUCTION IN THE CONFORM AREAS.

EXTENT OF UNDERGROUND BASEMENTS AND VAULTS HAVE BEEN VISUALLY INSPECTED BUT HAVE NOT BEEN VERIFIED THROUGH DESTRUCTIVE TESTING. CONTRACTOR TO EXAMINE EXISTING SITE CONDITIONS PRIOR TO BEGINNING DEMOLITION. ALL UNDERGROUND BASEMENTS SHALL BE PROTECTED DURING CONSTRUCTION.

THE CONTRACTOR SHALL REPLACE THE PRE-EXISTING WIDTH OF CONCRETE GUTTERS WHEN REPLACING GUTTERS OR CONSTRUCTING CURB RAMPS. IF GUTTER WORK IS TO BE CONSTRUCTED AT A CORNER WHERE THERE ARE TWO DIFFERENT GUTTER WIDTHS, THE NEW GUTTER SHALL TRANSITION SMOOTHLY BETWEEN THE TWO DIFFERENT GUTTER WIDTHS.

THE CONTRACTOR SHALL PROTECT ALL TREES. IF TREE ROOT PRUNING IS REQUIRED, THE CONTRACTOR SHALL NOTIFY THE RESIDENT ENGINEER THREE WORKING (3) DAYS IN ADVANCE OF TREE ROOT PRUNING SO THAT AN ARBORIST CAN BE SCHEDULED FOR A TREE STRESS TEST.

AT THE PRE-CONSTRUCTION MEETING, THE CONTRACTOR SHALL SUBMIT FOR REVIEW AND APPROVAL, A LIST OF BEST MANAGEMENT PRACTICES TO PREVENT POTABLE WATER FROM ENTERING THE STORM DRAIN SYSTEM DURING ALL CONSTRUCTION OPERATIONS. ALL PROJECT STORM DRAIN INLETS SHALL BE BLOCKED WITH SILT SACK AND/OR GRAVEL BAGS DURING

10. CONTRACTOR SHALL SUBMIT A TRAFFIC CONTROL PLAN TO THE CITY FOR REVIEW AND APPROVAL, 10 WORKING DAYS PRIOR TO CONSTRUCTION. CONTRACTOR IS RESPONSIBLE FOR TAKING NECESSARY PRECAUTIONS TO ENSURE PEDESTRIAN SAFETY, INCLUDING APPROPRIATE COUNTY AND SAFETY.

IN ACCORDANCE WITH SPECIFICATION SECTIONS 7-9, THE CONTRACTOR SHALL REPAIR OR REPLACE ALL EXISTING IMPROVEMENTS DAMAGED OR REMOVED AS A RESULT OF CONSTRUCTION OPERATIONS. IN ADDITION, ANY EXISTING FACILITIES DAMAGED OR REMOVED AS A RESULT OF CONSTRUCTION OPERATIONS SHALL BE REPAIRED OR REPLACED IN-KIND BY THE CONTRACTOR AT THE CONTRACTOR'S EXPENSE AND NO ADDITIONAL PAYMENT SHALL BE MADE.

12. THE CONTRACTOR'S ATTENTION IS CALLED TO VARIOUS UTILITIES AFFECTED BY THE PROPOSED PAVING AND CONCRETE WORK. CONTRACTOR SHALL BE SOLELY RESPONSIBLE FOR THE COORDINATION AND SCHEDULING OF UTILITY COMPANIES FOR ALL THE UTILITY STRUCTURE ADJUSTMENTS TO THE PROPOSED PAVEMENT ELEVATION. THE LOCATION AND SIZE OF MAJOR UNDERGROUND FACILITIES AND UTILITIES SHOWN HEREON ARE SCHEMATIC IN NATURE, USING INFORMATION FURNISHED BY THE RESPECTIVE OWNER AGENCIES. THE CONTRACTOR IS RESPONSIBLE FOR VERIFYING ALL DATA WITH THE RESPECTIVE AGENCIES AND TAKING PROPER PRECAUTIONS TO PROTECT AND AVOID THE EXISTING FACILITIES AND UTILITIES. DAMAGE TO PRECAUTIONS TO PROTECT AND AVOID THE EXISTING FACILITIES AND UTILITY LINES WILL BE REPAIRED BY THE RESPECTIVE AGENCY AT THE CONTRACTOR'S EXPENSE. CONTRACTOR SHALL ADJUST TO FINISHED GRADE ALL AFFECTED MANHOLES, STREET MONUMENTS, WATER VALVES, GAS VALVES, UTILITY BOXES, CLEANOUT FRAMES, AND COVERS UNLESS OTHERWISE DIRECTED BY THE ENGINEER. THE CONTRACTOR IS RESPONSIBLE FOR RESTORING ALL PULL BOX CONTENTS AFFECTED BY THE WORK TO ITS ORIGINAL STATE.

ALL EXISTING SIGNS ARE TO REMAIN UNLESS SPECIFICALLY DESIGNATED TO BE REMOVED, SALVAGED, OR RELOCATED. REMOVED SIGNS TO BE SALVAGED SHALL BE STORED AT THE CITY OF OAKLAND MAINTENANCE YARD LOCATED AT 7101 EDGEWATER DRIVE. THE CONTRACTOR SHALL RESTORE ALL THE EXISTING SIGNS. THE COST FOR THIS WORK SHALL BE INCLUDED IN THE PRICE FOR THE VARIOUS WORK ITEMS AND NO ADDITIONAL PAYMENT SHALL BE MADE. ALL SALVAGED EQUIPMENT SHALL BE DELIVERED TO THE MUNICIPAL SERVICE CENTER AT 7101 EDGEWATER DRIVE. CONTACT THE ELECTRICAL CONSTRUCTION AND MAINTENANCE PLANNER AT (510) 615-3685, 48 HOURS IN ADVANCE, PRIOR TO DELIVERY.

ALL TRAFFIC STRIPING SHALL BE THERMOPLASTIC, AND ALL PAVEMENT MARKINGS SHALL BE WHITE THERMOPLASTIC, UNLESS NOTED OTHERWISE.

15. EXISTING STRIPING AND PAVEMENT MARKINGS THAT ARE IN CONFLICT WITH PROPOSED STRIPING AND PAVEMENT MARKINGS SHALL BE REMOVED AND DISPOSED OF PER SECTION 15-2.02 (B&C) AND 15-2.03 OF THE STATE STANDARD SPECIFICATIONS.

PEDESTRIAN, PUBLIC ACCESS, AND WHEELCHAIR ACCESS SHALL BE MAINTAINED DURING THE CONSTRUCTION TO THE SATISFACTION OF THE CITY ENGINEER.

NO TRENCHES OR HOLES SHALL BE LEFT OPEN OVERNIGHT; USE STEEL PLATING OR HOT MIX ASPHALT AS REQUIRED TO PROTECT OPEN TRENCHES OVERNIGHT.

18. ALL REVISIONS TO THE PLANS MUST BE REVIEWED AND APPROVED BY THE CITY ENGINEER PRIOR TO CONSTRUCTION AND SHALL BE ACCURATELY SHOWN ON REVISED PLANS STAMPED AND SIGNED BY CITY ENGINEER PRIOR TO THE INSTALLATION OF THE IMPROVEMENTS.

THE CONTRACTOR SHALL PROVIDE TWO (2) SETS OF PROJECT AS-BUILT DRAWINGS TO THE RESIDENT ENGINEER WITH THE FINAL PAYMENT REQUEST.

THIS PROJECT HAS SEVERAL MONUMENTS AS SHOWN IN THE SURVEY CONTROL SHEETS. ALTHOUGH UNEXPECTED AT THIS TIME, ADDITIONAL MONUMENTS MAY BE PRESENT OR UNCOVERED AND SHALL BE CONSIDERED TO BE INCLUDED IN THE PROJECT REQUIREMENTS FOR MONUMENTS. THE CITY SURVEY OFFICE HAS PREPARED A CD OF KNOWN BENCHMARKS AND MONUMENTS IN ADOBE ACROBAT POF FORMAT FOR USE BY THE CONTRACTOR. THE CONTRACTOR. THE CONTRACTOR IS HEREBY ADVISED TO BECOME FAMILIAR WITH SECTION BUSINESS AND PROFESSIONS CODE OF THE STATE OF CALIFORNIA. THIS SECTION DEALS WITH THE REQUIREMENTS IMPOSED IN MONUMENT PRESERVATION AND PROTECTION AND THAT ARE PARTIALLY ASSIGNED TO THE CONTRACTOR BY

THE CONTRACTOR SHALL PROVIDE FOR CONTINUOUS INGRESS AND EGRESS TO ALL PROPERTIES ADJACENT TO THE WORK THROUGHOUT THE PERIOD OF CONSTRUCTION UNLESS OTHERWISE SHOWN.

THE CONTRACTOR SHALL NOTIFY AC TRANSIT, WASTE MANAGEMENT, AND EMERGENCY SERVICES OF THE CONSTRUCTION SCHEDULE TO ALLOW COORDINATION. AC TRANSIT SHALL BE NOTIFIED AT LEAST 2 WEEKS PRIOR TO THE START OF WORK AT LOCATIONS THAT INCLUDE EXISTING OR PROPOSED BUS STOP LOCATIONS.

CONTRACTOR SHALL PREPARE AND SUBMIT A STORMWATER POLLUTION PREVENTION PLAN (SWPPP) PER THE SPECIAL PROVISIONS. SEE WP-01 FOR ADDITIONAL

THE CONTRACTOR'S CALIFORNIA-LICENSED SURVEYOR SHALL REFERENCE THE LOCATION AND FILE A CORNER RECORD WITH THE COUNTY SURVEYOR OF ALAMEDA FOR ALL KNOWN PROJECT MONUMENTS BEFORE DOING ANY CONSTRUCTION WORK THE CONTRACTOR SHALL PROVIDE OFFICIAL COPIES OF THE COUNTY'S CORNER RECORDS
TO THE CITY SURVEYOR BEFORE DOING ANY CONSTRUCTION WORK ON PROJECT STREETS. THE CONTRACTOR SHALL NOTE THAT IT CAN TAKE ALAMEDA COUNTY
RECORDS OFFICE UP TO FOUR WEEKS TO ACCEPT AND FILE CORNER RECORDS. THE COST OF THIS WORK SHALL BE INCLUDED IN THE UNIT PRICE PAID FOR BID ITEM PRE & POST CONSTRUCTION MONUMENT VERIFICATION.

IF IT IS NECESSARY TO REMOVE OR REPLACE A CITY MONUMENT IN CONJUNCTION WITH THE WORK ASSOCIATED WITH THIS CONTRACT, THE CONTRACTOR SHALL PROVIDE TWO WEEKS NOTIFICATION TO THE OFFICE OF THE CITY SURVEYOR AND, UNDER THE DIRECTION AND SUPERVISION OF THE CITY SURVEYOR, THE MONUMENT WILL EITHER BE TEMPORARILY REMOVED AND LATER REPLACED OR IT WILL BE RELOCATED TO ANOTHER LOCATION. THE UNIT PRICE FOR EACH BID ITEM RESET MONUMENT SHALL INCLUDE FULL COMPENSATION FOR ALL LABOR, MATERIALS, SURVEYING, AND FILING COSTS AS REQUIRED BY LAW FOR RESETTING/RELOCATING A MONUMENT. IN THE EVENT THAT RAISING A MONUMENT CREATES A WELL DEPTH GREATER THAN 15" FROM MONUMENT TO SUFFACE, THE MONUMENT SHALL BE RESET AND ALSO PAID FOR BY BID ITEM RESET MONUMENT, IF THE CONTRACTOR SHALL REMOVE, DESTROY, OR DAWAGE ANY CITY MONUMENT WITHOUT PRIOR NOTIFICATION TO THE CITY SURVEYOR, THE CONTRACTOR SHALL BEESPONSIBLE TO RESTORE SAID MONUMENT. IN THE EVENT THAT THE MONUMENT CANNOT BE REPLACED IN ITS ORIGINAL LOCATION, THE CONTRACTOR SHALL REPLACE IT IN AN ALTERNATE LOCATION AS DIRECTED BY THE CITY SURVEYOR OR HIS REPRESENTATIVE. THE CONTRACTOR SHALL ABSORB ALL COSTS TO RESTORE OR REPLACE BUTCH MONUMENTS. SUCH WORK SHALL INCLUDE ALL MATERIALS, LABOR, SURVEYING AND FILING COSTS AS MAY BE REQUIRED BY THE LAW. ALL MONUMENTS SHALL BE RAISED OR LOWERED TO THE FINISH GRADE DURING CONSTRUCTION OPERATIONS. THE CONTRACTOR SHALL SHOW THE LOCATION OF ALL CITY MONUMENTS ON THE SUBMITTED STRIPING PLANS.

THE CONTRACTOR SHALL FURNISH, ERECT, AND MAINTAIN AT ALL TIMES TEMPORARY FENCES, BARRICADES, LIGHTS, SIGNS, AND OTHER DEVICES NECESSARY TO PREVENT ACCIDENTS, DAMAGES, OR INJURIES TO THE PUBLIC.

THE CONTRACTOR SHALL BE RESPONSIBLE FOR MAINTAINING THE EXISTING DRAINAGE PATH WITHIN THE LIMITS OF WORK.

THE CONTRACTOR SHALL NOT ALLOW DEBRIS OR SILT-LADEN WATER GENERATED BY CONSTRUCTION ACTIVITIES OR SAWCUTTING TO FLOW INTO THE PUBLIC STORM DRAIN SYSTEM, NOR BE DEPOSITED INTO THE PUBLIC RIGHT OF WAY, AS SPECIFIED IN SECTION 7-8.6 OF THE SPECIAL PROVISIONS. THE CONTRACTOR SHALL BE RESPONSIBLE FOR REMOVING SILT MATERIAL FROM THE JOB SITE. FULL COMPENSATION FOR PERFORMING THIS WORK SHALL BE INCLUDED IN THE PRICE PAID FOR THE VARIOUS ITEMS OF WORK, AND NO ADDITIONAL PAYMENT WILL BE ALLOWED.

12. SAWCULTING SHALL BE TO A MINIMUM DEPTH OF 2" FOR ASPHALT CONCRETE PAVING AND FULL DEPTH FOR CONCRETE PAVING NO STOMPING WILL BE PERMITTED.

13. REMOVAL AND REPLACEMENT OF CONCRETE CURB AND GUTTER SHALL EXTEND TO THE NEAREST WEAKENED PLANE JOINTS. SIDEWALK REMOVAL AND REPLACEMENT SHALL EXTEND TO THE NEAREST SCORE MARK.

4. THE CONTRACTOR SHALL PROVIDE A PROJECT SCHEDULE FOR THE CITY'S REVIEW AND APPROVAL

MONUMENT REGULATIONS

THE CONTRACTOR'S ATTENTION IS DIRECTED SPECIFICALLY TO SECTION 8771 OF THE STATE'S BUSINESS PROFESSIONS CODE REQUIRING THE PRESERVATION AND PROTECTION OF MONUMENTS. THIS SECTION PROVIDES FOR SPECIFIC REQUIREMENTS BEFORE WORK CAN BE DONE AND THOSE REQUIREMENTS ARE OFTEN TIME CONSUMING. THE CITY OF OAKLAND WILL PROVIDE SUCH MAPPING AND FLING SERVICES AS ARE NECESSARY UPON TWO WORKING DAYS NOTICE FROM THE CONTRACTOR (DIRECTLY TO THE CITY SURVEYOR WITH A COPY TO THE INSPECTOR). IN COMPLIANCE WITH THIS LAW, IT WILL BE THE CONTRACTOR'S RESPONSIBILITY TO IDENTIFY AND PROTECT ALL MONUMENTS WITHIN WORK AREAS SHOWN ON THE INDEX SHEET AND PLANS.

NO MONUMENTS MAY BE DISTURBED, NOR WORK PERFORMED WITHIN A 25 FOOT RADIUS OF SUCH MONUMENT UNTIL THE CITY SURVEYOR HAS MADE THE NECESSARY MEASUREMENTS AND ISSUED A WRITTEN AUTHORIZATION TO THE INSPECTOR.

SHOULD THE CONTRACTOR, PRIOR TO SUCH AUTHORIZATION, DISTURB, REMOVE, OR DESTROY ANY MONUMENT, THE CITY HAS A FLAT CHARGE OF \$5,000 PER UNIT WHICH WILL BE DEDUCTED FROM THE NEXT PROGRESS (OR FINAL) PAYMENT. THE CONTRACTOR SHOULD NOTE THAT, PER 8771 B&P, THE CITY HAS THE RIGHT TO WITHHOLD THE ISSUANCE OF A NOTICE OF COMPLETION UNTIL ALL OUTSTANDING ISSUES RELATING TO THE MONUMENTS ARE RESOLVED.

IF ANY MONUMENT IS LAWFULLY REMOVED OR DESTROYED, THE CONTRACTOR SHALL SALVAGE THE FRAME, CASTING, AND MONUMENT DISH AND DELIVER THEM TO THE CITY SURVEYOR. IF THESE ITEMS ARE NOT SALVAGED/OR DELIVERED, THE CONTRACTOR SHALL REPLACE THE LOST UNITS, IN KIND, DELIVERED TO THE CITY SURVEYOR.

NOT ALL MONUMENTS MAY BE SHOWN ON THE PLAN SHEETS. PRIOR TO THE START OF ANY CONSTRUCTION, THE CONTRACTOR SHALL BE REQUIRED TO IDENTIFY AND MARK ALL MONUMENTS WITH RED PAINT OR, IF FOUND IN UNPAYED AREA, WITH A 3 FOOT LATH FLAGGED AND PAINTED IN RED. PLEASE NOTE THAT STATE LAW MAKES NO DISTINCTION BETWEEN CITY MONUMENTS AND THOSE OF OTHER AGENCIES OR INDIVIDUALS.

IN ADDITION TO MONUMENTS, THE CITY ALSO HAS VERTICAL MONUMENTATION (BENCHMARKS) WHICH ARE LOCATED ON THE PLAN SHEETS. IF A BENCHMARK IS TO BE DESTROYED, THE CITY WILL REQUIRE TWO WORKING DAYS ADVANCE NOTICE TO PRESERVE THE INFORMATION. THE CONTRACTOR, AT NO ADDITIONAL COST TO THE CITY, SHALL REPLACE THE MONUMENT IN A SUITABLE LOCATION TO BE DETERMINED BY THE CITY SURVEYOR. THE CITY WILL PROVIDE THE NECESSARY BRONZE DISK.

THE CITY MAY, AT ITS SOLE DISCRETION, ELECT TO INSTALL A BENCHMARK TO BE SET IN A SIDEWALK OR CURB WHERE THERE WAS NONE BEFORE. THE CITY WILL PROVIDE A BRONZE DISK AND SPECIFY THE LOCATION FOR THE DISK TO BE REPLACED WHEN THE CONCRETE IS PLACED, AND DRESSED TO FINISH ALLONG WITH THE CONCRETE SURFACE. THIS SHALL BE NO ADDITIONAL CHARGE TO THE

SEE CITY OF OAKLAND STANDARD DETAIL S-9 FOR MONUMENT AND BENCHMARK DETAIL.

23. THE CONTRACTOR SHALL PROVIDE OFFICIAL COPIES OF THE COUNTY CORNER RECORDS TO THE CITY SURVEYOR BEFORE DOING ANY CONSTRUCTION WORK ON PROJECT
STREETS. CONTRACTOR SHALL FILE CORNER RECORDS TO THE CITY IN BOTH HARD COPY AS WELL AS SINGLE ADOBE FILE FOR EACH CORNER RECORD.

PLAN PRODUCTION WARNING THE PLANS HAVE BEEN CREATED ON ANSLB (11" X 17") SHEETS BEFER TO GRAPHIC SCALE FOR SHEETS OF DIFFERENT SIZES.

CLEANOUT

CURB RAMP
CABLE TELEVISION LINE

DRAWING ELECTRIC LINE/EAST/EASTINGS

EAST BAY MUNICIPAL UTILITY DISTRICT

DRAINAGE INLET

ELEVATION EDGE OF PAVEMENT

EDGE OF FAVEMENT EDGE OF TRAVEL WAY FACE OF CURB FINISH GRADE

ELECTRICAL

FIRE HYDRANT FLOWLINE FEET

FREEWAY

GAS VALVE

IPPICATION JOINT POLE

LATERAL

LINEAR FEET LIP OF GUTTER

MAINTENANCE HOLE MAXIMUM

NORTH /NOTHINGS

NOT APPLICABLE NORTH BOUND

NOT TO SCALE ON CENTER

RIGHT-OF-WAY

SLOPE/SOUTH SOUTH BOUND

STORM DRAIN SQUARE FEET

STATION

SIDEWALK

SPECIAL PROVISIONS

TELEPHONE LINE TECHNICAL INFFASIBILITY

TOP OF CURB TRAFFIC SIGNAL

TYPICAL UNDERGROUND

WATER VALVE

TELEPHONE POLE TELEVISION.

VARIABLE /VARIES WATER LINE/WEST WATER METER

STORM DRAIN MANHOLE SANITARY SEWER MANHOLE

NUMBER

CITY SURVEY MONUMENT

COMPOUND CURVATURE

PACIFIC GAS & ELECTRIC
POINT OF REVERSE CURVATURE

PORTLAND CEMENT CONCRETE/POINT OF

SANITARY SEWER
STANDARD SPECIFICATIONS FOR PUBLIC

WORKS CONSTRUCTION, 2015 EDITION

FXISTING

CONTINUE

CONT CR CTV DI DWG

ELEC

FL FT FWY

IRR JP LAT

LF LG MH MAX MIN MON (N)

N/A NB NO NTS OC PCC

PG&E PRC R/W

SB SD SF

SS SPECS

SP ST STA

SW SDMH SSMH T/TEL

UG VAR

EX. EBMUD

**Kimley** »Horn

CHECKED BY RYAN DOLE, P.E. JORGE MORALES **DESIGNED BY** 

DRAWN BY TESSA KEMPER/PRIYA PALLIVATHUCAL

No. 075749 06/30/26

PROJECT NO.

100% SUBMITTAL

NOT FOR BID OR

CONSTRUCTION

CITY OF OAKLAND

DEPARTMENT OF TRANSPORTATION 250 FRANK H. OGAWA PLAZA, SLITE 4314 OAKLAND, CA 94612 (510) 238-3437 FAX (510) 238-7227

LAKESHORE AVENUE SEPARATED BIKE LANES PROJECT FROM E 18TH STREET TO MACARTHUR BOULEVARD

No.	DATE	BY	REFERENCE

**GENERAL NOTES** 

1007299

SCALE:

**LEGEND** 

EX MAINTENANCE HOLE STRUCTURE, UTILITY AS NOTED

EXISTING MONUMENT OR BENCHMARK

EX WATER VALVE

ON PLANS, WHEN KNOWN.

EX DRAINAGE INLET STRUCTURE

FX PG&F GAS VALVE

UTILITY POLE

2

SHEET NO. \_ of <u>83</u>

GN - 01

## Pollution Prevention - It's Part of the Plan

## Make sure your crews and subs do the job right!

Runoff from streets and other paved areas is a major source of pollution and damage to creeks and the San Francisco Bay. Construction activities can directly affect the health of creeks and the Bay unless contractors and crews plan ahead to keep dirt, debris, and other construction waste away from storm drains and local creeks. Following these guidelines and the project specifications will ensure your compliance with City of Oakland requirements.

### Materials storage & spill cleanup

#### Non-hazardous materials management

- ✓ Sand, dirt, and similar materials must be stored at least 10 feet (3 meters) from catch basins. All construction material must be covered with a tarp and contained with a perimeter control during wet weather or when rain is forecasted or when not actively being used within 14 days.
- Use (but don't overuse) reclaimed water for dust control as needed.
- Sweep or vacuum streets and other paved areas daily. Do not wash down streets or work areas with water.
- Recycle all asphalt, concrete, and aggregate base material from demolition activities.
- Repair or replace leaking dumpsters promptly.
- Check dumpsters regularly for leaks and to make sure they are not overfilled.
- ✓ Cover all dumpsters with a tarp at the end of every work day or during wet weather.
- Hazardous materials management
- Label all hazardous materials and hazardous wastes (such as pesticides, paints, thinners, solvents, fuel, oil, and antifreeze) in accordance with city, county, state, and federal regulations
- ✓ Store hazardous materials and wastes in water tight containers, store in appropriate secondary containment, and cover them at the end of every work day or during wet weather or when rain is forecasted.
- Follow manufacturer's application instructions for hazardous materials and be careful not to use more than necessary. Do not apply chemicals outdoors when rain is forecasted within 24 hours
- ✓ Be sure to arrange for appropriate disposal of all hazardous wastes.

#### Spill prevention and control

- ▶ Keep a stockpile of spill cleanup materials (rags, absorbents, etc. ) available at the construction site at all times
- When spills or leaks occur, contain them immediately and be particularly careful to prevent leaks and spills from reaching the gutter, street, or storm drain.
- ▶ Never wash spilled material into a gutter, street, storm drain, or creek.
- Dispose of all containment and cleanup materials properly.
- Report any hazardous materials spills immediately! Dial 911 or City of Oakland, Public Works Agency hotline at (510) 615-5566.

#### Construction Entrances and Perimeter

- ✓ Establish and maintain effective perimeter controls and stabilize all construction entrances and exits to sufficiently control erosion and sediment discharges from site and tracking off site.
- ✓ Sweep or vacuum any street tracking immediately and secure sediment source to prevent further tracking.

#### Vehicle and equipment maintenance & cleaning

- ✓ Inspect vehicles and equipment for leaks frequently. Use drip pans to catch leaks until repairs are made; repair leaks
- Fuel and maintain vehicles on site only in a bermed area or over a drip pan that is big enough to prevent runoff.
- ✓ If you must clean vehicles or equipment. on site, clean with water only in a bermed area that will not allow rinse water to run into gutters, streets, storm drains, or creeks.
- ✓ Do not clean vehicles or equipment on-site using soaps, solvents, degreasers, steam cleaning equipment, etc.



#### Earthwork & contaminated soils

- ✓ Keep excavated soil on the site where it will not collect in the street.
- ✓ Transfer to dump trucks should take place on the site, not in the street.
- ✓ Use fiber rolls, silt fences, or other control measures to minimize the flow of silt




- ✓ Earth moving activities shall be approved by the City Resident Engineer in
- Mature vegetation is the best form of erosion control. Minimize disturbance to existing vegetation whenever possible.
- ✓ If you disturb a slope during construction, prevent erosion by securing the soil with erosion control fabric, or seed with fastgrowing grasses as soon as possible. Place fiber rolls down-slope until soil is secure.

Storm drain polluters may be liable for fines of \$10,000 or more per day!

✓ If you suspect contamination (from site history, discoloration, odor, texture, abandoned underground tanks or pipes, or buried debris), call the Engineer for help in determining what should be done, and manage disposal of contaminated soil according to their instructions.

#### Dewatering operations

- ✓ Effectively manage all run-on, all runoff within the site, and all runoff that discharges from the site. Run-on from off site shall be directed away from all disturbed areas or shall collectively be in compliance.
- Reuse water for dust control, irrigation, or another on-site purpose to the greatest extent possible.

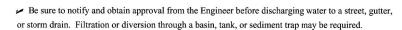

✓ In areas of known contamination, testing is required prior to reuse or discharge of groundwater. Consult with the Engineer to determine what testing is required and how to interpret results. Contaminated groundwater must be treated or hauled off-site for proper disposal.

#### Saw cutting

✓ Always completely cover or barricade storm drain inlets when saw cutting. Use filter fabric, catch basin inlet filters, or sand/gravel bags to keep slurry out of the storm drain system.

▶ Shovel, absorb, or vacuum saw-cut slurry and pick up all waste as soon as you are finished in one location or at the end of each work day (whichever is

✓ If saw cut slurry enters a catch basin, clean it up immediately.

### Paving/asphalt work



- ✓ Always cover storm drain inlets and manholes when paving or applying seal coat, tack coat, slurry seal, or fog seal
- with sand/gravel bags, or earthen beers.
- ✓ Do not sweep or wash down excess sand from sand sealing into gutters, storm drains, or creeks. Collect sand and return it to the stockpile, or dispose of it as trash.
- Do not use water to wash down fresh asphalt

PLAN PRODUCTION WARNING THE PLANS HAVE BEEN CREATED ON

REFERENCE

ANSI B (11" X 17") SHEETS REFER TO

GRAPHIC SCALE FOR SHEETS OF

DIFFERENT SIZES.

### Concrete, grout, and mortar storage & waste disposal

- ✓ Store concrete, grout, and mortar under cover, on pallets, and away from drainage areas. These materials must never reach a
- ► Wash out concrete equipment/trucks off-site or into contained washout areas that will not allow discharge of wash water onto the underlying soil or onto the surrounding areas.



Collect the wash water from washing exposed aggregate concrete and remove it for appropriate disposal off site.

#### Painting

- ✓ Never rinse paint brushes or materials in a gutter or street!
- ✓ Paint out excess water-based paint before rinsing brushes. rollers, or containers in a sink.



- Paint out excess oil-based paint before cleaning brushes in thinner.
- Filter paint thinners and solvents for reuse whenever possible.
- ✓ Dispose of oil-based paint sludge and unusable thinner as hazardous waste.

### Landscape Materials

- Contain, cover, and store on pallets all stockpiled landscape materials (mulch, compost, fertilizers, etc.) during wet weather or when rain is forecasted or when not actively being used within 14 days.
- ▶ Discontinue the application of any erodible landscape material within 2 days of forecasted rain and during wet weather.

## Kimley»Horn 1300 Clay Street, Suite 900 Tel. No. (510)625-0712 @202 Oakland, California 94612 Fax No. (916)608-0885

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DRAWN BY	TESSA KEMPER/PRIYA PALLIVATHUCAL



PROJECT NO.

1007299

SCALE:

3

100% SUBMITTAL

NOT FOR BID OR

CONSTRUCTION

## CITY OF OAKLAND

DEPARTMENT OF TRANSPORTATION 250 FRANK H. OGAWA PLAZA, SLITE 4314

LAKESHORE AVENUE SEPARATED BIKE LANES PROJECT FROM E 18TH STREET TO MACARTHUR BOULEVARD

WATER POLLUTION **PREVENTION** 

SHEET NO.  $WP - \Omega1$ 

#### SURVEYOR'S STATEMENT:

THIS MAP CORRECTLY REPRESENTS A SURVEY MADE BY ME OR UNDER MY DIRECTION IN CONFORMANCE WITH THE REQUIREMENTS OF THE PROFESSIONAL LAND SURVEYORS' ACT.

I HEREBY FURTHER STATE THAT TO THE BEST OF MY KNOWLEDGE ALL PROVISIONS OF APPLICABLE STATE LAWS AND LOCAL ORDINANCES HAVE BEEN COMPLIED WITH.

I HEREBY ACKNOWLEDGE THAT THIS SURVEY SHALL BE A PUBLIC RECORD AND MAY BE AVAILABLE FOR INSPECTION AND DISTRIBUTION TO THE GENERAL PUBLIC.

ALL HORIZONTAL COORDINATES AND LOCATIONS SHOWN ARE BASED ON THE NAD83 (CA ZONE 3) COORDINATE SYSTEM AND WERE DERIVED FROM GPS CONTROL OBSERVATIONS.

ALL GRADES AND ELEVATIONS SHOWN ARE BASED UPON THE OAKLAND CITY DATUM. BENCHMARK "61/I/9" LOCATED AT THE INTERSECTION OF LAKESHORE AND BODEN WAY, ELEVATION 4.744' WAS HELD.

DATED: 08/02/2024

Joseph Brajkovich

JOSEPH M BRAJKOVICH, PLS 5254

#### PUBLIC ADVISORY:

THIS MAP IS BASED ON PRIVATE SURVEYS PERFORMED BY LICENSED PROFESSIONALS AND WILL NOT BE UPDATED OR CORRECTED BY THE CITY OF OAKLAND AFTER ITS FILING. NO WARRANTY, EITHER EXPRESSED OR IMPLIED, IS MADE BY THE CITY OF OAKLAND THAT THIS MAP AND THE SURVEY INFORMATION ON WHICH IT IS BASED IS CORRECT, ACCURATE, OR CURRENT, NOR THAT THE CITY WILL RETAIN FOR PUBLIC INSPECTION ANY RELATED INFORMATION WHICH MAY BE SUBSEQUENTLY SUBMITTED TO THE CITY, INCLUDING ALLEGED OR ACTUAL DISCREPANCIES, INACCURACIES, DEFICIENCIES, AND ERRORS.

Control Point Table						Control Point Tal	ble		
Point #	Point # Northing Easting Elevation Raw Description		Point #	Northing	Easting	Elevation	Raw Description		
1	2118996.2296	6054856.5885	3.82	CUT-X	22	2119616.4097	6055095.0472	4.07	MON-PIN
3	2118808.3011	6054791.8281	3.53	CUT-X	23	2119917.4649	6055136.4951	5.18	CUT-X
4	2118809.7282	6054871.2324	5.29	CUT-X	24	2119955.0473	6055173.4909	5.03	CUT-X
5	2118733.3436	6054861.4628	5.40	CUT-X	25	2120015.4241	6055295.2546	6.33	CUT-X
6	2119077.0940	6054784.3544	5.52	CUT-X	26	2119942.3894	6055332.9620	4.22	MON-PIN
7	2119148.8486	6054779.0629	5.67	CUT-X	27	2120046.9729	6055464.7782	5.33	CUT-X
8	2119077.1979	6054857.0538	4.78	CUT-X	28	2120072.4246	6055606.4629	4.17	CUT-X
9	2119292.6155	6054812.4467	5.55	CUT-X	29	2119996.0488	6055634.9838	5.17	CUT-X
10	2119412.1150	6054879.9875	4.93	CUT-X	30	2119962.5742	6055436.6223	5.15	CUT-X
11	2119487.1704	6054931.9146	3.43	CUT-X	31	2120155.7641	6055786.8128	3.77	CUT-X
12	2119452.4385	6055031.0632	5.25	CUT-X	32	2120072.7165	6055755.5667	6.22	CUT-X
13	2119359.1295	6054943.2891	5.76	CUT-X	33	2120046.4552	6055796.2065	5.67	CUT-X
14	2119351.4250	6054936.2182	5.82	FND-NAIL-TAG-LS4520	34	2120085.2368	6055825.1900	5.18	MON-PIN
15	2119343.2853	6054930.7274	5.01	MON-PIN-1-8-IN	35	2120317.1118	6055885.4093	4.14	CUT-X
16	2119271.6106	6054892.5096	6.21	CUT-X	36	2120413.7008	6055909.7798	4.00	CUT-X
17	2119479.5171	6055024.5005	3.55	MON-PIN	37	2120459.5146	6055937.8882	4.18	CUT-X
18	2119575.5647	6054987.9502	4.15	CUT-X	38	2120528.7188	6055962.8598	4.32	CUT-X
19	2119698.1007	6055038.6217	4.73	CUT-X	39	2120589.7813	6055985.5439	4.25	CUT-X
20	2119776.5902	6055076.9764	5.63	CUT-X	40	2120412.4308	6056007.3140	5.13	CUT-X
21	2119666.8487	6055109.4568	4.62	CUT-X	41	2120299.5150	6055964.1210	5.00	CUT-X

Joseph Brajkovich

PLAN PRODUCTION WARNING THE PLANS HAVE BEEN CREATED ON ANSI B (11" X 17") SHEETS. REFER TO GRAPHIC SCALE FOR SHEETS OF DIFFERENT SIZES.

PLS Surveys, LAND SURVEYORS (510)261-0900	$\mathrm{Inc.}^{\mathrm{U}}$

CHECKED BY JOE BRAJKOVICH, PLS DESIGNED BY JAMES HOUSTON, PLS DRAWN BY JAMES HOUSTON, PLS







CITY OF OAKLAND

DEPARTMENT OF TRANSPORTATION 250 FRANK H. OGAWA PLAZA, SUITE 4314 OAKLAND, CA 94612 (510) 238-3437 FAX (510) 238-7227

LAKESHORE AVENUE SEPARATED BIKE LANES PROJECT FROM E 18TH STREET TO EL EMBARCADERO

No.	DATE	BY	REFERENCE

SURVEY CONTROL

PROJECT NO. 1007299

SCALE:

SHEET NO SC-01 4 of 79

Control Point Table						
Point #	nt # Northing Easting		Elevation	Raw Description		
42	2120256.4300	6055948.5706	4.25	MON 1/8 PIN W/WASHER-CITY ENG		
43	2120228.4359	6055932.2201	4.87	CUT-X		
44	2120681.3560	6056019.3819	4.45	CUT-X		
45	2120779.2164	6056055.3477	4.29	CUT-X		
46	2120835.3248	6056076.2245	4.13	CUT-X		
47	2120893.8633	6056097.7720	4.16	CUT-X		
48	2120787.4734	6056144.4449	5.49	CUT-X		
49	2120704.9497	6056115.1743	5.46	CUT-X		
50	2120548.0195	6056050.1321	5.01	CUT-X		
51	2120971.3296	6056126.5031	4.08	CUT-X		
52	2121043.6620	6056153.2081	4.41	CUT-X		
53	2121112.1034	6056178.5264	4.65	CUT-X		
54	2121180.4291	6056203.8939	4.76	CUT-X		
55	2121235.5044	6056223.9706	4.62	CUT-X		
56	2121308.6171	6056251.0142	4.64	CUT-X		
57	2121396.6959	6056367.4925	4.12	MON-PIN		
58	2121368.7157	6056275.8813	4.86	CUT-X		
59	2121423.8433	6056299.5142	4.99	CUT-X		
60	2121478.1025	6056322.1506	5.03	CUT-X		
61	2121531.1416	6056350.4649	5.10	CUT-X		

	Control Point Table						
Point #	Northing	Easting	Elevation	Raw Description			
62	2121257.1681	6056316.9369	5.54	CUT-X			
63	2121155.4625	6056278.0187	5.59	CUT-X			
64	2121239.6701	6056309.4612	4.74	MON-1-8-PIN			
65	2121584.6926	6056397.0947	5.49	CUT-X			
66	2121627.4317	6056429.9504	5.35	CUT-X			
67	2121598.7348	6056477.2338	5.19	CUT-X			
68	2121681.4963	6056476.8714	5.20	CUT-X			
69	2121680.5188	6056534.6623	5.01	CUT-X			
70	2121545.4234	6056510.2578	5.66	CUT-X			
71	2121583.0139	6056548.3920	4.37	MON-PIN			
72	2121787.9356	6056740.1798	5.17	CUT-X			
73	2121820.3586	6056797.4944	4.87	CUT-X			
74	2121854.6347	6056857.1446	4.89	CUT-X			
75	2118915.8096	6054876.1206	3.30	MON-1-8-PIN			
76	2118700.6177	6054935.0643	5.83	CUT-X			
77	2118686.4299	6054991.5212	5.50	CUT-X			
78	2121993.9604	6056879.3880	6.90	CUT-X			
79	2121981.2247	6056908.6426	6.71	CUT-X			
80	2121940.2449	6056936.1429	6.25	CUT-X			
81	2121958.9019	6056974.1713	6.96	CUT-X			

Control Point Table						
Point #	Northing	Easting	Elevation	Raw Description		
82	2121904.5062	6056923.9590	5.76	CUT-X		
83	2121732.7172	6056847.6908	5.68	CUT-X		
84	2121713.1833	6056771.4474	5.24	CUT-X		
671	2119243.5791	6054881.5084	6.18	FND-TAG-4520		
1677	2119797.3581	6055160.5326	4.15	MON-PIN		
2518	2119996.1415	6055637.0108	4.32	MON-PIN		

Joseph Brajkovich

PLAN PRODUCTION WARNING
THE PLANS HAVE BEEN CREATED ON
ANSI B (11" X 17") SHEETS. REFER TO
GRAPHIC SCALE FOR SHEETS OF
DIFFERENT SIZES.

PLS Surveys, Inc.

LAND SURVEYORS
(510)261-0900

CHECKED BY


DESIGNED BY

DESIGNED BY

JAMES HOUSTON, PLS

DRAWN BY

JAMES HOUSTON, PLS

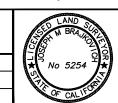



CITY OF OAKLAND

DEPARTMENT OF TRANSPORTATION

250 FRANK H. OGAWA PLAZA, SUITE 4314
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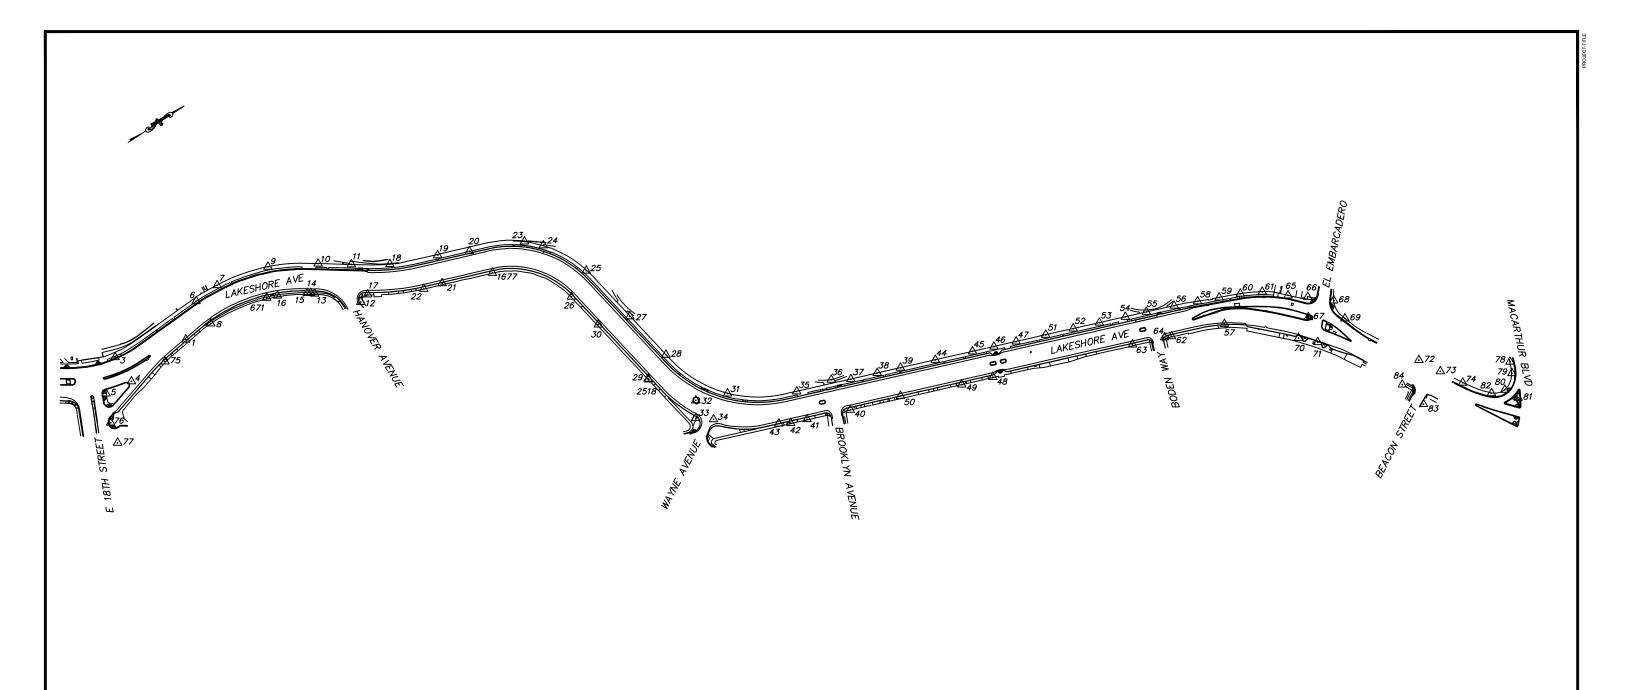
LAKESHORE AVENUE SEPARATED BIKE LANES PROJECT FROM E 18TH STREET TO EL EMBARCADERO

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SURVEY CONTROL

PROJECT NO. 1007299

SCALE: NO SCALE SHEET NO. SC-02 5 of 79 DRAWING NAME: PLOT DATE: 08-0




Joseph Brajkovich

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CHECKED BY JOE BRAJKOVICH, PLS
DESIGNED BY JAMES HOUSTON, PLS
DRAWN BY JAMES HOUSTON, PLS





CITY OF OAKLAND

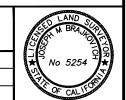DEPARTMENT OF TRANSPORTATION 250 FRANK H. OGAWA PLAZA, SUITE 4314 OAKLAND, CA 94612 (510) 238-3437 FAX (510) 238-7227 LAKESHORE AVENUE SEPARATED BIKE LANES PROJECT FROM E 18TH STREET TO EL EMBARCADERO


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SURVEY CONTROL

1007299

SCALE: NO SCALE

SHEET NO. SC-03 6 of 79 PRAWING NAME: C:\Us LOT DATE: 08-04-24

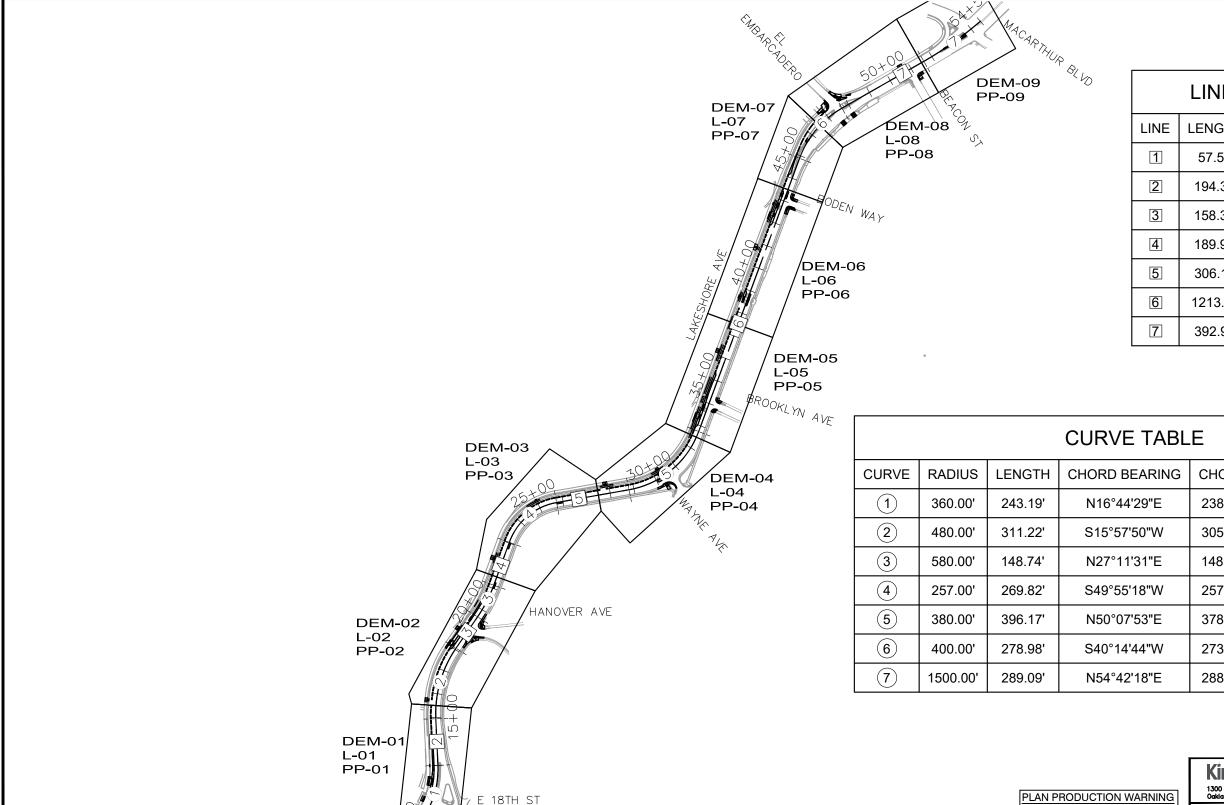

LINE TABLE LENGTH **BEARING** 57.52 N36°05'36.70"E 194.33 N2°36'38.78"W 158.35 N34°32'19.62"E 189.99 N19°50'43.09"E 306.17 N79°59'53.66"E 1213.81 N20°15'53.17"E N60°13'34.89"E 392.96

CHORD **DELTA TANGENT** 238.59' 38°42'15" 126.44' 37°08'58" 305.80' 161.30' 14°41'37" 148.33' 74.78' 257.59' 60°09'11" 148.84' 378.47' 59°44'00" 218.22' 273.36' 39°57'42" 145.44' 288.65' 11°02'33" 145.00'



PLAN PRODUCTION WARNING THE PLANS HAVE BEEN CREATED ON ANSI B (11" X 17") SHEETS. REFER TO GRAPHIC SCALE FOR SHEETS OF DIFFERENT SIZES.

## **Kimley** »Horn

CHECKED B1	HTAN DOLE, P.E.
DESIGNED BY	JORGE MORALES
DRAWN BY	TESSA KEMPER/PRIYA PALLIVATHUCAL



PROJECT NO.

95% SUBMITTAL

NOT FOR BID OR

CONSTRUCTION

CITY OF OAKLAND

DEPARTMENT OF TRANSPORTATION 250 FRANK H. OGAWA PLAZA. SUITE 4314 OAKLAND, CA 94612 (510) 238-3437 FAX (510) 238-7227

LAKESHORE AVENUE SEPARATED BIKE LANES PROJECT FROM E 18TH STREET TO MACARTHUR BOULEVARD

No.	DATE	BY	REFERENCE

**KEY MAP** 

1007299

SCALE: SHEET NO.

K - 017 of 83

#### NOTES:

- 1. EXISTING PAVEMENT SECTION VARIES ALONG LAKESHORE AVENUE PER THE GEOTECHNICAL REPORT PREPARED BY ALL EARTH GEOTECHNICAL ENGINEERING INC., DATED MAY 20, 2024. SEE PAVING PLANS FOR APPROXIMATE CORING AND BORING LOCATIONS AND A SUMMARY OF EXISTING PAVEMENT SECTIONS.
- 2. SEE PAVING PLANS FOR EXACT LIMITS OF PAVING.
- 3. FOR SAWCUT LIMITS, SEE DEMOLITION PLANS.
- 4. CONTRACTOR SHALL SAWCUT TO A NEAT LINE.
- 5. FOR LIMITS AND TYPE OF CURB, SEE LAYOUT PLANS.
- 6. FOR GRADING DETAILS AND LAYOUT INFORMATION NOT SHOWN, SEE LAYOUT PLANS AND CONSTRUCTION DETAIL SHEETS.
- 7. FOR DRAINAGE IMPROVEMENTS, SEE DRAINAGE AND UTILITY PLANS.
- 8. FOR COLD PLANE AND OVERLAY CONFORM LIMITS, SEE PAVING PLANS.
- SLURRY SEAL SHALL BE PLACED OVER NEW ASPHALT PAVEMENT. SLURRY SEAL LIMITS SHALL EXTEND TO THE CURB RETURN OF INTERSECTING STREETS.
- 10. CRACKS IN THE UNDERLYING BASECOURSE SHOULD BE SEALED PRIOR TO THE APPLICATION OF SLURRY/SEAL COATS.
- 11. FOR DIGOUT LOCATIONS, SEE PAVING PLANS.
- 12. DIGOUTS SHOULD BE REPAIRED USING PAVEMENT STRUCTURAL SECTION 1. THE EXISTING ASPHALT, AGGREGATE BASE, AND ANY PORTION OF THE SUBGRADE NEEDED TO MAKE THE SECTION THICKNESS SHOULD BE REMOVED. THE UNDERLYING SUBGRADE SHOULD BE COMPACTED ACCORDING TO SECTION 7.2 OF THE GEOTECHNICAL REPORT, DATED NOVEMBER 15, 2024.
- 13. AGGREGATE BASE SHOULD BE USED TO MAKE GRADES UNDER THE FULL HMA SECTION AND SHOULD BE COMPACTED ACCORDING TO SECTION 7.2 OF THE GEOTECHNICAL REPORT DATED NOVEMBER 15, 2024.

#### **PAVEMENT STRUCTURAL SECTIONS:**

1 — 12" DEEP LIFT HMA (TYPE A)


2 COLD PLANE AC PAVEMENT (3" MAX) 3" HMA (TYPE A) INLAY

THMA (TYPE A) OVERLAY (6" MAX)

4 — 3.5" MIN PCC 4" MIN AGGREGATE BASE (TYPE A)


5 6" MIN PCC

6 - 3" WOOD MULCH 15" IMPORTED SOIL

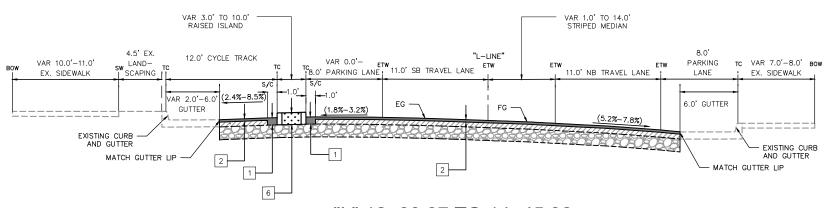

"L" 12+80.87 TO 14+45.32
"L" 18+95.73 TO 20+70.63
"L" 33+88.95 TO 35+39.17
LAKESHORE AVENUE

NOT TO SCALE

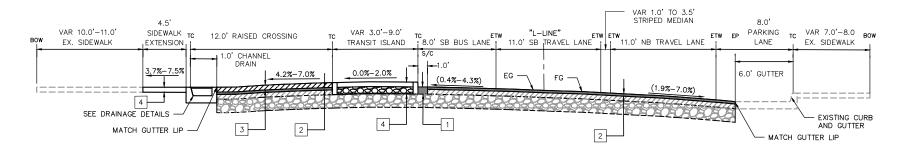

"L" 12+02.78 TO 12+22.80
"L" 18+07.63 TO 18+19.63
"L" 33+31.04 TO 33+43.04
"L" 41+24.53 TO 42+36.53

LAKESHORE AVENUE

NOT TO SCALE

PLAN PRODUCTION WARNING
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DIFFERENT SIZES.

Kimley» Horn

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Tel. No. (510)625-0712
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CHECKED BY RYAN DOLE, P.E.

DESIGNED BY JORGE MORALES

DRAWN BY TESSA KEMPER/PRIYA PALLIVATHUCAI



100% SUBMITTAL NOT FOR BID OR CONSTRUCTION



CITY OF OAKLAND

DEPARTMENT OF TRANSPORTATION
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LAKESHORE AVENUE SEPARATED BIKE LANES PROJECT FROM E 18TH STREET TO MACARTHUR BOULEVARD

	REFERENCE	BY	DATE	No.
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TYPICAL SECTIONS

PROJECT	NO.
10072	299


SCALE: SHEET NO. X-01

DATE: 12/11/2024 8 OF 83

WING NAME: K:\OAK\_RDWY\ T DATE: 12-12-24 TTED BY: Priya.Pallivathucal

#### NOTES:

- 1. EXISTING PAVEMENT SECTION VARIES ALONG LAKESHORE AVENUE PER THE GEOTECHNICAL REPORT PREPARED BY ALL EARTH GEOTECHNICAL ENGINEERING INC., DATED MAY 20, 2024. SEE PAVING PLANS FOR APPROXIMATE CORING AND BORING LOCATIONS AND A SUMMARY OF EXISTING PAVEMENT SECTIONS.
- 2. SEE PAVING PLANS FOR EXACT LIMITS OF PAVING.
- 3. FOR SAWCUT LIMITS, SEE DEMOLITION PLANS.
- 4. CONTRACTOR SHALL SAWCUT TO A NEAT LINE.
- 5. FOR LIMITS AND TYPE OF CURB, SEE LAYOUT PLANS.
- 6. FOR GRADING DETAILS AND LAYOUT INFORMATION NOT SHOWN, SEE LAYOUT PLANS AND CONSTRUCTION DETAIL SHEETS.
- 7. FOR DRAINAGE IMPROVEMENTS, SEE DRAINAGE AND UTILITY PLANS.
- 8. FOR COLD PLANE AND OVERLAY CONFORM LIMITS, SEE PAVING PLANS.
- SLURRY SEAL SHALL BE PLACED OVER NEW ASPHALT PAVEMENT. SLURRY SEAL LIMITS SHALL EXTEND TO THE CURB RETURN OF INTERSECTING STREETS.
- CRACKS IN THE UNDERLYING BASECOURSE SHOULD BE SEALED PRIOR TO THE APPLICATION OF SLURRY/SEAL COATS.
- 11. FOR DIGOUT LOCATIONS, SEE PAVING PLANS.
- 12. DIGOUTS SHOULD BE REPAIRED USING PAVEMENT STRUCTURAL SECTION 1. THE EXISTING ASPHALT, AGGREGATE BASE, AND ANY PORTION OF THE SUBGRADE NEEDED TO MAKE THE SECTION THICKNESS SHOULD BE REMOVED. THE UNDERLYING SUBGRADE SHOULD BE COMPACTED ACCORDING TO SECTION 7.2 OF THE GEOTECHNICAL REPORT, DATED NOVEMBER 15, 2024.
- 13. AGGREGATE BASE SHOULD BE USED TO MAKE GRADES UNDER THE FULL HMA SECTION AND SHOULD BE COMPACTED ACCORDING TO SECTION 7.2 OF THE GEOTECHNICAL REPORT DATED NOVEMBER 15, 2024.

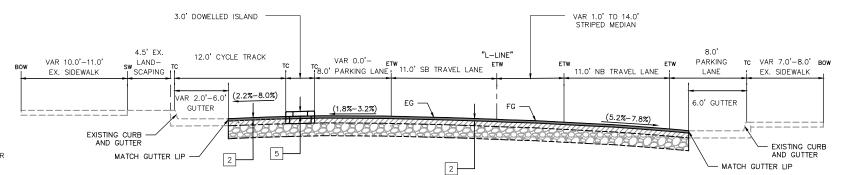

"L" 14+51.82 TO 17+73.02
"L" 20+77.37 TO 29+95.17
"L" 30+78.24 TO 32+73.06
"L" 35+45.67 TO 38+16.42
"L" 39+11.44 TO 41+66.94
"L" 43+56.64 TO 43+92.30

LAKESHORE AVENUE

NOT TO SCALE

#### PAVEMENT STRUCTURAL SECTIONS:

1 — 21" DEEP LIFT HMA (TYPE A)


2 - COLD PLANE AC PAVEMENT (3" MAX)
3" HMA (TYPE A) INLAY

3 HMA (TYPE A) OVERLAY (6" MAX)

4 - 3.5" MIN PCC 4" MIN PROCESSED AGGREGATE BASE (TYPE A)

5 6" MIN PCC

6 - 3" WOOD MULCH 15" IMPORTED SOIL

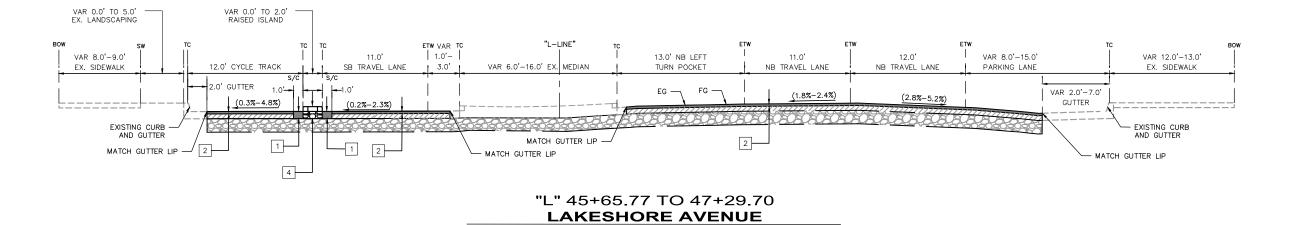

**NOT TO SCALE** 

100% SUBMITTAL NOT FOR BID OR CONSTRUCTION PLAN PRODUCTION WARNING
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DIFFERENT SIZES.

Kimley » Horn

1300 Clay Street, Suite 900 Tel. No. (510)625-0712 © 2024

Oakland, California 94612 Fax No. (916)608-0885

CHECKED BY RYAN DOLE, P.E.

DESIGNED BY JORGE MORALES



TESSA KEMPER/PRIYA PALLIVATHUCAL PROJECT NO.

CITY OF OAKLAND

DEPARTMENT OF TRANSPORTATION
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LAKESHORE AVENUE SEPARATED BIKE LANES PROJECT FROM E 18TH STREET TO MACARTHUR BOULEVARD

	REFERENCE	BY	DATE	No.
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TYPICAL SECTIONS


DRAWN BY

1007299

SCALE: SHEET NO. X-02

DATE: 12/11/2024 9 OF 83

DRAWING NAME: K:\OAK\_RDW PLOT DATE: 12-12-24 PLOTTED BY: Priva.Pallivathu

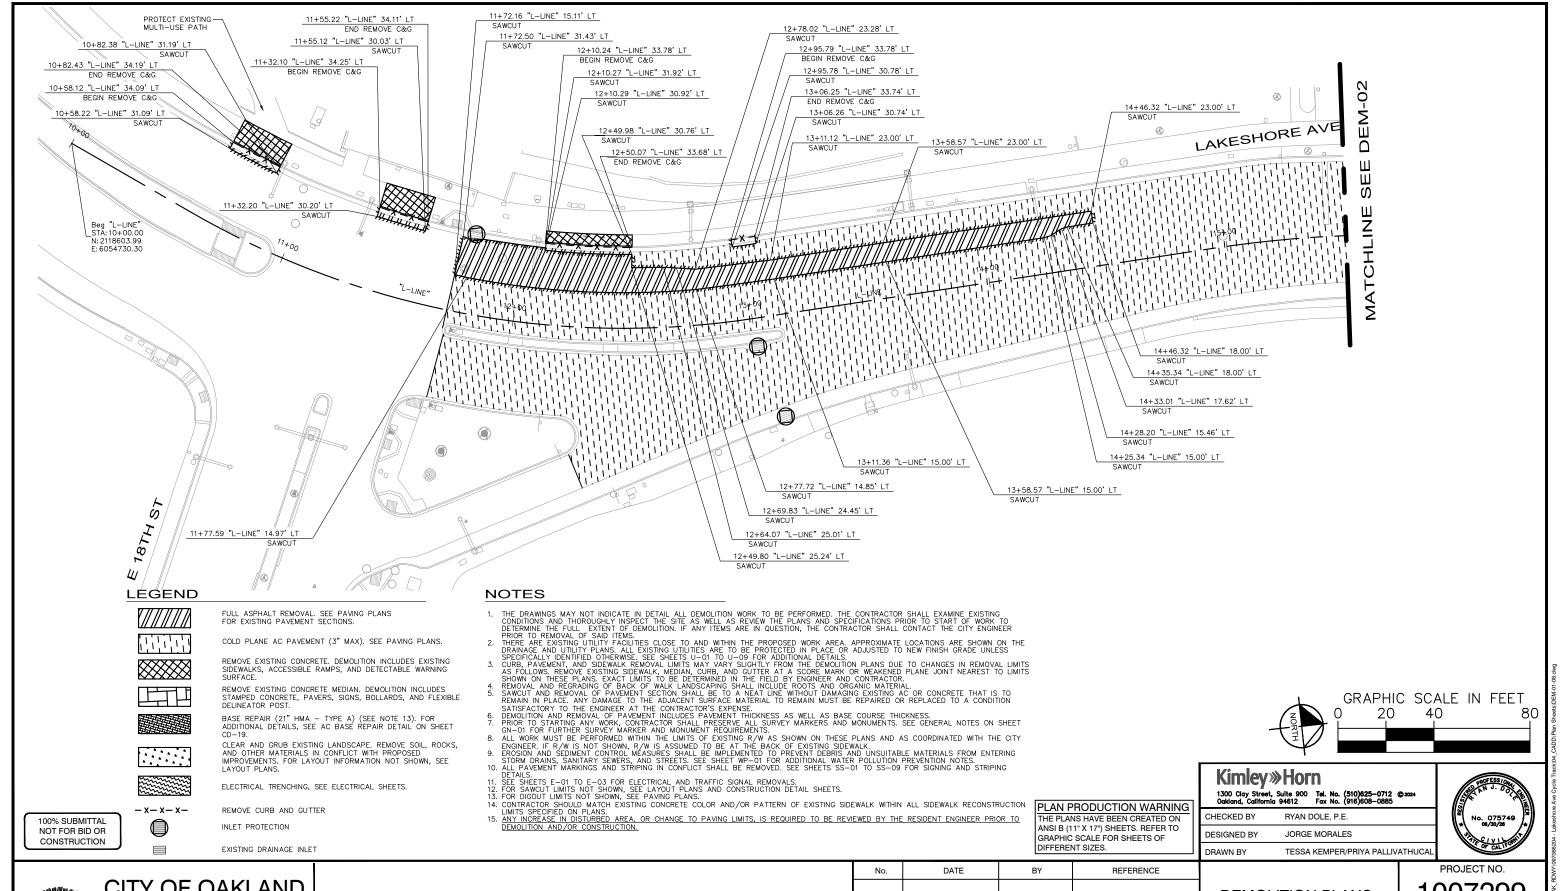

CITY OF OAKLAND DEPARTMENT OF TRANSPORTATION

LAKESHORE AVENUE SEPARATED BIKE LANES PROJECT FROM E 18TH STREET TO MACARTHUR BOULEVARD 250 FRANK H. OGAWA PLAZA, SLITE 4314 OAKLAND, CA 94612 (510) 238-3437 FAX (510) 238-7227


No.	DATE	BY	REFERENCE

**DEMOLITION PLANS** 

1007299

SCALE: AS SHOWN

SHEET NO. DEM-01 10 of 83

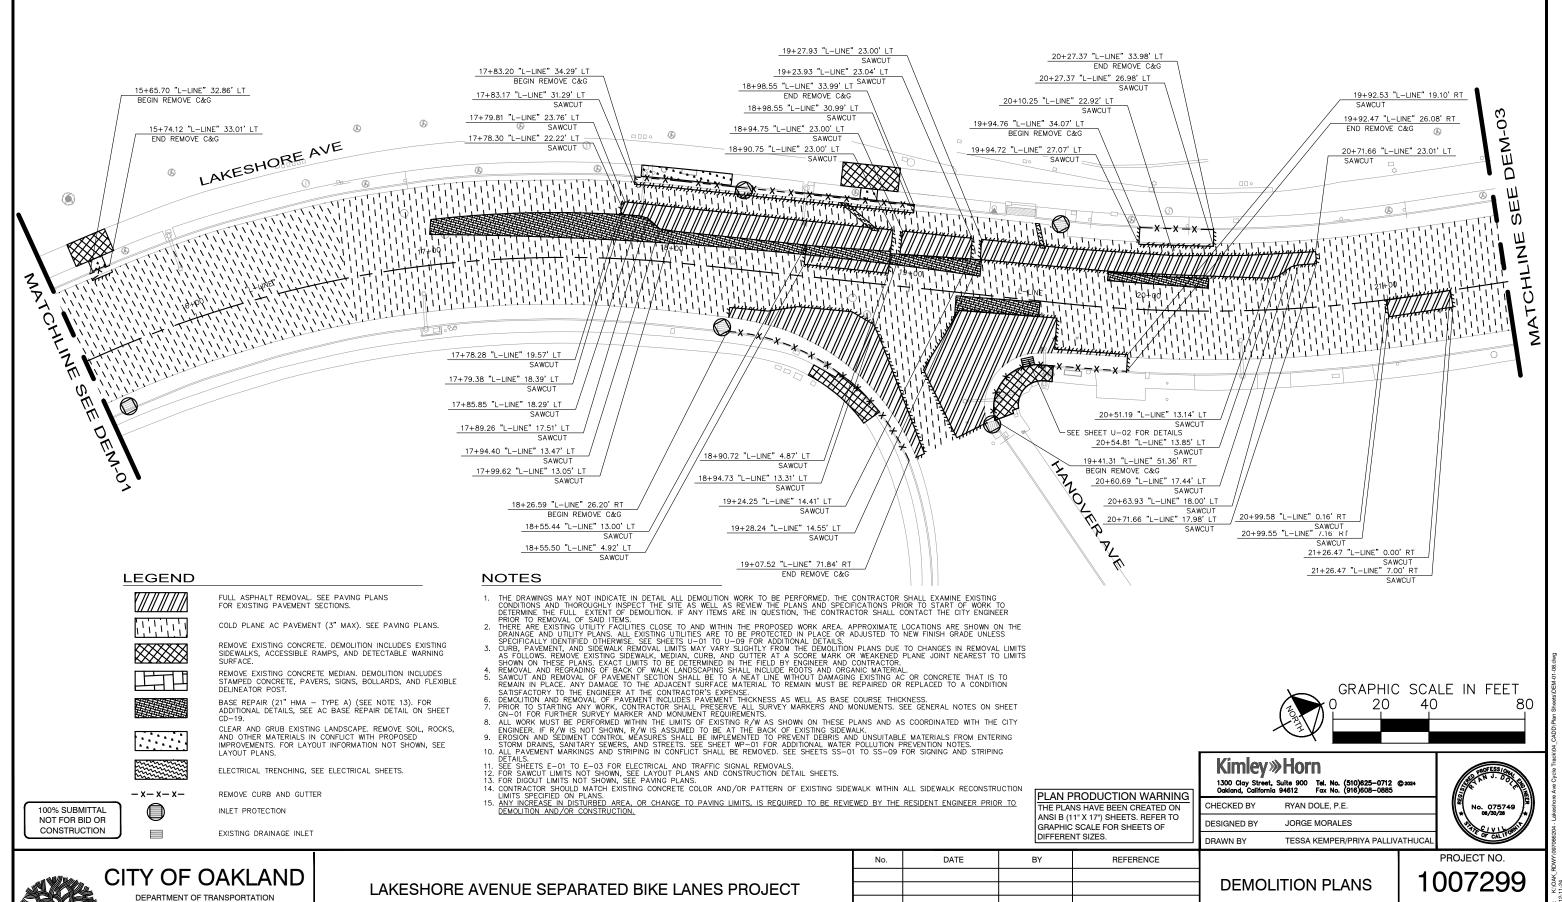

FROM E 18TH STREET TO MACARTHUR BOULEVARD


250 FRANK H. OGAWA PLAZA, SUITE 4314

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DEM-0211 of 83

AS SHOWN

SHEET NO.

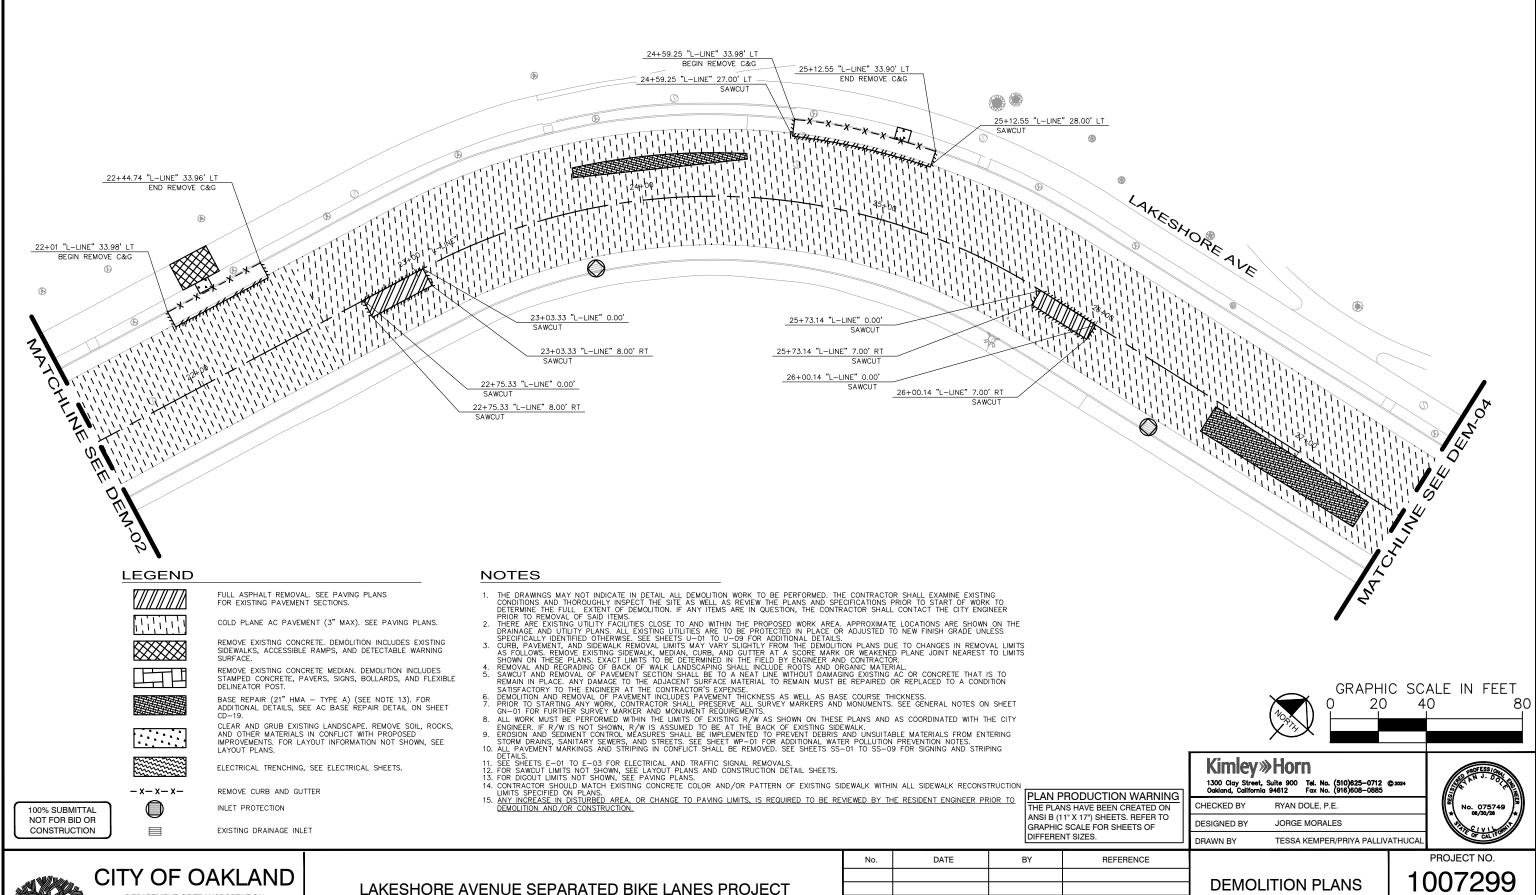


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FROM E 18TH STREET TO MACARTHUR BOULEVARD

No.	DATE	BY	REFERENCE	
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SHEET NO. DEM-03 12 oF 83



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No.	DATE	BY	REFERENCE	
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1007299

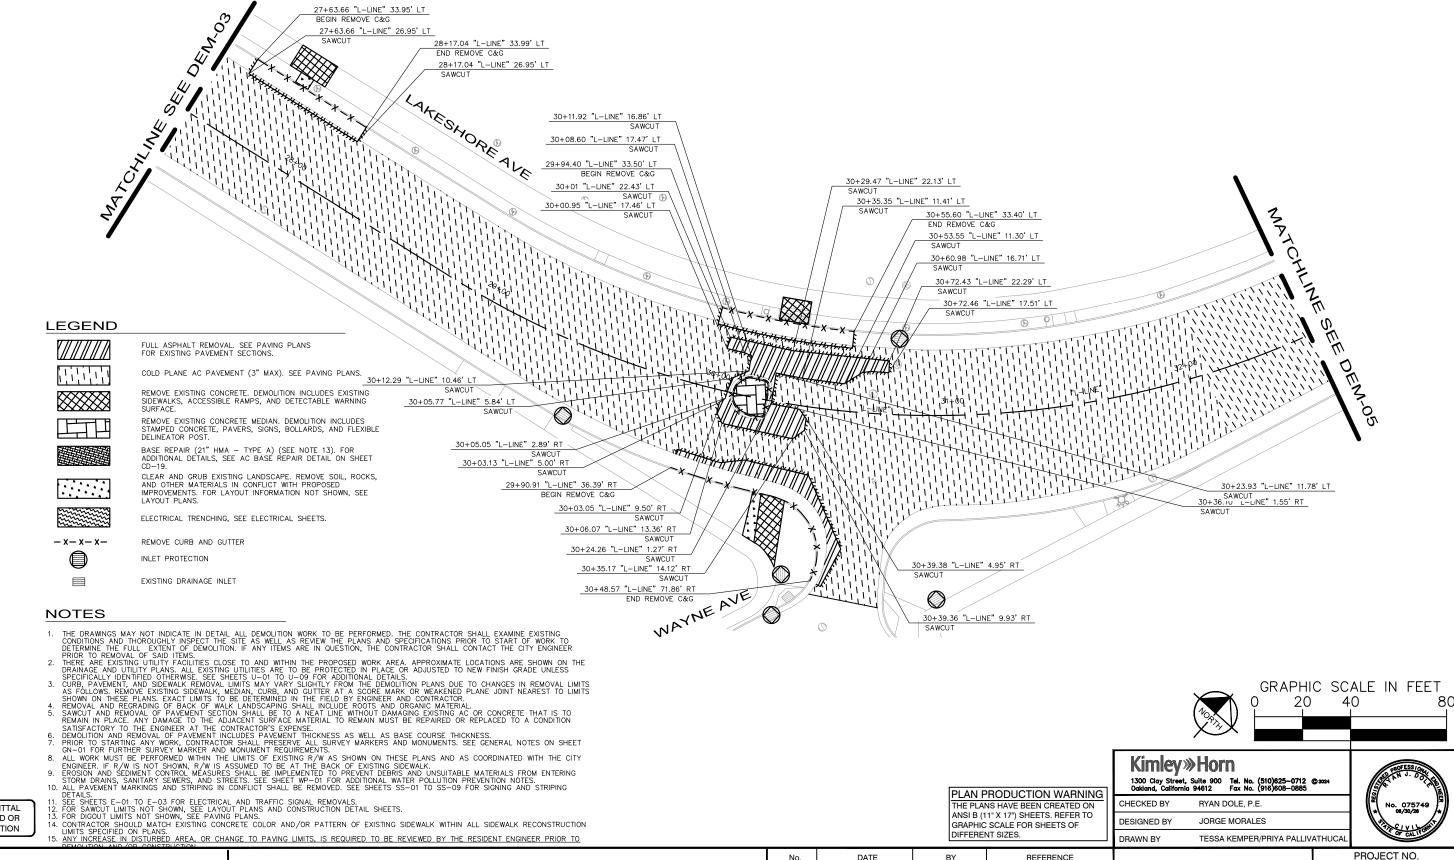SCALE: AS SHOWN

JORGE MORALES

TESSA KEMPER/PRIYA PALLIVATHUCAL

**DESIGNED BY** 


SHEET NO. DEM-04 13 of 83

PROJECT NO. DEMOLITION PLANS

DIFFERENT SIZES.

ANSI B (11" X 17") SHEETS, REFER TO

GRAPHIC SCALE FOR SHEETS OF

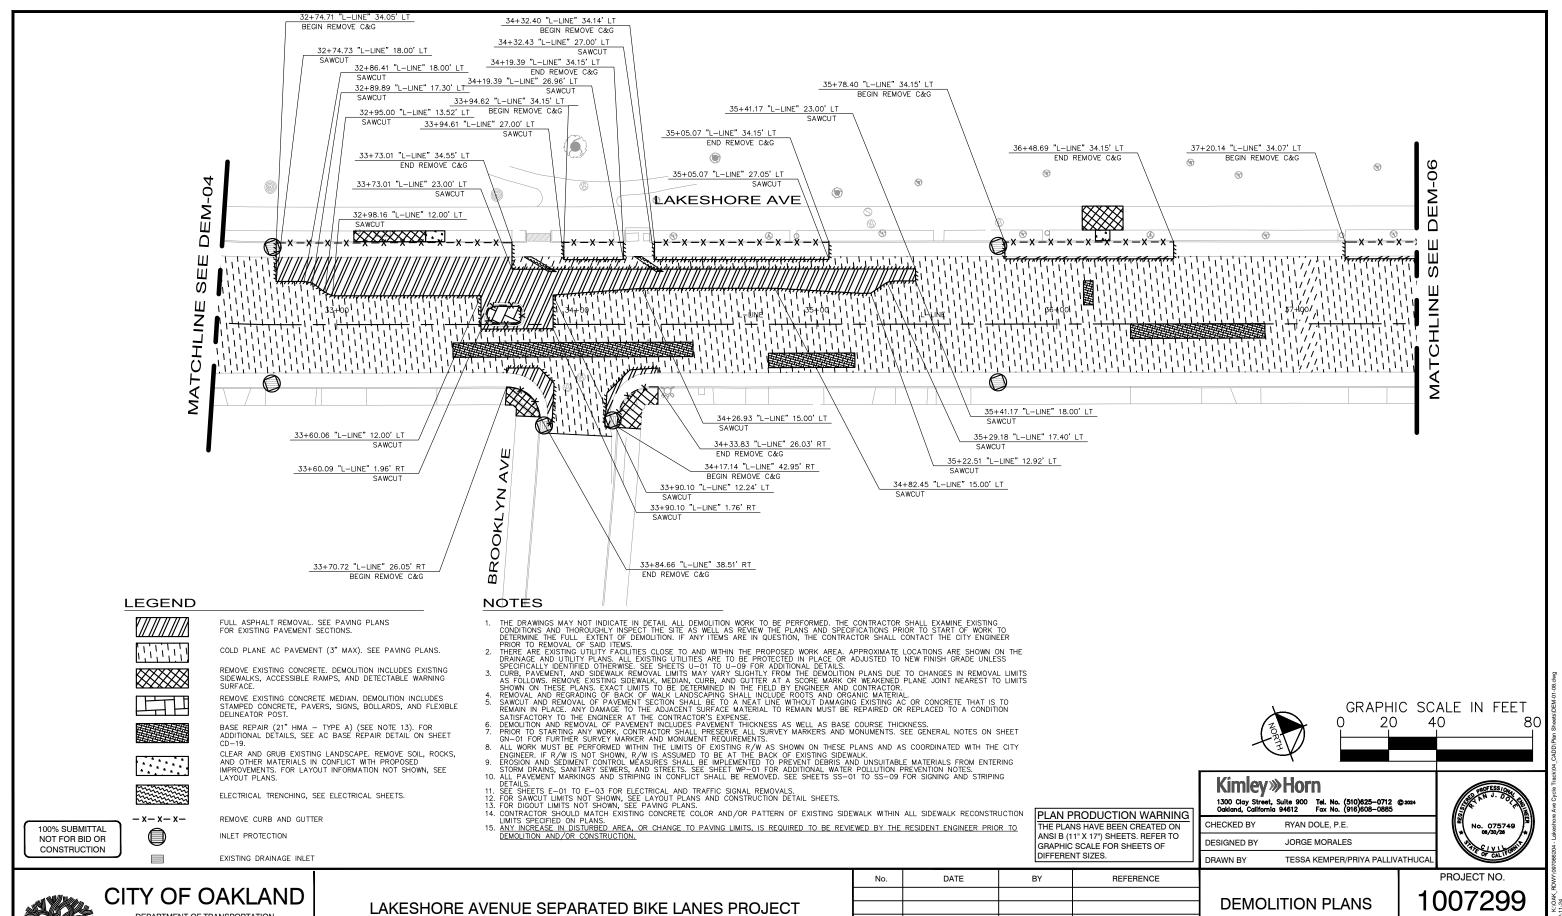


DEPARTMENT OF TRANSPORTATION

250 FRANK H. OGAWA PLAZA, SUITE 4314 OAKLAND, CA 94612 (510) 238-3437 FAX (510) 238-7227


FROM E 18TH STREET TO MACARTHUR BOULEVARD

No.	DATE	BY	REFERENCE

SHEET NO. AS SHOWN DEM-05 <u>14</u> of <u>83</u>

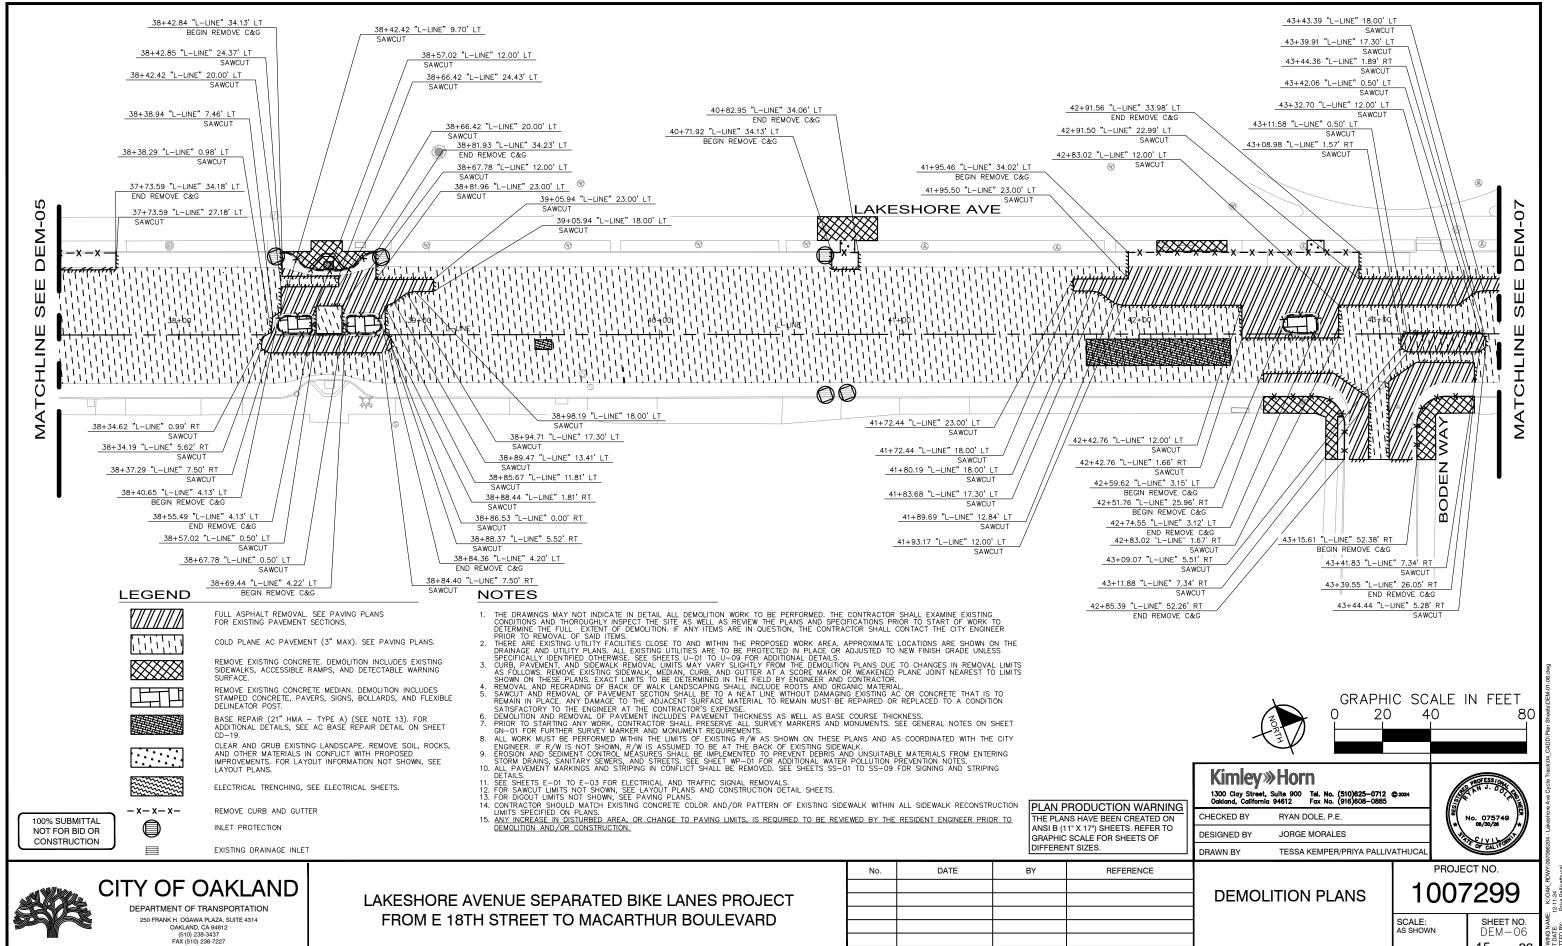

15 of 83

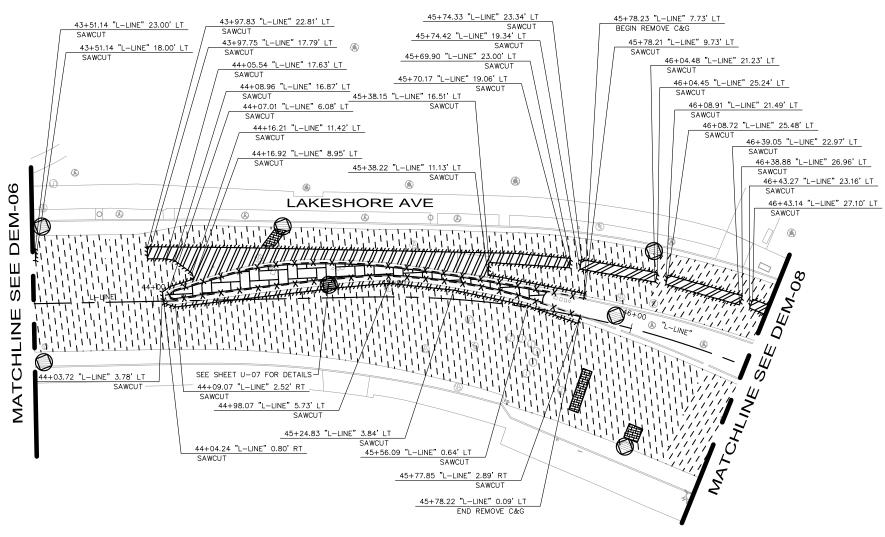

#### **LEGEND**

FULL ASPHALT REMOVAL. SEE PAVING PLANS FOR EXISTING PAVEMENT SECTIONS.

COLD PLANE AC PAVEMENT (3" MAX). SEE PAVING PLANS.

REMOVE EXISTING CONCRETE. DEMOLITION INCLUDES EXISTING SIDEWALKS, ACCESSIBLE RAMPS, AND DETECTABLE WARNING SURFACE.

REMOVE EXISTING CONCRETE MEDIAN. DEMOLITION INCLUDES STAMPED CONCRETE, PAVERS, SIGNS, BOLLARDS, AND FLEXIBLE DELINEATOR POST.

BASE REPAIR (21" HMA - TYPE A) (SEE NOTE 13), FOR ADDITIONAL DETAILS, SEE AC BASE REPAIR DETAIL ON SHEET CD-19.

CLEAR AND GRUB EXISTING LANDSCAPE. REMOVE SOIL, ROCKS, AND OTHER MATERIALS IN CONFLICT WITH PROPOSED IMPROVEMENTS. FOR LAYOUT INFORMATION NOT SHOWN, SEE

ELECTRICAL TRENCHING, SEE ELECTRICAL SHEETS

-x-x-x-

REMOVE CURB AND GUTTER

INLET PROTECTION

EXISTING DRAINAGE INLET

#### NOTES

- THE DRAWINGS MAY NOT INDICATE IN DETAIL ALL DEMOLITION WORK TO BE PERFORMED. THE CONTRACTOR SHALL EXAMINE EXISTING CONDITIONS AND THOROUGHLY INSPECT THE SITE AS WELL AS REVIEW THE PLANS AND SPECIFICATIONS PRIOR TO START OF WORK TO DETERMINE THE FULL EXTENT OF DEMOLITION. IF ANY ITEMS ARE IN QUESTION, THE CONTRACTOR SHALL CONTACT THE CITY ENGINEER PRIOR TO REMOVAL OF SAID ITEMS.

  THERE ARE EXISTING UTILITY FACILITIES CLOSE TO AND WITHIN THE PROPOSED WORK AREA, APPROXIMATE LOCATIONS ARE SHOWN ON THE DRAINAGE AND UTILITY PLANS. ALL EXISTING UTILITIES ARE TO BE PROTECTED IN PLACE OR ADJUSTED TO NEW FINISH GRADE UNLESS SPECIFICALLY IDENTIFIED OTHERWISE. SEE SHEETS U-01 TO U-09 FOR ADDITIONAL DETAILS.

  CURB, PAYEMENT, AND SIDEWALK REMOVAL LIMITS MAY VARY SLIGHTLY FROM THE DEMOLITION PLANS DUE TO CHANGES IN REMOVAL LIMITS AS FOLLOWS. REMOVE EXISTING SIDEWALK, MEDIAN, CURB, AND GUTTER AT A SCORE MARK OR WEAKENED PLANE JOINT NEAREST TO LIMITS SHOWN ON THESE PLANS. EXACT LIMITS TO BE DETERMINED IN THE FIELD BY ENGINEER AND CONTRACTOR.

  REMOVAL AND REGRADING OF BACK OF WALK LANDSCAPING SHALL INCLUDE ROOTS AND ORGANIC MATERIAL.

  SAWCUT AND REMOVAL OF PAYEMENT SECTION SHALL BE TO A NEAT LINE WITHOUT DAMAGING EXISTING AC OR CONCRETE THAT IS TO REMAIN IN PLACE. ANY DAMAGE TO THE ADJACENT SURFACE MATERIAL TO REMAIN MUST BE REPAIRED OR REPLACED TO A CONDITION SATISFACTORY TO THE ENGINEER AT THE CONTRACTOR'S EXPENSE.

  DEMOLITION AND REMOVAL OF PAYEMENT INCLUDES PAYEMENT THICKNESS AS WELL AS BASE COURSE THICKNESS.

  PRIOR TO STARTING ANY WORK, CONTRACTOR SHALL PRESERVE ALL SURVEY MARKERS AND MONUMENTS. SEE GENERAL NOTES ON SHEET GN-01 FOR FURTHER SURVEY MARKER AND MONUMENT REQUIREMENTS.

  ALL WORK MUST BE PERFORMED WITHIN THE LIMITS OF EXISTING R/W AS SHOWN ON THESE PLANS AND AS COORDINATED WITH THE CITY ENGINEER. IF R/W IS NOT SHOWN, R/W IS ASSUMED TO BE AT THE BACK OF EXISTING SIDEWALK.

  EROSION AND SEDIMENT CONTROL MEASURES SHALL BE IMPLEMENTED TO PREVENT DEBRIS AND UNSUITABLE MATERIALS FROM ENTERING STORM DRAINS, SANITARY SEWER

- 10. ALL PAVEMENT MARKINGS AND STRIPING IN CONFLICT SHALL BE REMOVED. SEE SHEETS SS-01 TO SS-09 FOR SIGNING AND STRIPING DETAILS.

  11. SEE SHEETS E-01 TO E-03 FOR ELECTRICAL AND TRAFFIC SIGNAL REMOVALS.

  12. FOR SAWCUT LIMITS NOT SHOWN, SEE LAYOUT PLANS AND CONSTRUCTION DETAIL SHEETS.

  13. FOR DIGOUT LIMITS NOT SHOWN, SEE PAVING PLANS.

  14. CONTRACTOR SHOULD MATCH EXISTING CONCRETE COLOR AND/OR PATTERN OF EXISTING SIDEWALK WITHIN ALL SIDEWALK RECONSTRUCTION LIMITS SPECIFIED ON PLANS.

  15. ANY INCREASE IN DISTURBED AREA, OR CHANGE TO PAVING LIMITS, IS REQUIRED TO BE REVIEWED BY THE RESIDENT ENGINEER PRIOR TO DEMOLITION AND/OR CONSTRUCTION.



GRAPHIC SCALE IN FEET 40

## **Kimley** »Horn

CHECKED B1	NTAIN DOLE, P.E.
DESIGNED BY	JORGE MORALES
DRAWN BY	TESSA KEMPER/PRIYA PALLIVATHUCAL



PROJECT NO.

100% SUBMITTAL

NOT FOR BID OR

CONSTRUCTION

CITY OF OAKLAND

DEPARTMENT OF TRANSPORTATION 250 FRANK H. OGAWA PLAZA, SUITE 4314 OAKLAND, CA 94612 (510) 238-3437 FAX (510) 238-7227

LAKESHORE AVENUE SEPARATED BIKE LANES PROJECT FROM E 18TH STREET TO MACARTHUR BOULEVARD

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DATE

PLAN PRODUCTION WARNING THE PLANS HAVE BEEN CREATED ON

ANSI B (11" X 17") SHEETS, REFER TO

REFERENCE

GRAPHIC SCALE FOR SHEETS OF


DIFFERENT SIZES.

**DEMOLITION PLANS** 

1007299

SCALE: SHEET NO. AS SHOWN

DEM-07 16 OF 83

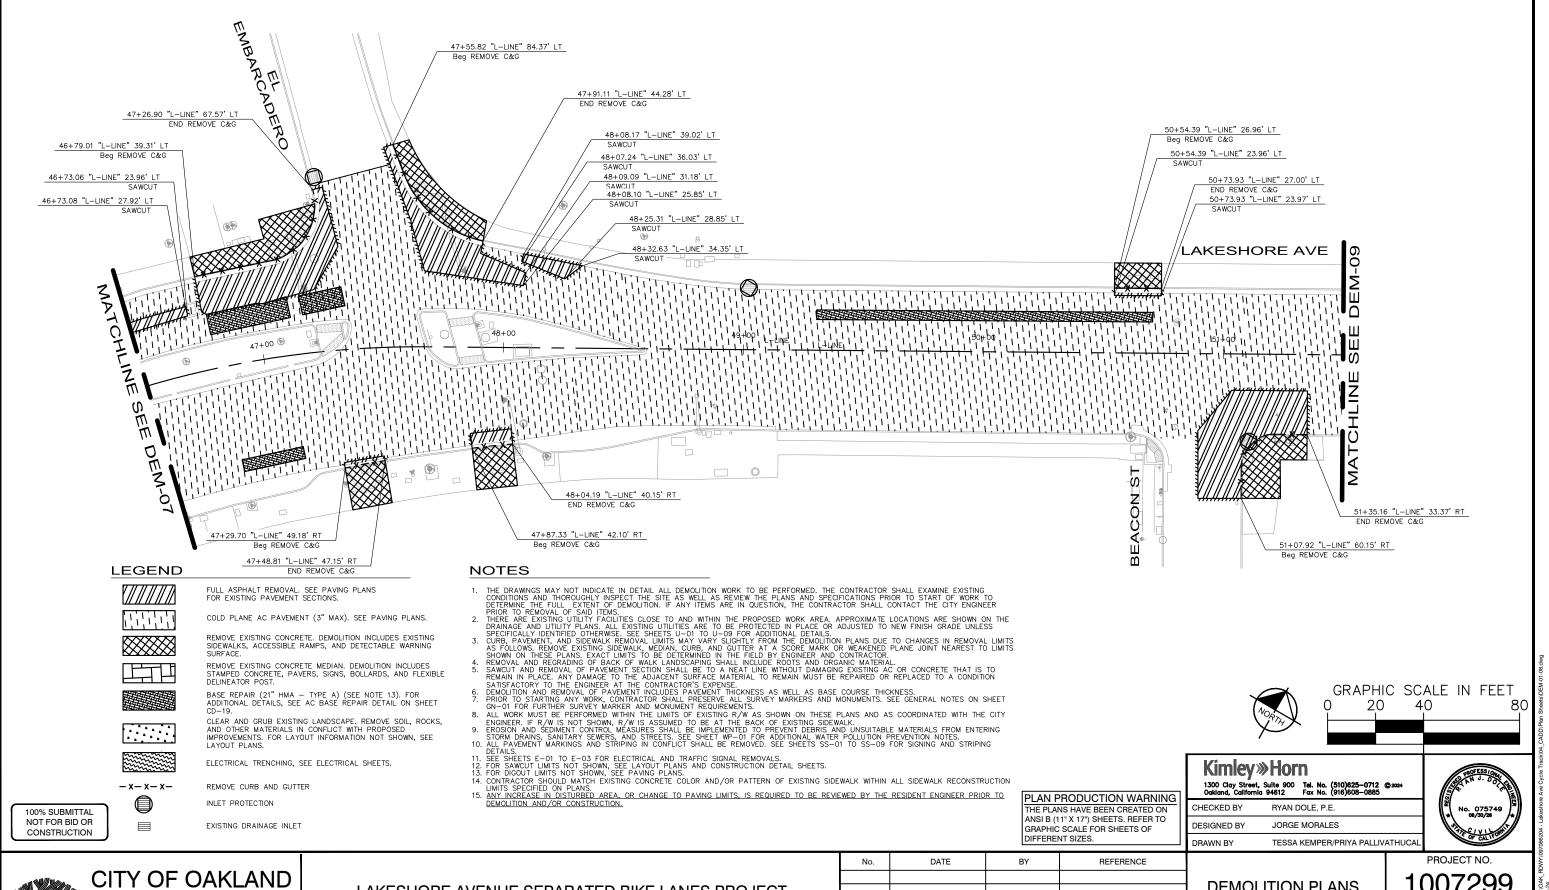

DEPARTMENT OF TRANSPORTATION 250 FRANK H. OGAWA PLAZA, SUITE 4314 OAKLAND, CA 94612 (510) 238-3437 FAX (510) 238-7227


LAKESHORE AVENUE SEPARATED BIKE LANES PROJECT FROM E 18TH STREET TO MACARTHUR BOULEVARD

**DEMOLITION PLANS** 

1007299

AS SHOWN

SHEET NO. DEM-08 17 <sub>of</sub> 83

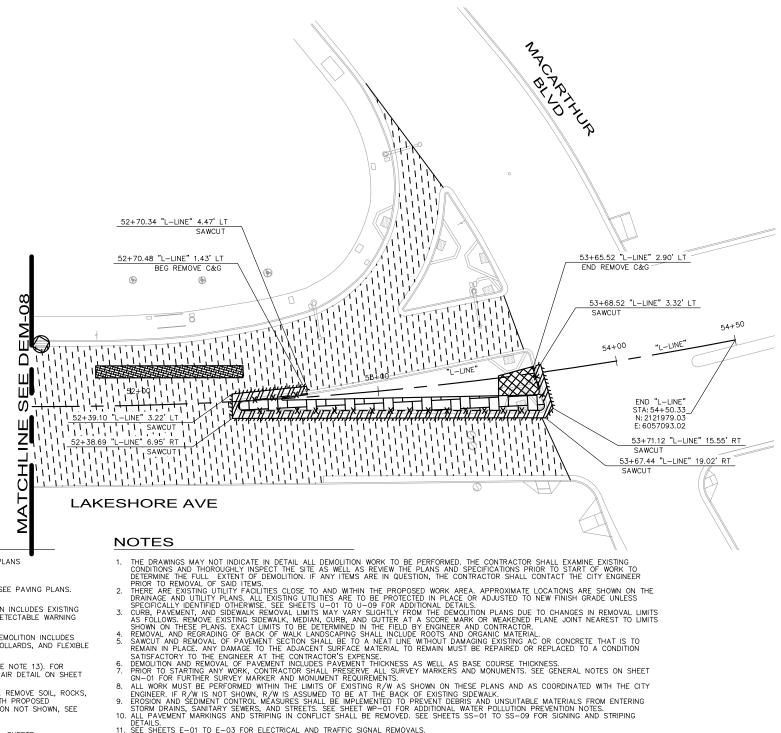

**LEGEND** 

FULL ASPHALT REMOVAL. SEE PAVING PLANS FOR EXISTING PAVEMENT SECTIONS.

COLD PLANE AC PAVEMENT (3" MAX). SEE PAVING PLANS. REMOVE EXISTING CONCRETE. DEMOLITION INCLUDES EXISTING



SIDEWALKS, ACCESSIBLE RAMPS, AND DETECTABLE WARNING SURFACE. REMOVE EXISTING CONCRETE MEDIAN, DEMOLITION INCLUDES STAMPED CONCRETE, PAVERS, SIGNS, BOLLARDS, AND FLEXIBLE DELINEATOR POST.



BASE REPAIR (21" HMA - TYPE A) (SEE NOTE 13). FOR ADDITIONAL DETAILS, SEE AC BASE REPAIR DETAIL ON SHEET CD-19.



CLEAR AND GRUB EXISTING LANDSCAPE. REMOVE SOIL, ROCKS, AND OTHER MATERIALS IN CONFLICT WITH PROPOSED IMPROVEMENTS. FOR LAYOUT INFORMATION NOT SHOWN, SEE



OAKLAND, CA 94612 (510) 238-3437 FAX (510) 238-7227

ELECTRICAL TRENCHING, SEE ELECTRICAL SHEETS.



REMOVE CURB AND GUTTER INLET PROTECTION



EXISTING DRAINAGE INLET

10. ALL PAVEMENT MARKINGS AND STRIPTING IN CONFIGURE STANDED BY THE RESIDENCE OF THE RESIDE

GRAPHIC SCALE IN FEET 80

## **Kimley** »Horn

PLAN PRODUCTION WARNING	Oakiana, California	194612 Fax No. (916)606-0865
THE PLANS HAVE BEEN CREATED ON	CHECKED BY	RYAN DOLE, P.E.
ANSI B (11" X 17") SHEETS. REFER TO GRAPHIC SCALE FOR SHEETS OF	DESIGNED BY	JORGE MORALES
DIFFERENT SIZES.	DRAWN BY	TESSA KEMPER/PRIYA PALLIVATHUCAL

PROJECT NO.

**DEMOLITION PLANS** 

1007299

AS SHOWN

DEM-09 18 <sub>OF</sub> 83

CITY OF OAKLAND DEPARTMENT OF TRANSPORTATION 250 FRANK H. OGAWA PLAZA, SUITE 4314

100% SUBMITTAL

NOT FOR BID OR


CONSTRUCTION

LAKESHORE AVENUE SEPARATED BIKE LANES PROJECT FROM E 18TH STREET TO MACARTHUR BOULEVARD

DATE

REFERENCE

SHEET NO.

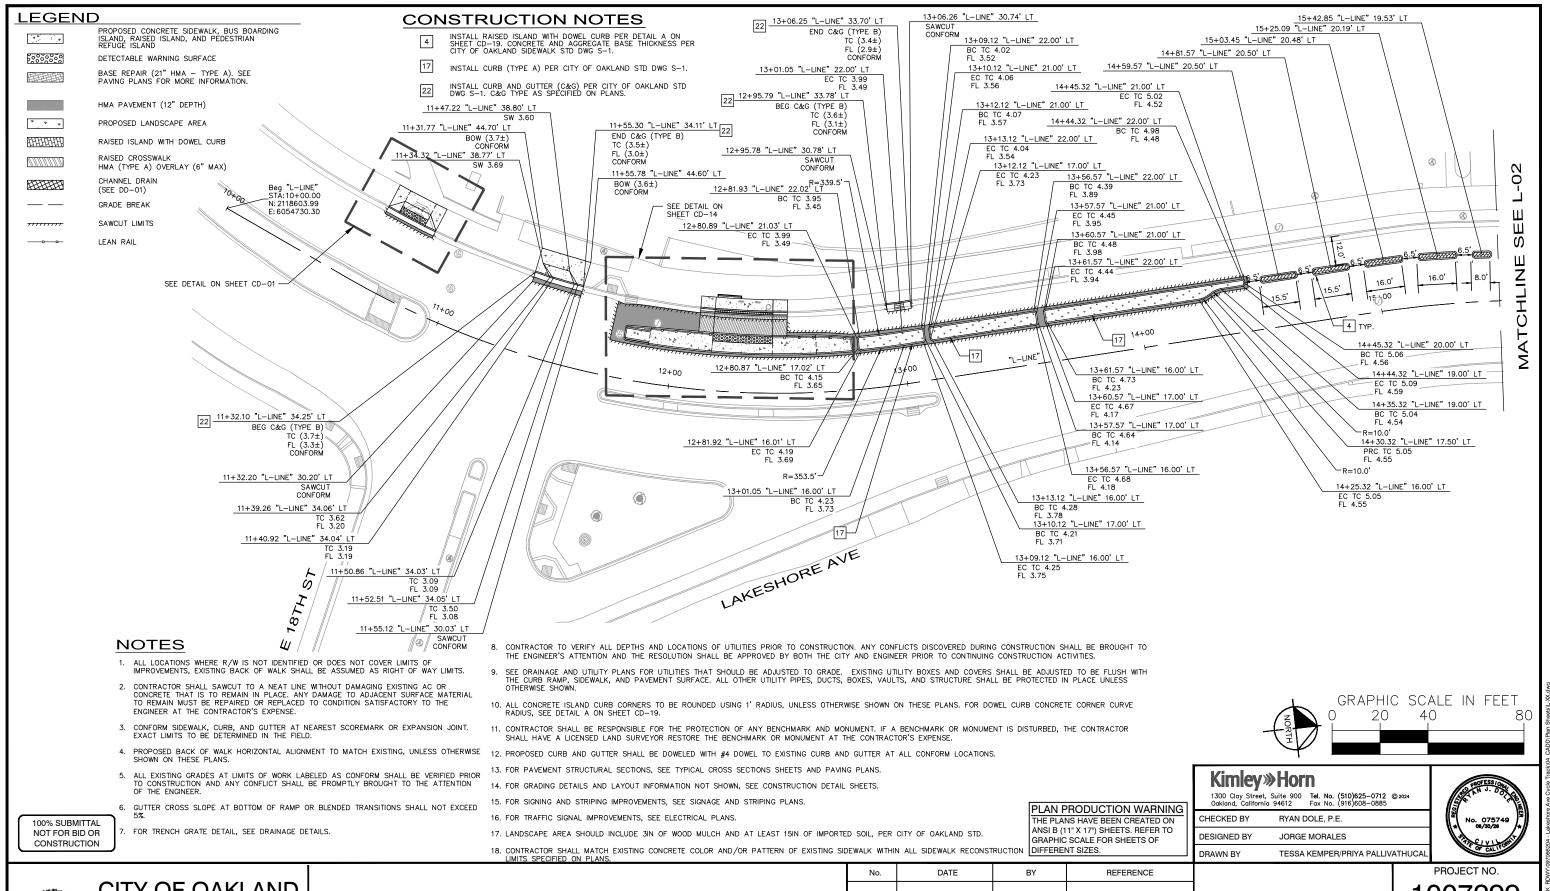

CITY OF OAKLAND

DEPARTMENT OF TRANSPORTATION 250 FRANK H. OGAWA PLAZA, SUITE 4314 OAKLAND, CA 94612 (510) 238-3437 FAX (510) 238-7227


LAKESHORE AVENUE SEPARATED BIKE LANES PROJECT FROM E 18TH STREET TO MACARTHUR BOULEVARD

LAYOUT


1007299


AS SHOWN


SHEET NO. L - 0119 of 83

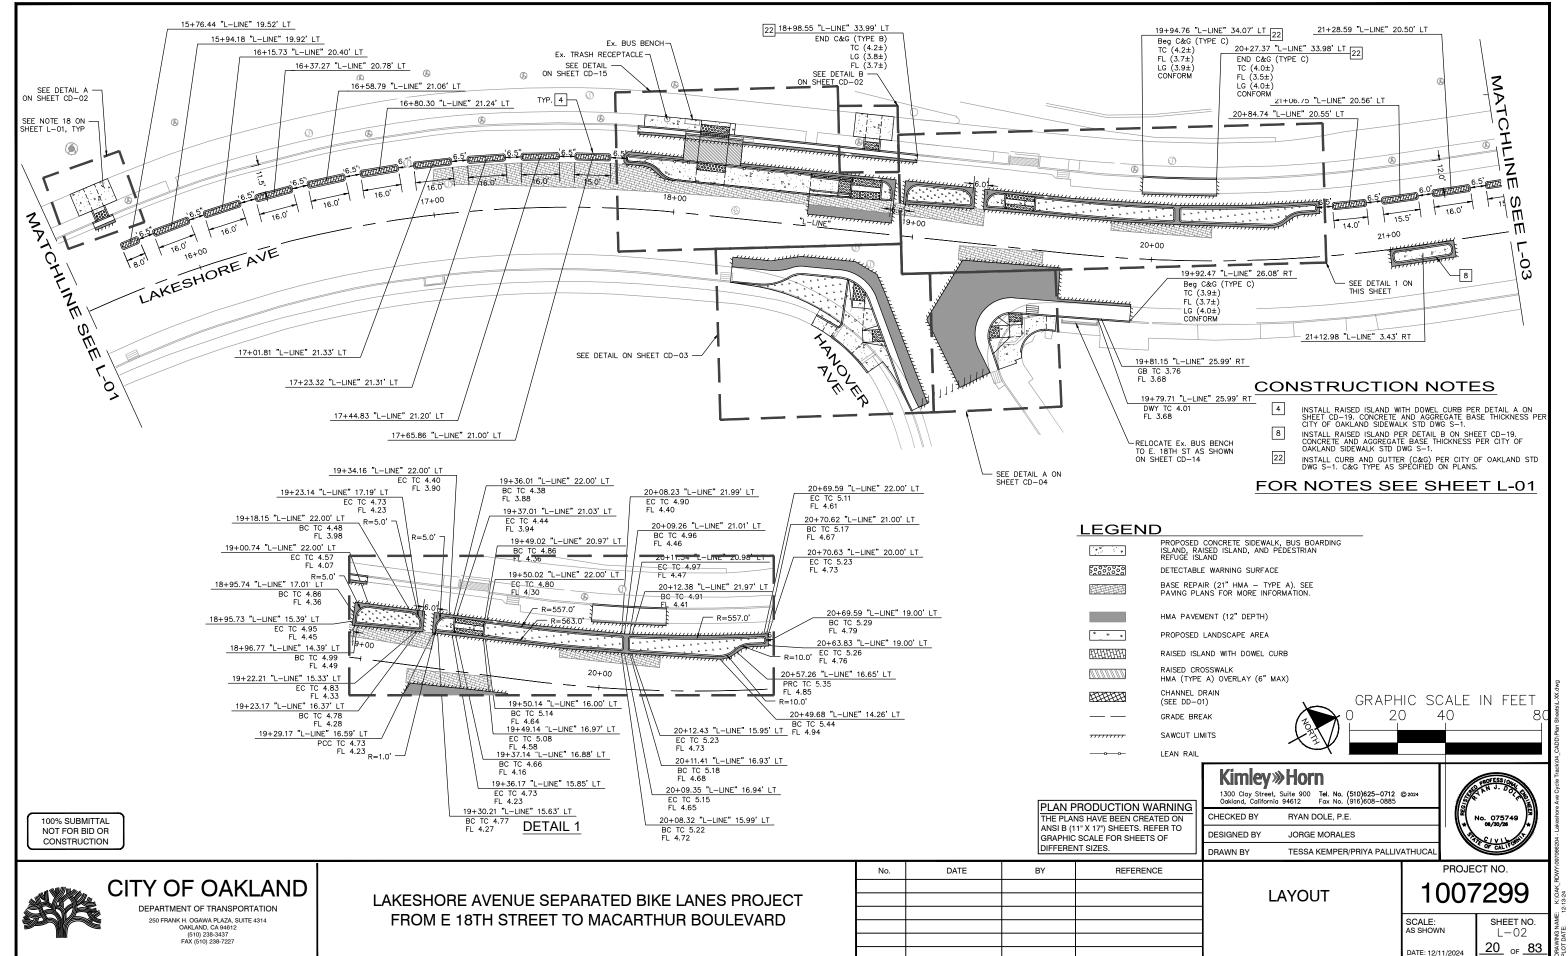


IG NAME: K:\OAK\_RDWY\097066204 - Lakes ATE: 12-13-24 D BY: Priya.Paliwathucal

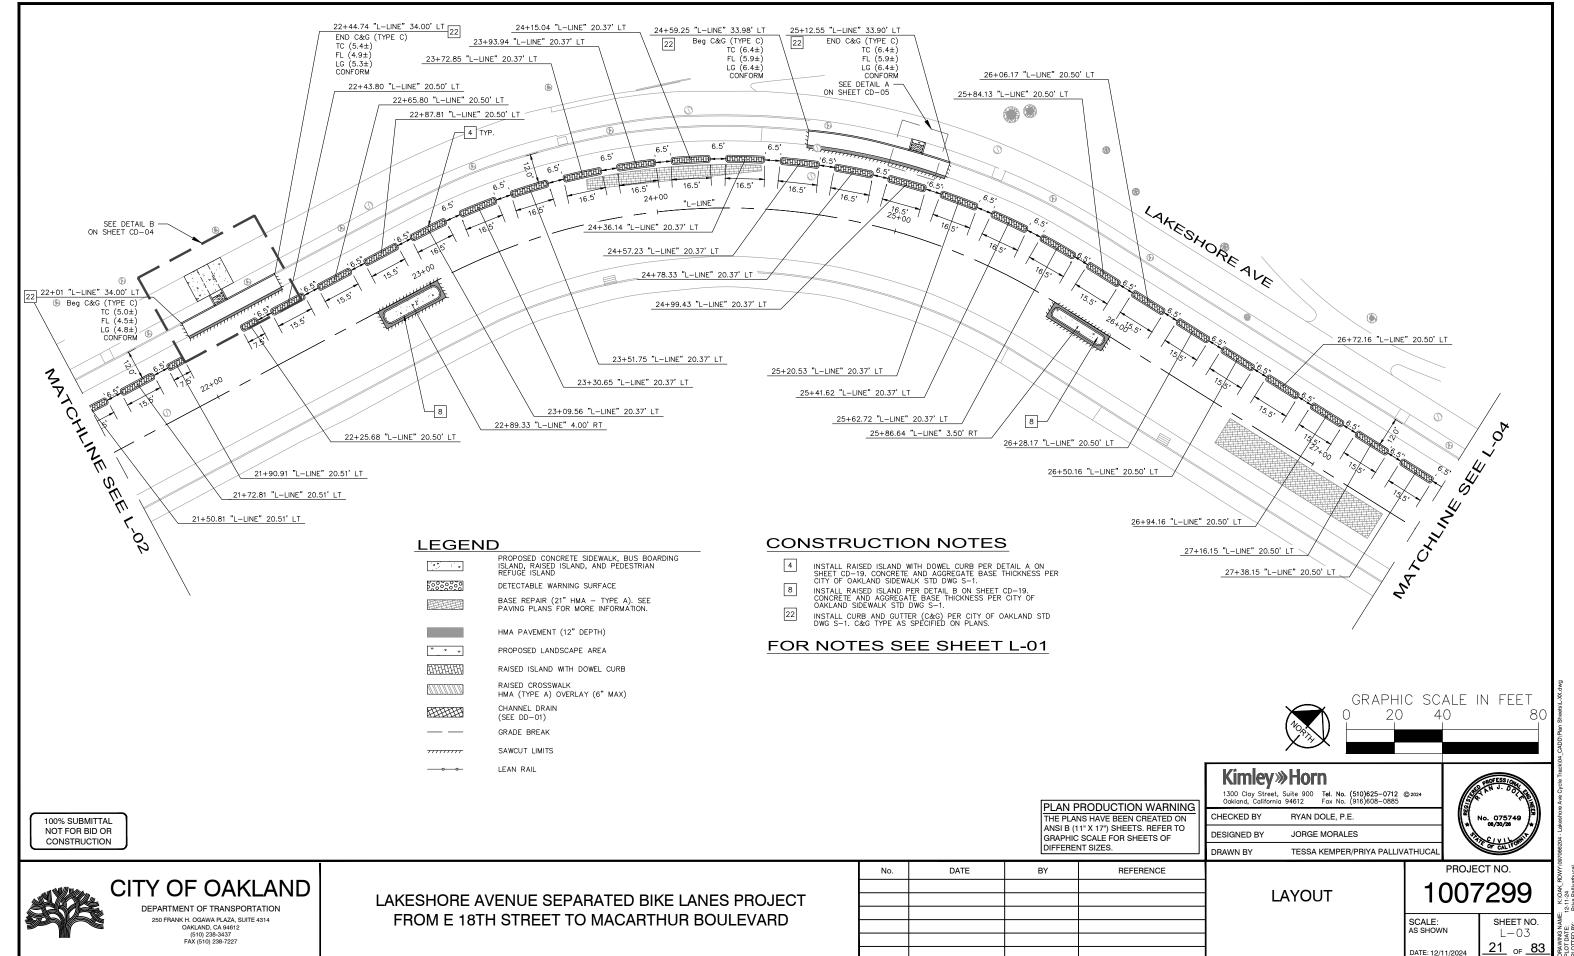


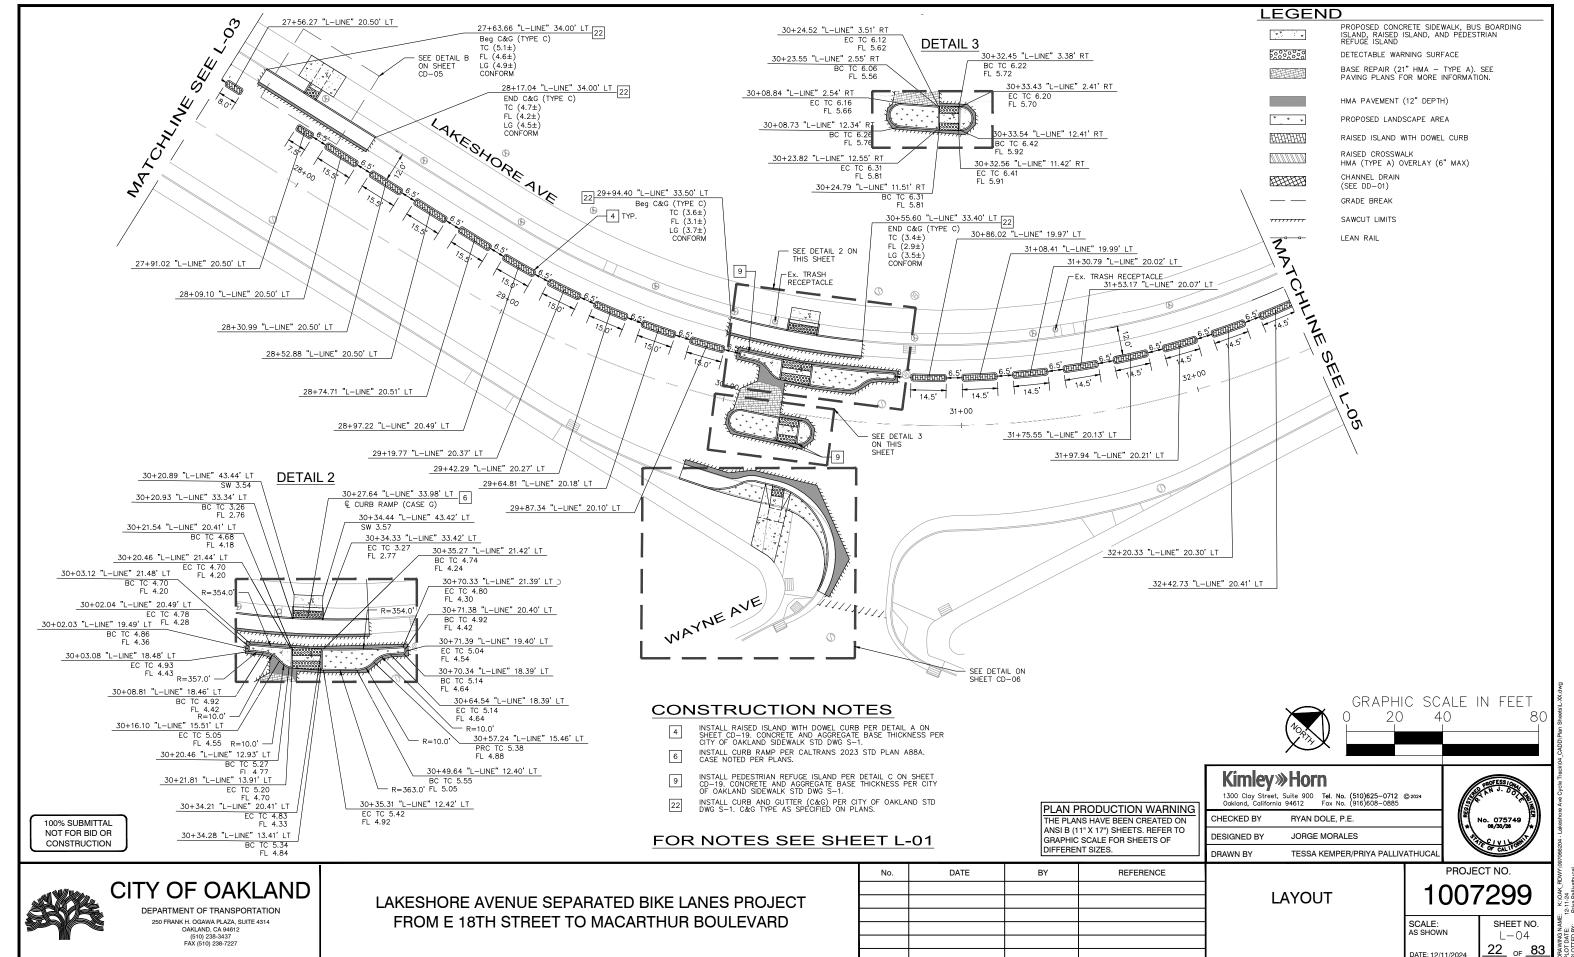

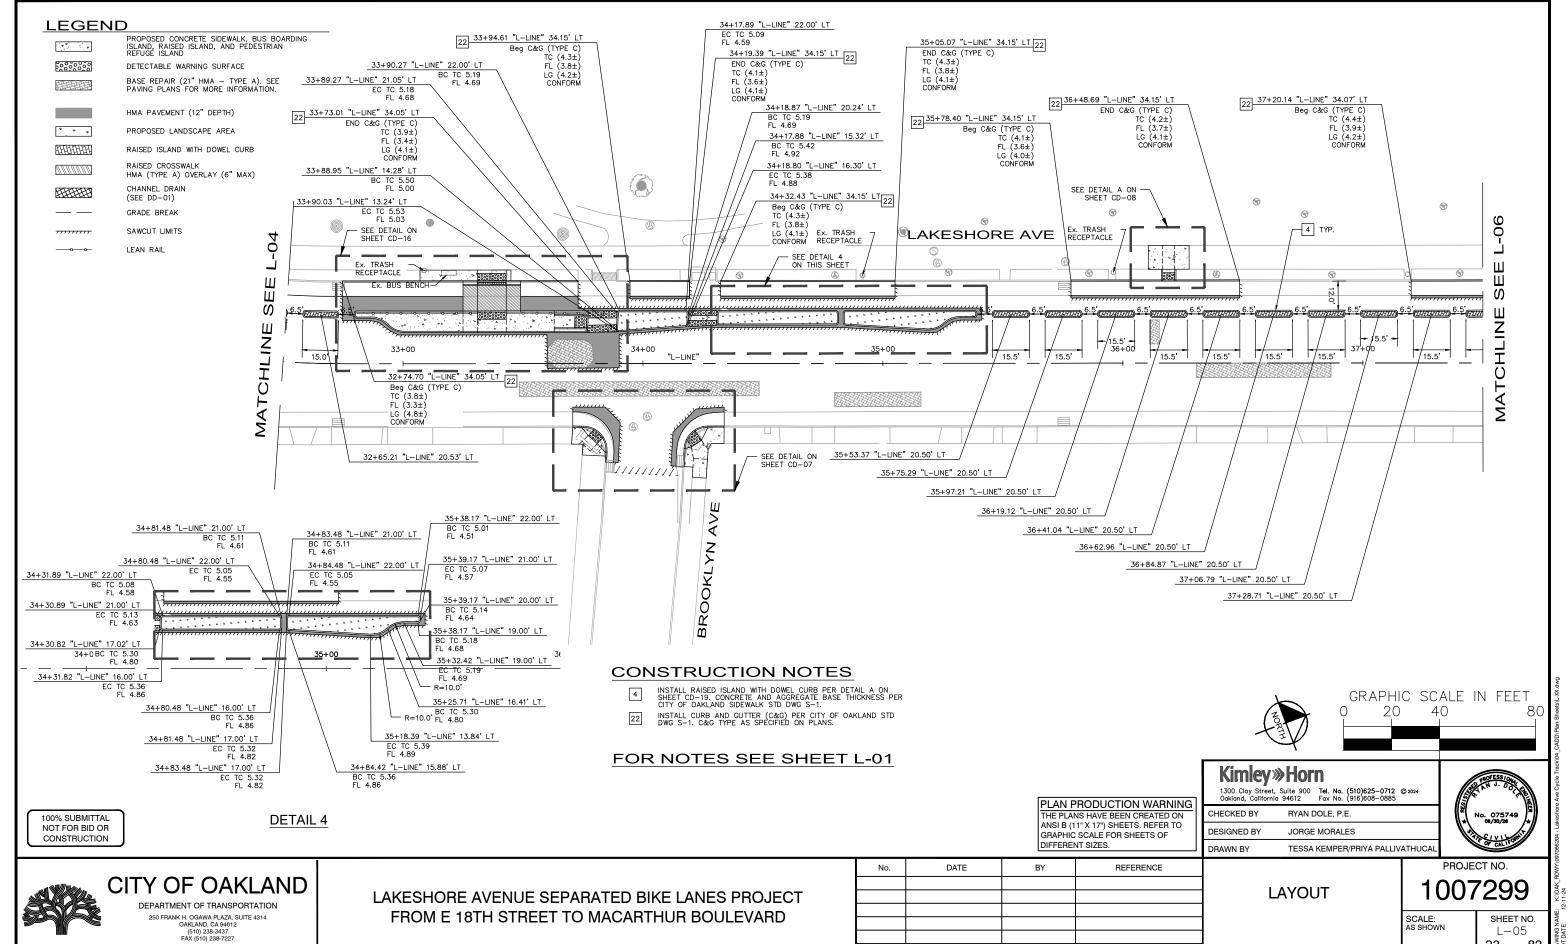

23 of 83

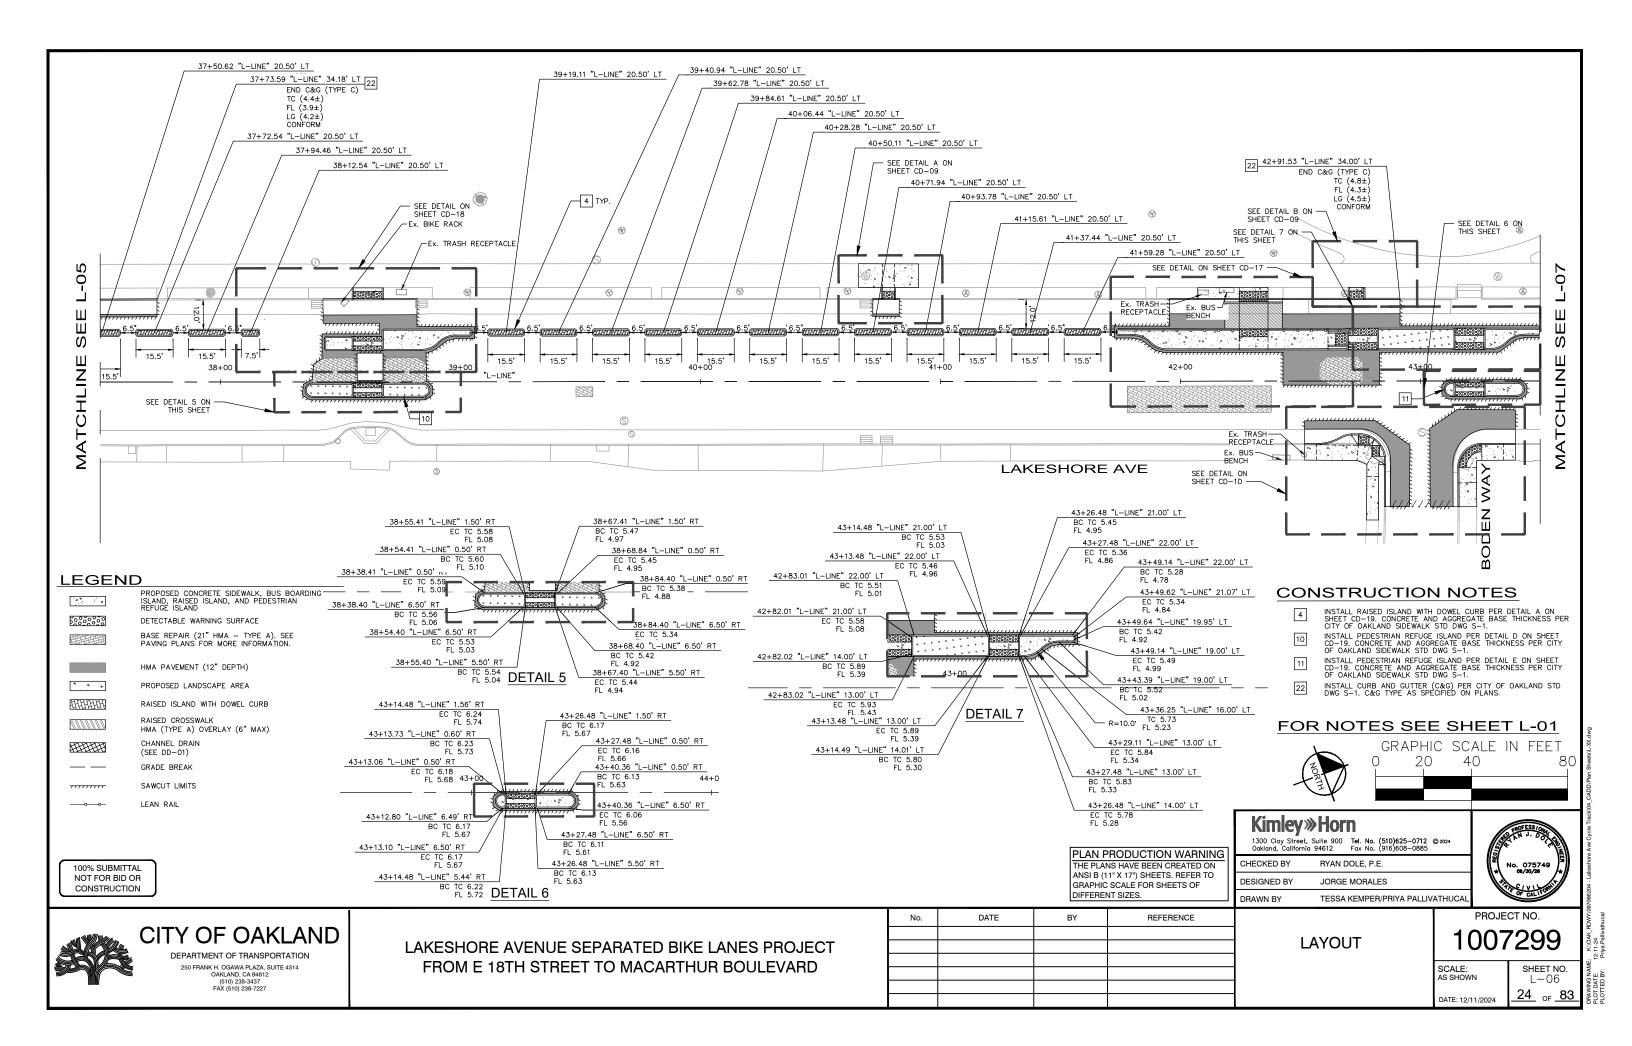

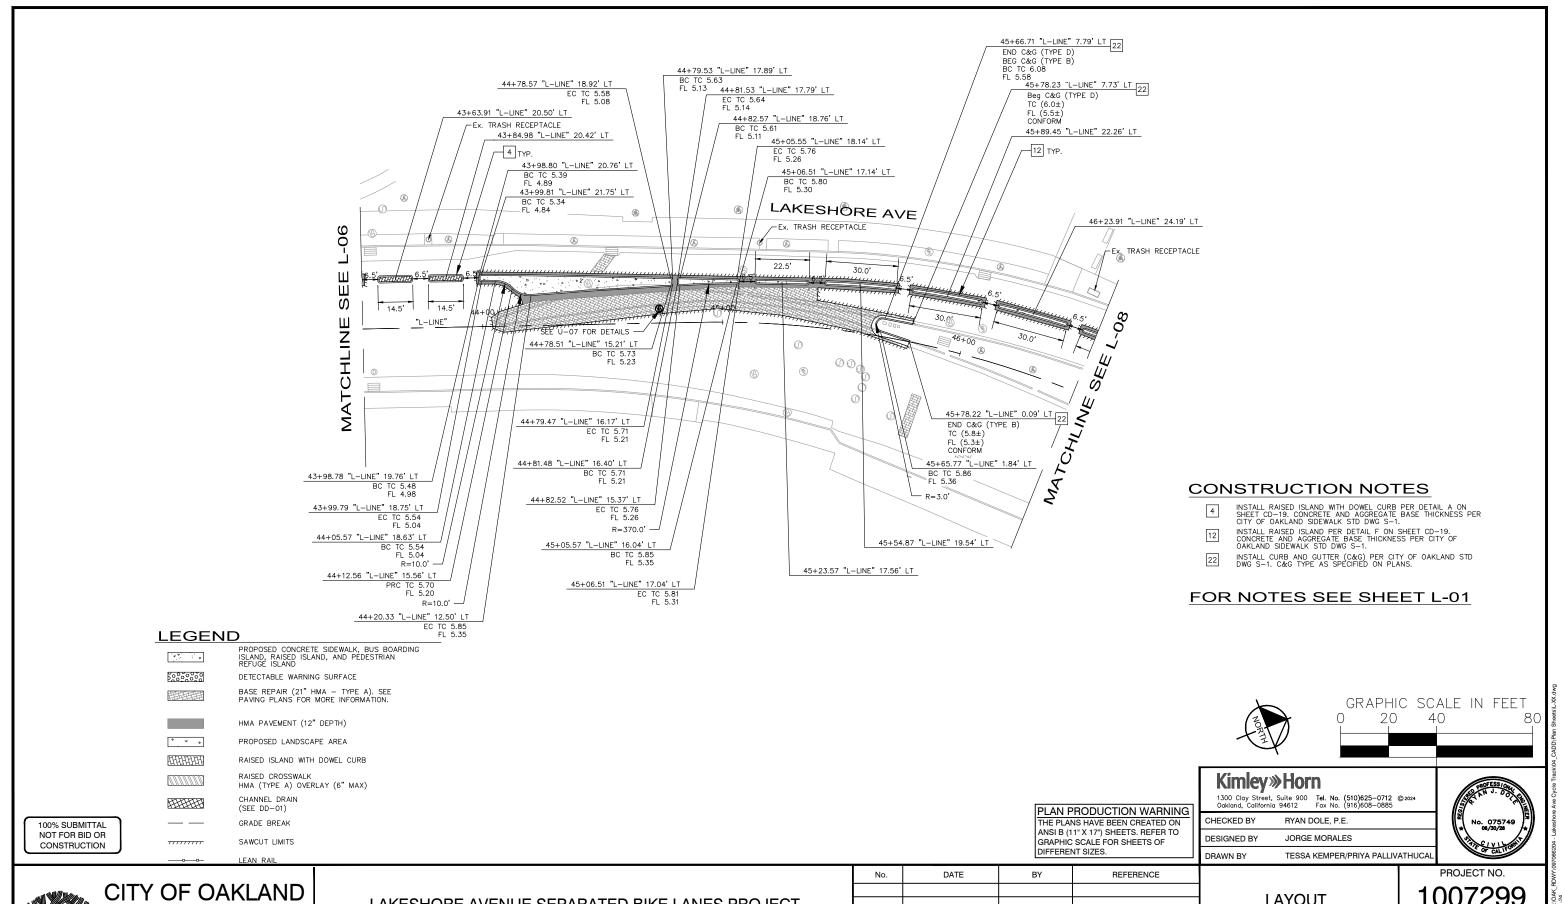

DEPARTMENT OF TRANSPORTATION 250 FRANK H. OGAWA PLAZA, SUITE 4314 OAKLAND, CA 94612 (510) 238-3437 FAX (510) 238-7227

LAKESHORE AVENUE SEPARATED BIKE LANES PROJECT FROM E 18TH STREET TO MACARTHUR BOULEVARD


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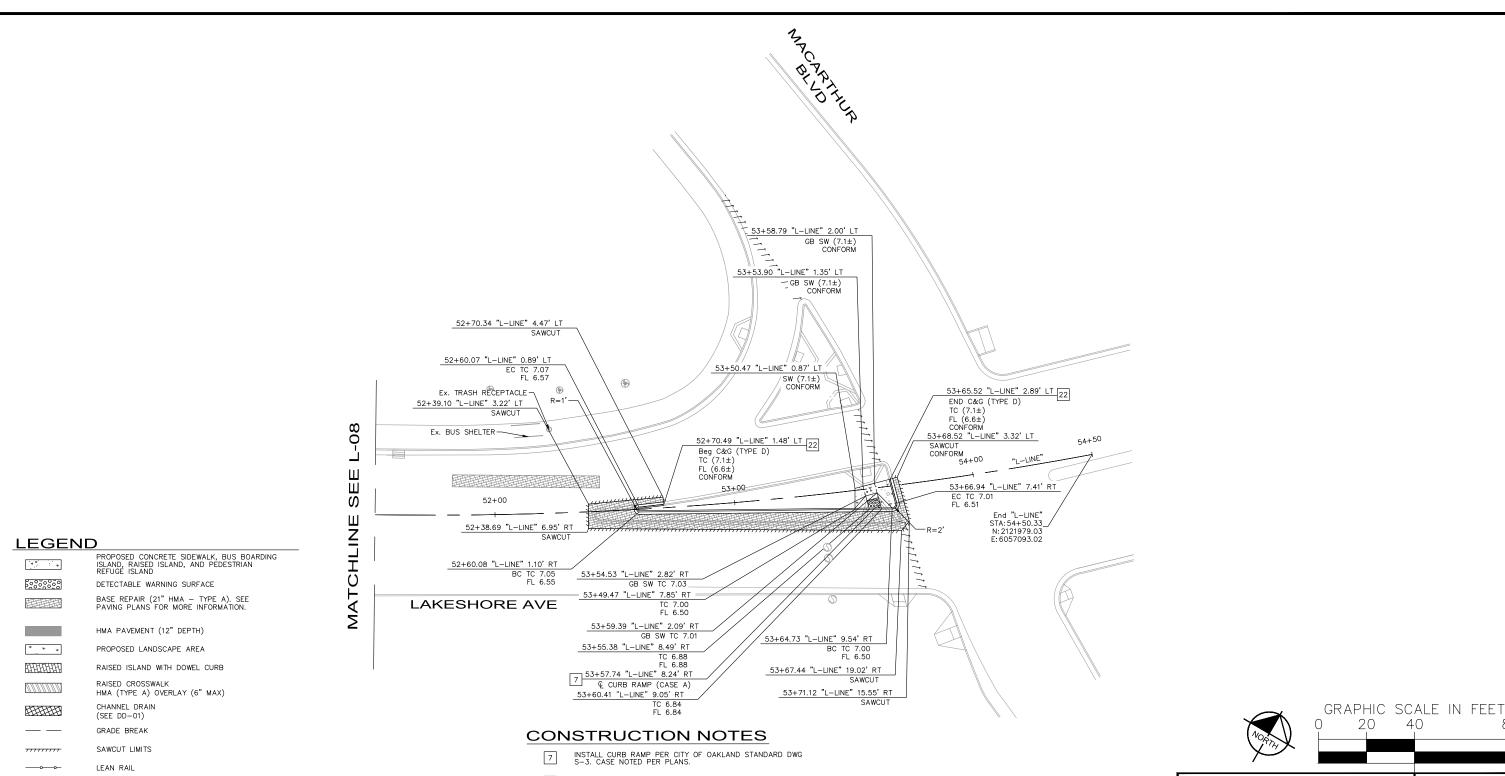
SCALE: AS SHOWN

SHEET NO. L - 0725<sub>OF</sub> 83



3 NAME: K:\OAK\_BDWY\097066204 - Lake TE: 12-11-24 f BY: Priya.Pallivathucal

26 <sub>OF</sub> 83

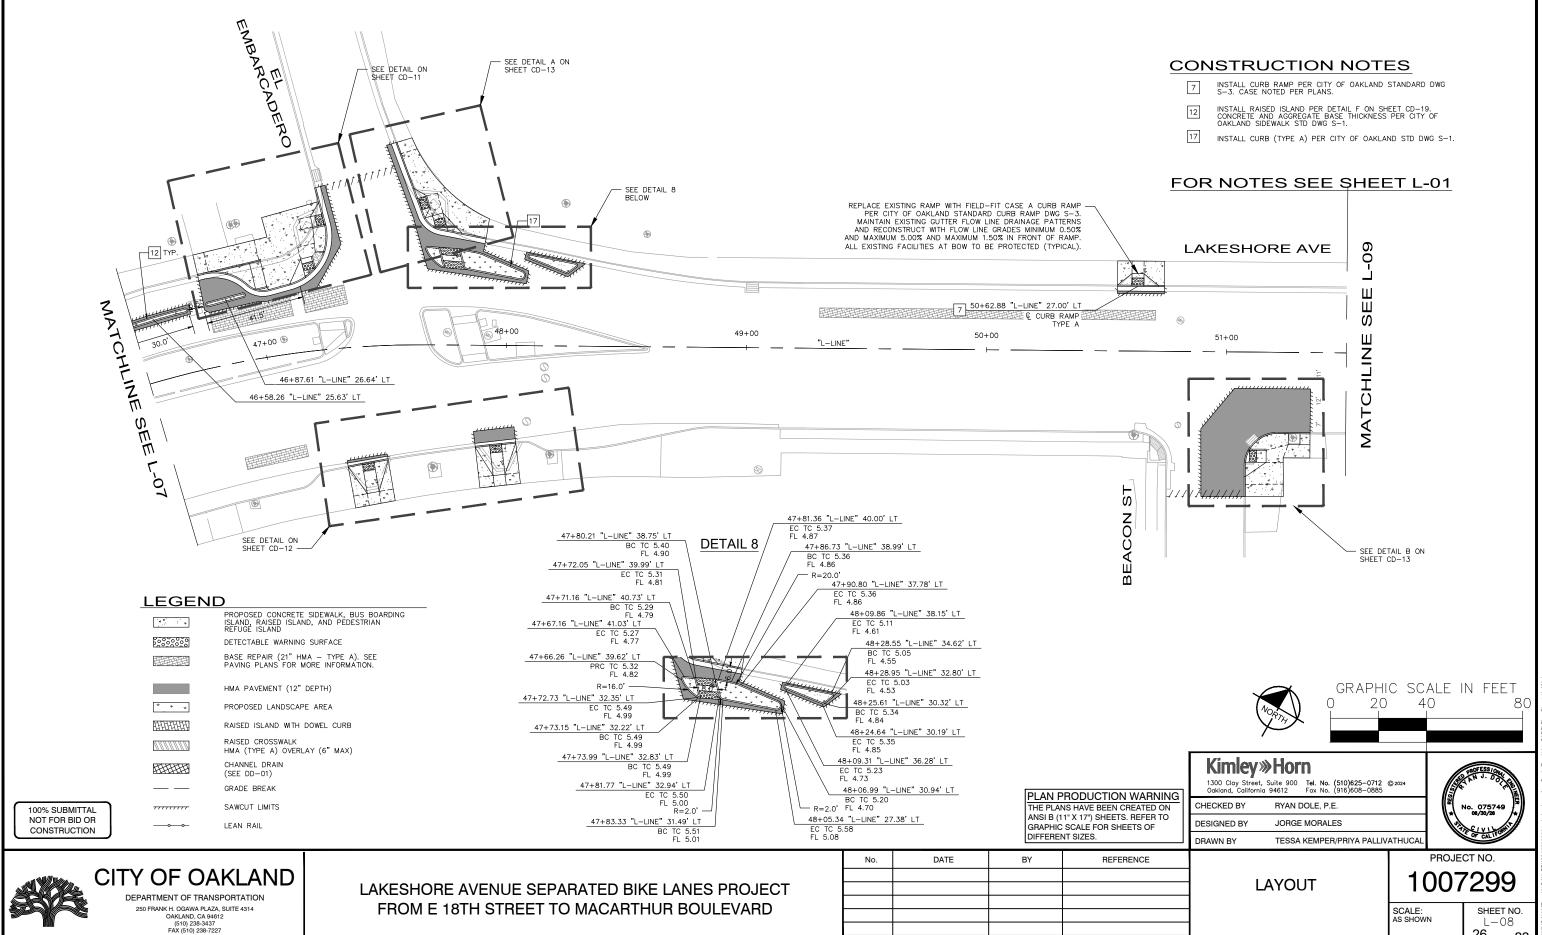

INSTALL CURB AND GUTTER (C&G) PER CITY OF OAKLAND STD DWG S-1. C&G TYPE AS SPECIFIED ON PLANS.

THE PLANS HAVE BEEN CREATED ON ANSI B (11" X 17") SHEETS. REFER TO FOR NOTES SEE SHEET L-01 GRAPHIC SCALE FOR SHEETS OF DIFFERENT SIZES.

**Kimley** »Horn

DRAWN BY

CHECKED BY RYAN DOLE, P.E. JORGE MORALES DESIGNED BY

No. 075749 08/30/28 TESSA KEMPER/PRIYA PALLIVATHUCAL



PROJECT NO.

100% SUBMITTAL

CONSTRUCTION

NOT FOR BID OR

## CITY OF OAKLAND

DEPARTMENT OF TRANSPORTATION 250 FRANK H. OGAWA PLAZA, SUITE 4314 OAKLAND, CA 94612 (510) 238-3437 FAX (510) 238-7227

LAKESHORE AVENUE SEPARATED BIKE LANES PROJECT FROM E 18TH STREET TO MACARTHUR BOULEVARD

No.	DATE	BY	REFERENCE

PLAN PRODUCTION WARNING

**LAYOUT** 


1007299

SCALE: AS SHOWN

SHEET NO. L-09 \_27 oF 83


#### GENERAL NOTES:

- ALL LOCATIONS WHERE R/W IS NOT IDENTIFIED OR DOES NOT COVER LIMITS OF IMPROVEMENTS, EXISTING BACK OF WALK SHALL BE ASSUMED AS RIGHT
- 2. CONTRACTOR SHALL SAWCUT TO A NEAT LINE WITHOUT DAMAGING EXISTING AC OR CONCRETE THAT IS TO REMAIN IN PLACE. ANY DAMAGE TO ADJACENT SURFACE MATERIAL TO REMAIN MUST BE REPAIRED OR REPLACED TO CONDITION SATISFACTORY TO THE ENGINEER AT THE CONTRACTOR'S EXPENSE
- 3. CONFORM SIDEWALK, CURB, AND GUTTER AT NEAREST SCOREMARK OR EXPANSION JOINT. EXACT LIMITS TO BE DETERMINED IN THE FIELD.
- 4. PROPOSED BACK OF WALK HORIZONTAL ALIGNMENT TO MATCH EXISTING, UNLESS OTHERWISE SHOWN ON THESE PLANS.
- 5. ALL EXISTING GRADES AT LIMITS OF WORK LABELED AS CONFORM SHALL BE VERIFIED PRIOR TO CONSTRUCTION AND ANY CONFLICT SHALL BE PROMPTLY BROUGHT TO THE ATTENTION OF THE ENGINEER.
- 6. GUTTER CROSS SLOPE AT BOTTOM OF RAMP OR BLENDED TRANSITIONS
- 7. ALL CROSSWALKS SLOPE SHOULD NOT EXCEED 5% MAX IN THE DIRECTION OF TRAVEL AND 2% MAX CROSS SLOPE.
- 8. CONTRACTOR TO VERIFY ALL DEPTHS AND LOCATIONS OF UTILITIES PRIOR TO CONSTRUCTION. ANY CONFLICTS DISCOVERED DURING CONSTRUCTION SHALL BE BROUGHT TO THE ENGINEER'S ATTENTION AND THE RESOLUTION SHALL BE APPROVED BY BOTH THE CITY AND ENGINEER PRIOR TO CONTINUING CONSTRUCITON ACTIVITIES.
- 9. SEE DRAINAGE AND UTILITY PLANS FOR UTILITIES THAT SHOULD BE ADJUSTED TO GRADE. EXISTING UTILITY BOXES AND COVERS SHALL BE ADJUSTED TO BE FLUSH WITH THE CURB RAMP, SIDEWALK, AND PAVEMENT SURFACE. ALL OTHER UTILITY PIPES, DUCTS, BOXES, VAULTS, AND STRUCTURE SHALL BE PROTECTED IN PLACE UNLESS OTHERWISE SHOWN.
- 10. ALL CONCRETE ISLAND CURB CORNERS TO BE ROUNDED USING 1' RADIUS, UNLESS OTHERWISE SHOWN ON THESE PLANS.
- 11. CONTRACTOR SHALL BE RESPONSIBLE FOR THE PROTECTION OF ANY BENCHMARK AND MONUMENTATION. IF A BENCHMARK OR MOUNIMENT IS DISTURBED. THE CONTRACTOR SHALL HAVE A LICENSED LAND SURVEYOR RESTORE THE BENCHEMARK OR MONUMENT AT THE CONTRACTOR'S EXPENSE.
- 12. PROPOSED CURB AND GUTTER SHALL BE DOWELED WITH #4 DOWEL TO EXISTING CURB AND GUTTER AT ALL CONFORM LOCATIONS
- 13. FOR PAVEMENT STRUCTURAL SECTIONS, SEE TYPICAL CROSS SECTIONS SHEETS AND PAVING PLANS.
- 14. FOR GRADING DETAILS AND LAYOUT INFORMATION NOT SHOWN, SEE CONSTRUCTION DETAIL SHEETS.
- 15. FOR SIGNING AND STRIPING IMPROVEMENTS, SEE SIGNAGE AND STRIPING
- 16. FOR TRAFFIC SIGNAL IMPROVEMENTS, SEE ELECTRICAL PLANS.

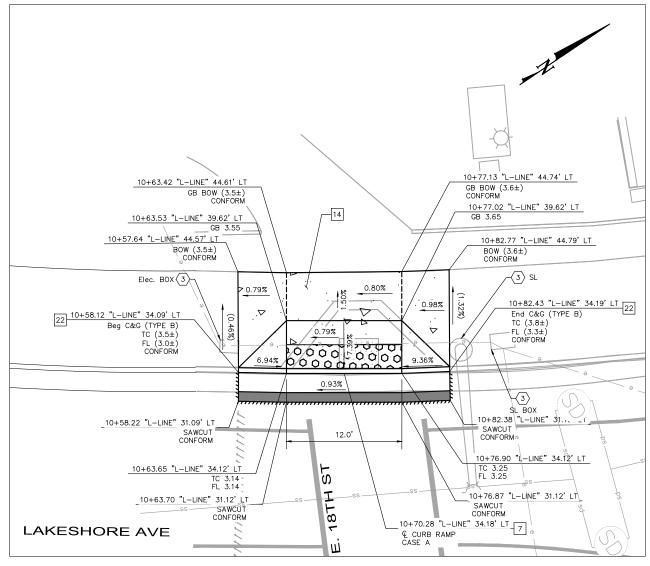


#### LAKESHORE AVE & E. 18TH ST **CURB RAMP DETAILS (NORTHWEST CORNER)**

SEE SHEET L-01 SCALE 1"=10'

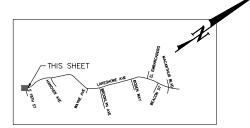


**KEY MAP** 

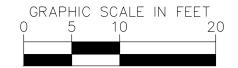

PLAN PRODUCTION WARNING THE PLANS HAVE BEEN CREATED ON ANSI B (11" X 17") SHEETS. REFER TO GRAPHIC SCALE FOR SHEETS OF

DIFFERENT SIZES.

CHECKED BY RYAN DOLE, P.E. **DESIGNED BY** JORGE MORALES

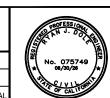

PROJECT NO.

SCALE: AS SHOWN

DATE: 12/11/2024

CD - 0128 oF 83

CITY OF OAKLAND

100% SUBMITTAL

DEPARTMENT OF TRANSPORTATION 250 FRANK H. OGAWA PLAZA, SUITE 4314 OAKLAND, CA 94612 (510) 238-3437 FAX (510) 238-7227

LAKESHORE AVENUE SEPARATED BIKE LANES PROJECT FROM E 18TH STREET TO MACARTHUR BOULEVARD

No.	DATE	BY	REFERENCE	
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**LEGEND** 

PROPOSED CONCRETE SIDEWALK, BUS BOARDING ISLAND, RAISED ISLAND, AND PEDESTRIAN REFUGE ISLAND DETECTABLE WARNING SURFACE

BASE REPAIR (21" HMA - TYPE A)

(SEE NOTE 7). FOR ADDITIONAL DETAILS, SEE AC BASE REPAIR DETAIL ON SHEET CD-19.

HMA PAVEMENT (12" DEPTH) PROPOSED LANDSCAPE AREA

RAISED ISLAND WITH DOWEL CURB

RAISED CROSSWALK 

HAM (TYPE A) OVERLAY (6" MAX) TRENCH GRATE (SEE DD-01)

GRADE BREAK

SAWCUT LIMITS (X.XX%)

X.XX%

#### **CONSTRUCTION NOTES**

PROPOSED SLOPE

- INSTALL CURB RAMP PER CITY OF OAKLAND STANDARD DWG S-3. CASE NOTED PER PLANS.
- INSTALL SIDEWALK PER CITY OF OAKLAND STD DWG S-1.
- INSTALL CURB AND GUTTER (C&G) PER CITY OF OAKLAND STD DWG S-1. C&G TYPE AS SPECIFIED ON PLANS.

#### UTILITY AND DEMOLITION NOTES

PROTECT IN PLACE.

**Kimley** » Horn

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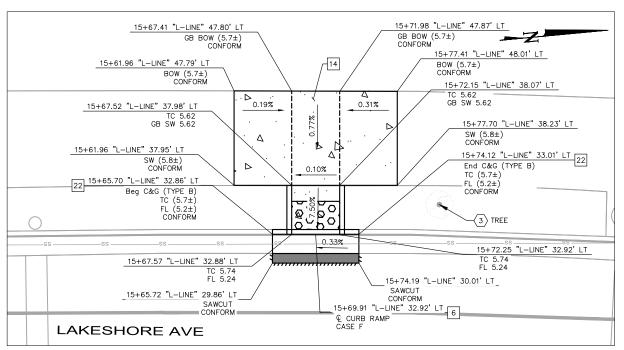
TESSA KEMPER/PRIYA PALLIVATHUCAL




CONSTRUCTION **DETAILS CURB RAMP** 

1007299

SHEET NO.



**DETAIL A** LAKESHORE AVE SEE SHEET L-02 SCALE 1"=10'

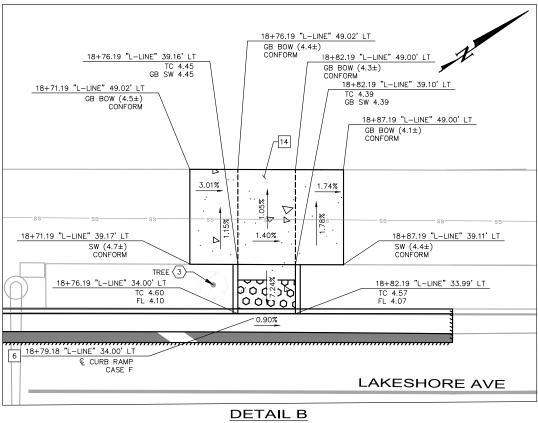

## LAKESHORE AVE & HANOVER AVE **CURB RAMP DETAILS (NORTHWEST CORNER)**

SEE SHEET L-02 SCALE 1"=10'

#### **LEGEND**

PROPOSED CONCRETE SIDEWALK, BUS BOARDING ISLAND, RAISED ISLAND, AND PEDESTRIAN REFUGE ISLAND

0000000

DETECTABLE WARNING SURFACE

BASE REPAIR (21" HMA - TYPE A) (SEE NOTE 7). FOR ADDITIONAL DETAILS, SEE AC BASE REPAIR DETAIL ON SHEET CD-19.



HMA PAVEMENT (12" DEPTH)

PROPOSED LANDSCAPE AREA

RAISED ISLAND WITH DOWEL CURB

RAISED CROSSWALK HAM (TYPE A) OVERLAY (6" MAX) TRENCH GRATE (SEE DD-01)

GRADE BREAK SAWCUT LIMITS

(X.XX%) X.XX%

Exist SLOPE PROPOSED SLOPE

#### FOR GENERAL NOTES SEE SHEET CD-01

#### CONSTRUCTION NOTES


INSTALL CURB RAMP PER CALTRANS 2023 STD PLAN A88A. CASE NOTED PER PLANS.

INSTALL SIDEWALK PER CITY OF OAKLAND STD DWG S-1.

INSTALL CURB AND GUTTER (C&G) PER CITY OF OAKLAND STD DWG S-1. C&G TYPE AS SPECIFIED ON PLANS.

## UTILITY AND DEMOLITION NOTES

PROTECT IN PLACE.

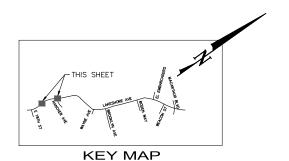

GRAPHIC SCALE IN FEET 10


DATE

PLAN PRODUCTION WARNING THE PLANS HAVE BEEN CREATED ON ANSI B (11" X 17") SHEETS. REFER TO GRAPHIC SCALE FOR SHEETS OF

DIFFERENT SIZES.

1300 Clay Street, Suite 900 Oakland, California 94612 Tel. No. (510)625-0712 © 2024 Fax No. (916)608-0885 CHECKED BY RYAN DOLE, P.E. **DESIGNED BY** JORGE MORALES

**Kimley** »Horn

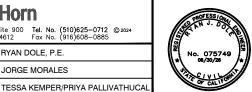

PROJECT NO.

100% SUBMITTAL

## CITY OF OAKLAND

DEPARTMENT OF TRANSPORTATION 250 FRANK H. OGAWA PLAZA, SUITE 4314 OAKLAND, CA 94612 (510) 238-3437 FAX (510) 238-7227

LAKESHORE AVENUE SEPARATED BIKE LANES PROJECT FROM E 18TH STREET TO MACARTHUR BOULEVARD


NO.	DATE	Dĭ	REFERENCE

CONSTRUCTION **DETAILS CURB RAMP** 

1007299

SCALE: AS SHOWN

SHEET NO. CD-02 29 <sub>OF</sub> 83 DATE: 12/11/2024

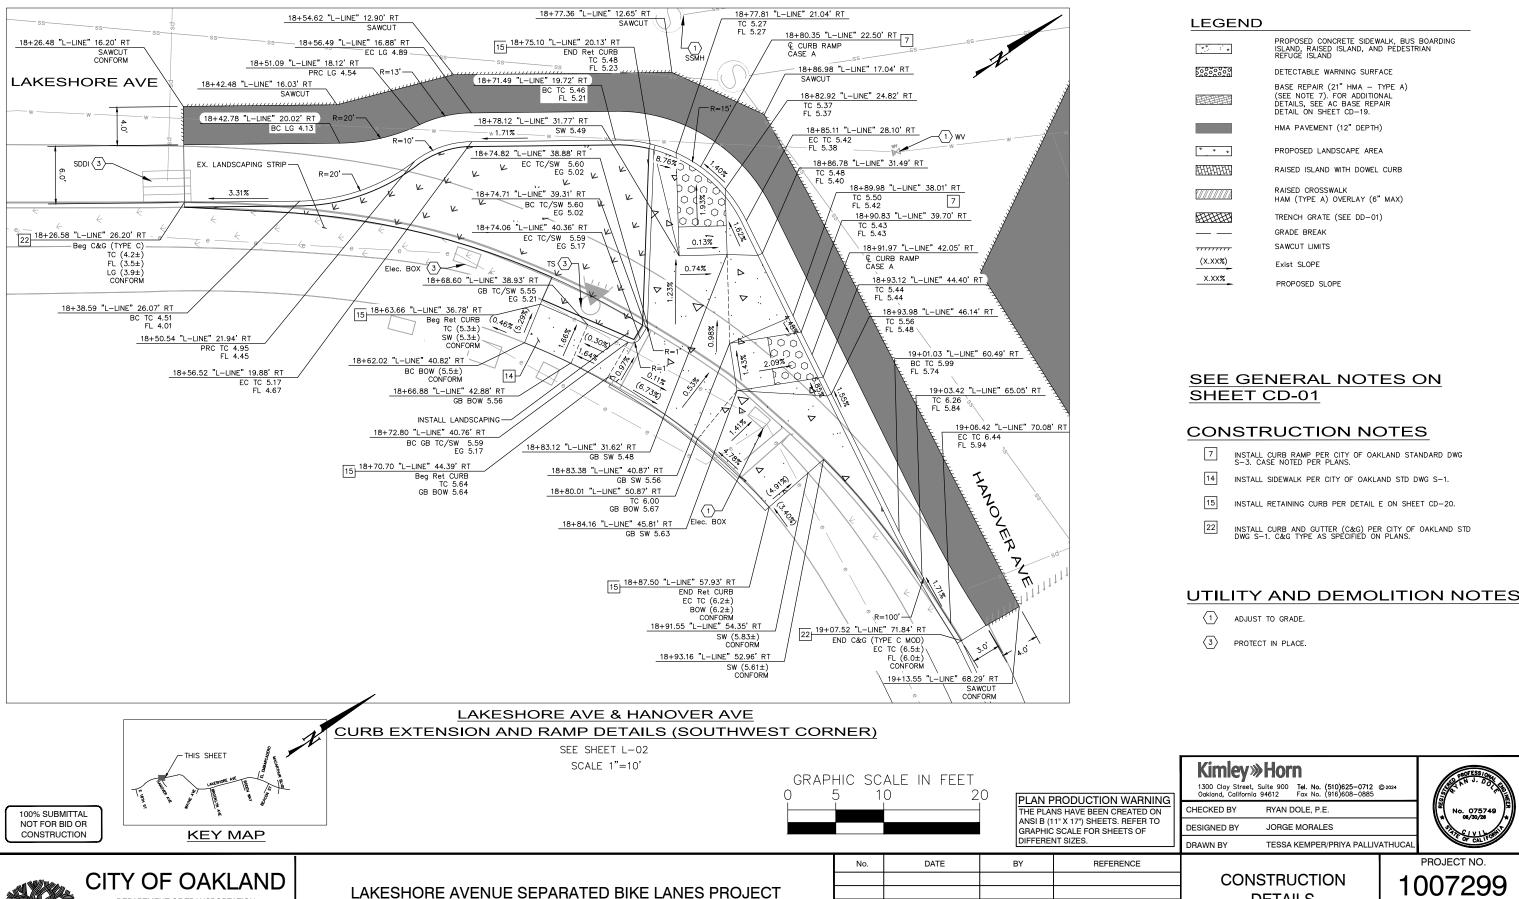

FROM E 18TH STREET TO MACARTHUR BOULEVARD

DEPARTMENT OF TRANSPORTATION

250 FRANK H. OGAWA PLAZA, SUITE 4314

OAKLAND, CA 94612 (510) 238-3437 FAX (510) 238-7227

No. 075749 06/30/26


**DETAILS CURB RAMP** 

PROJECT NO. 1007299

SCALE: AS SHOWN

SHEET NO. CD-03  $30_{\text{OF}}83$ 

DATE: 12/11/2024

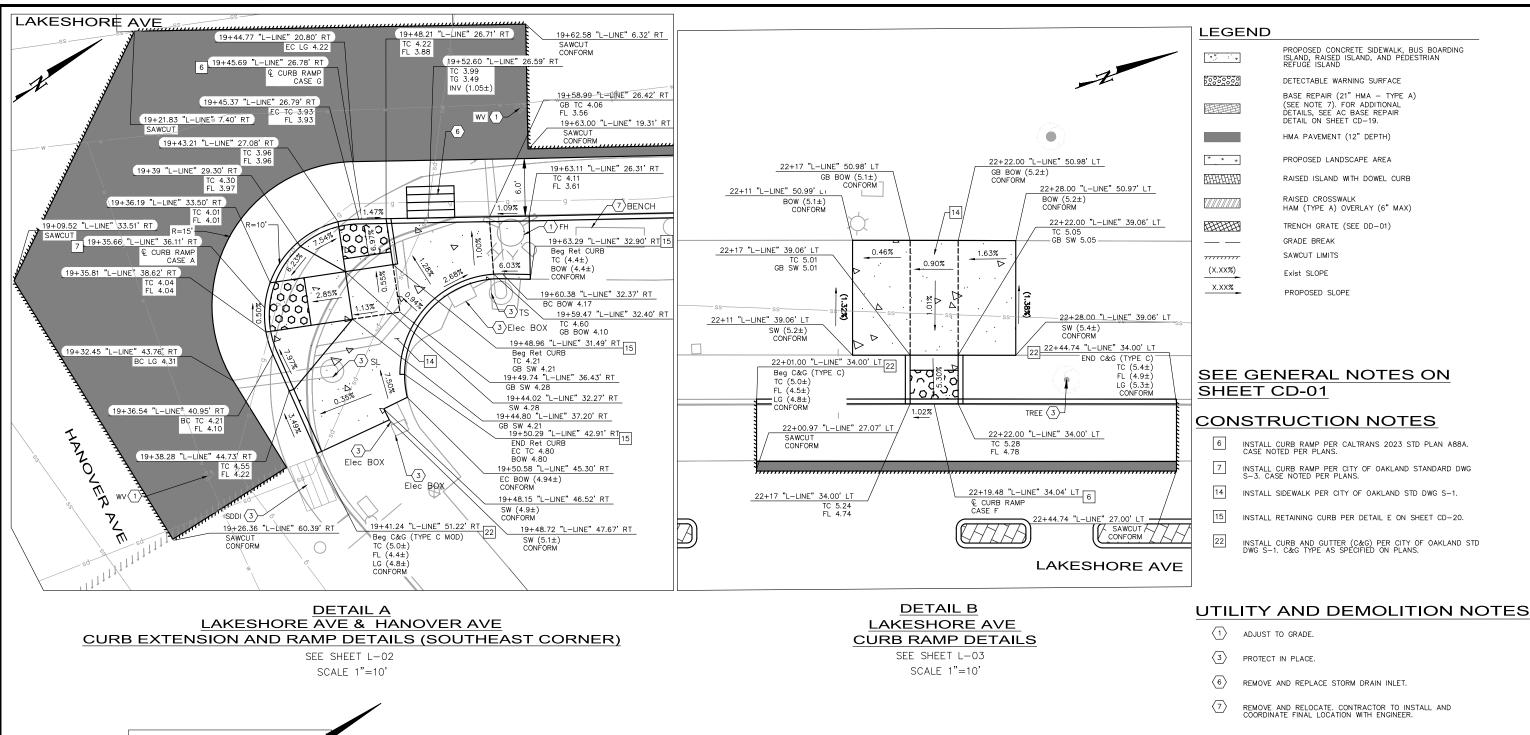

HIS SHEET

**KEY MAP** 

GRAPHIC SCALE IN FEET 10

PLAN PRODUCTION WARNING THE PLANS HAVE BEEN CREATED ON ANSI B (11" X 17") SHEETS. REFER TO

GRAPHIC SCALE FOR SHEETS OF DIFFERENT SIZES.

## **Kimley** » Horn

1300 Clay Street, Suite 900 Tel. No. (510)625-0712 © 2024 Oakland, California 94612 Fax No. (916)608-0885

CHECKED BY RYAN DOLE, P.E. **DESIGNED BY** 

JORGE MORALES DRAWN BY TESSA KEMPER/PRIYA PALLIVATHUCAL



100% SUBMITTAL

NOT FOR BID OR

CONSTRUCTION

## CITY OF OAKLAND

DEPARTMENT OF TRANSPORTATION 250 FRANK H. OGAWA PLAZA, SUITE 4314 OAKLAND, CA 94612 (510) 238-3437 FAX (510) 238-7227

LAKESHORE AVENUE SEPARATED BIKE LANES PROJECT FROM E 18TH STREET TO MACARTHUR BOULEVARD

No.	DATE	BY	REFERENCE

## CONSTRUCTION **DETAILS**

**CURB RAMP** 

PROJECT NO. 1007299

SCALE: AS SHOWN

SHEET NO. 31 <sub>OF</sub> 83 DATE: 12/11/2024

LAKESHORE AVE

**CURB RAMP DETAILS** 

SEE SHEET L-03 SCALE 1"=10'

27+87.46 "L-LINE" 49.11' LT 27+82.46 "L-LINE" 49.10' LT GB BOW (4.7±) GB BOW (4.7±) CONFORM CONFORM) 27+87.47 "L-LINE" 39.11' LT 27+82.47 "L-LINE" 39.10' LT TC 4.87 GB SW 4.87 GB SW 4.83 27+93.45 "L-LINE" 49.12' LT 27+76.46 "L-LINE" 49.08' LT BOW (4.6±) CONFORM 2.73% 1.63% 27+93.47 "L-LINE" 39.12' LT 27+76.47 "L-LINE" 39.08' LT SW (5.1±) CONFORM 0.65% 00 % 2.5.5 2.0.9 3 TREE 27+63.66 "L-LINE" 34.00' LT 22 27+87.47 "L-LINE" 34.00' LT 0.70% Beg C&G (TYPE C) TC (5.1±) FL 4.45 FL 4.45 27+84.98 "L-LINE" 33.99' LT 6 FL (4.6±) CONFORM € CURB RAMP 27+82.47 "L-LINE" 34.00' LT 27+63.66 "L-LINE" 27.00' LT LAKESHORE AVE

> **DETAIL B** LAKESHORE AVE **CURB RAMP DETAILS**

> > SEE SHEET L-04 SCALE 1"=10'

#### LEGEND

\* \* \*

PROPOSED CONCRETE SIDEWALK, BUS BOARDING ISLAND, RAISED ISLAND, AND PEDESTRIAN REFUGE ISLAND

5000000 DETECTABLE WARNING SURFACE

> BASE REPAIR (21" HMA - TYPE A) (SEE NOTE 7). FOR ADDITIONAL DETAILS, SEE AC BASE REPAIR DETAIL ON SHEET CD-19.

> > PROPOSED LANDSCAPE AREA

HMA PAVEMENT (12" DEPTH)

HHHHH RAISED ISLAND WITH DOWEL CURB

RAISED CROSSWALK HAM (TYPE A) OVERLAY (6" MAX)

TRENCH GRATE (SEE DD-01)

GRADE BREAK

SAWCUT LIMITS (X.XX%) Exist SLOPE X.XX% PROPOSED SLOPE


#### SEE GENERAL NOTES ON SHEET CD-01

#### **CONSTRUCTION NOTES**

- INSTALL RAISED ISLAND WITH DOWEL CURB PER DETAIL A ON SHEET CD—19. CONCRETE AND AGGREGATE BASE THICKNESS PER CITY OF OAKLAND SIDEWALK STD DWG S—1.
- INSTALL CURB RAMP PER CALTRANS 2023 STD PLAN A88A. CASE NOTED PER PLANS.
- INSTALL SIDEWALK PER CITY OF OAKLAND STD DWG S-1.
- INSTALL CURB AND GUTTER (C&G) PER CITY OF OAKLAND STD DWG S-1. C&G TYPE AS SPECIFIED ON PLANS.

#### **UTILITY AND DEMOLITION NOTES**

PROTECT IN PLACE.

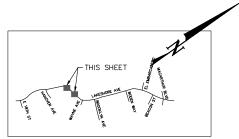

**KEY MAP** 



PLAN PRODUCTION WARNING THE PLANS HAVE BEEN CREATED ON ANSI B (11" X 17") SHEETS. REFER TO GRAPHIC SCALE FOR SHEETS OF DIFFERENT SIZES.

## **Kimley** »Horn

1300 Clay Street, Suite 900 Oakland, California 94612 Fax No. (916)608-0885

CHECKED BY RYAN DOLE, P.E. **DESIGNED BY** JORGE MORALES

DRAWN BY TESSA KEMPER/PRIYA PALLIVATHUCAL



1007299

SCALE: AS SHOWN

SHEET NO. 32 <sub>OF</sub> 83

PROJECT NO.

CITY OF OAKLAND DEPARTMENT OF TRANSPORTATION 250 FRANK H. OGAWA PLAZA, SUITE 4314 OAKLAND, CA 94612

(510) 238-3437 FAX (510) 238-7227

100% SUBMITTAL

NOT FOR BID OR

CONSTRUCTION

LAKESHORE AVENUE SEPARATED BIKE LANES PROJECT FROM E 18TH STREET TO MACARTHUR BOULEVARD

	No.	DATE	BY	REFERENCE
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L				
L				
L				

CONSTRUCTION **DETAILS CURB RAMP** 

DATE: 12/11/2024

#### **LEGEND**

PROPOSED CONCRETE SIDEWALK, BUS BOARDING ISLAND, RAISED ISLAND, AND PEDESTRIAN REFUGE ISLAND

0000000 DETECTABLE WARNING SURFACE

> BASE REPAIR (21" HMA - TYPE A) (SEE NOTE 7). FOR ADDITIONAL DETAILS, SEE AC BASE REPAIR

DETAIL ON SHEET CD-19. HMA PAVEMENT (12" DEPTH)

PROPOSED LANDSCAPE AREA

HEHEHE RAISED ISLAND WITH DOWEL CURB

RAISED CROSSWALK HAM (TYPE A) OVERLAY (6" MAX)

TRENCH GRATE (SEE DD-01)

GRADE BREAK SAWCUT LIMITS (X.XX%) Exist SLOPE

X.XX% PROPOSED SLOPE

#### SEE GENERAL NOTES ON SHEET CD-01

#### **CONSTRUCTION NOTES**

- INSTALL "CASE A" AND "BLENDED TRANSITION" CURB RAMP PER CITY OF OAKLAND STANDARD DWG S-3. CASE NOTED PER
- 14 INSTALL SIDEWALK PER CITY OF OAKLAND STD DWG S-1.
- INSTALL MODIFIED CURB AND GUTTER (TYPE C) PER CITY OF OAKLAND STD DWG S-1. CURB HEIGHT AS SHOWN ON PLANS.

#### UTILITY AND DEMOLITION NOTES

ADJUST TO GRADE.

PROTECT IN PLACE.


**Kimley** »Horn

1300 Clay Street, Suite 900 Oakland, California 94612 Fax No. (916)608-0885

**DETAILS** 

**CURB RAMP** 

SCALE 1"=10'

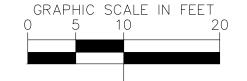

PLAN PRODUCTION WARNING THE PLANS HAVE BEEN CREATED ON ANSI B (11" X 17") SHEETS. REFER TO GRAPHIC SCALE FOR SHEETS OF

DIFFERENT SIZES.

CHECKED BY RYAN DOLE, P.E. **DESIGNED BY** JORGE MORALES DRAWN BY TESSA KEMPER/PRIYA PALLIVATHUCAL



PROJECT NO.

**CONSTRUCTION** 

1007299

SCALE: AS SHOWN

SHEET NO. CD-06 33 <sub>OF</sub> 83 DATE: 12/11/2024

CITY OF OAKLAND

100% SUBMITTAL

NOT FOR BID OR

CONSTRUCTION

DEPARTMENT OF TRANSPORTATION 250 FRANK H. OGAWA PLAZA, SUITE 4314 OAKLAND, CA 94612 (510) 238-3437 FAX (510) 238-7227


THIS SHEET

**KEY MAP** 

LAKESHORE AVENUE SEPARATED BIKE LANES PROJECT

No. DATE BY REFERENCE

FROM E 18TH STREET TO MACARTHUR BOULEVARD

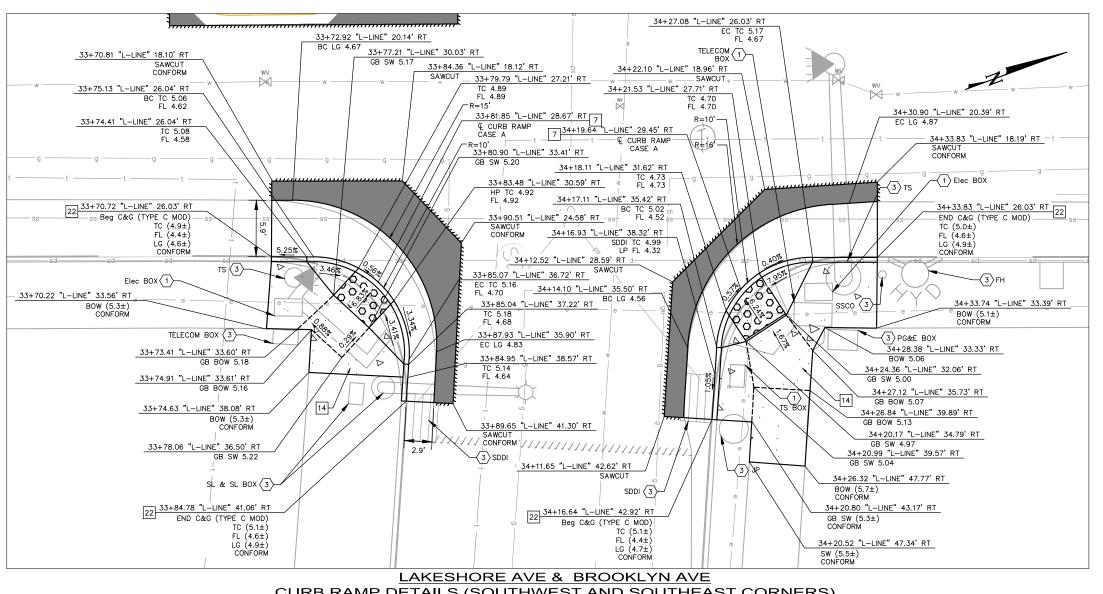

CURB RAMP DETAILS (SOUTHWEST AND SOUTHEAST CORNERS)

SEE SHEET L-05 SCALE 1"=10'

#### **LEGEND**

PROPOSED CONCRETE SIDEWALK, BUS BOARDING ISLAND, RAISED ISLAND, AND PEDESTRIAN REFUGE ISLAND

000000

DETECTABLE WARNING SURFACE BASE REPAIR (21" HMA - TYPE A)

PROPOSED LANDSCAPE AREA

(SEE NOTE 7). FOR ADDITIONAL DETAILS, SEE AC BASE REPAIR

DETAIL ON SHEET CD-19. HMA PAVEMENT (12" DEPTH)

RAISED ISLAND WITH DOWEL CURB

RAISED CROSSWALK 

HAM (TYPE A) OVERLAY (6" MAX) TRENCH GRATE (SEE DD-01)

GRADE BREAK SAWCUT LIMITS *,,,,,,,,,* 

(X.XX%) Exist SLOPE X.XX%

#### SEE GENERAL NOTES ON SHEET CD-01

PROPOSED SLOPE


#### CONSTRUCTION NOTES

- INSTALL CURB RAMP PER CITY OF OAKLAND STANDARD DWG S-3. CASE NOTED PER PLANS.
- INSTALL SIDEWALK PER CITY OF OAKLAND STD DWG S-1.
- INSTALL CURB AND GUTTER (C&G) PER CITY OF OAKLAND STD DWG S-1. C&G TYPE AS SPECIFIED ON PLANS.

#### **UTILITY AND DEMOLITION NOTES**

ADJUST TO GRADE.

PROTECT IN PLACE.

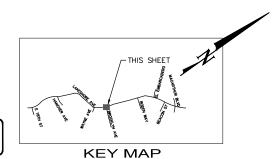

GRAPHIC SCALE IN FEET 10

DATE

PLAN PRODUCTION WARNING THE PLANS HAVE BEEN CREATED ON ANSI B (11" X 17") SHEETS. REFER TO GRAPHIC SCALE FOR SHEETS OF DIFFERENT SIZES.

DEEEDENCE

**Kimley** » Horn 1300 Clay Street, Suite 900 Tel. No. (510)625-0712 © 2024 Oakland, California 94612 Fax No. (916)608-0885

CHECKED BY RYAN DOLE, P.E.

DESIGNED BY JORGE MORALES DRAWN BY TESSA KEMPER/PRIYA PALLIVATHUCAL



100% SUBMITTAL

NOT FOR BID OR

## CITY OF OAKLAND

DEPARTMENT OF TRANSPORTATION 250 FRANK H. OGAWA PLAZA, SUITE 4314 OAKLAND, CA 94612 (510) 238-3437 FAX (510) 238-7227

LAKESHORE AVENUE SEPARATED BIKE LANES PROJECT FROM E 18TH STREET TO MACARTHUR BOULEVARD

NO.	DATE	DI	NEFERENCE

CONSTRUCTION **DETAILS CURB RAMP** 

PROJECT NO. 1007299

SCALE: AS SHOWN

CD - 0734 <sub>OF</sub> 83 DATE: 12/11/2024

SHEET NO.

#### **DETAIL A: LAKESHORE AVE CURB RAMP DETAILS**

SEE SHEET L-05 SCALE 1"=10'

#### **LEGEND**

PROPOSED CONCRETE SIDEWALK, BUS BOARDING ISLAND, RAISED ISLAND, AND PEDESTRIAN REFUGE ISLAND

000000

DETECTABLE WARNING SURFACE

BASE REPAIR (21" HMA - TYPE A) (SEE NOTE 7). FOR ADDITIONAL DETAILS, SEE AC BASE REPAIR DETAIL ON SHEET CD-19.

HMA PAVEMENT (12" DEPTH)

PROPOSED LANDSCAPE AREA

RAISED ISLAND WITH DOWEL CURB

RAISED CROSSWALK HAM (TYPE A) OVERLAY (6" MAX)

PROPOSED SLOPE

TRENCH GRATE (SEE DD-01) GRADE BREAK

SAWCUT LIMITS

(X.XX%) Exist SLOPE

X.XX%

SEE GENERAL NOTES ON SHEET CD-01

#### **CONSTRUCTION NOTES**

- INSTALL RAISED ISLAND WITH DOWEL CURB PER DETAIL A ON SHEET CD-19. CONCRETE AND AGGREGATE BASE THICKNESS PER CITY OF OAKLAND SIDEWALK STD DWG S-1.
- INSTALL CURB RAMP PER CALTRANS 2023 STD PLAN A88A. CASE NOTED PER PLANS.
- INSTALL SIDEWALK PER CITY OF OAKLAND STD DWG S-1.
- INSTALL CURB AND GUTTER (C&G) PER CITY OF OAKLAND STD DWG S-1. C&G TYPE AS SPECIFIED ON PLANS.

**UTILITY AND DEMOLITION NOTES** 

THIS SHEET

**KEY MAP** 



PLAN PRODUCTION WARNING THE PLANS HAVE BEEN CREATED ON ANSI B (11" X 17") SHEETS. REFER TO GRAPHIC SCALE FOR SHEETS OF

DIFFERENT SIZES.

CHECKED BY **DESIGNED BY** 

> CONSTRUCTION **DETAILS**

> > **CURB RAMP**

**Kimley** » Horn

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RYAN DOLE, P.E.

JORGE MORALES

TESSA KEMPER/PRIYA PALLIVATHUCAL PROJECT NO.

1007299

SCALE: AS SHOWN

SHEET NO. CD-08 35 OF 83


CITY OF OAKLAND DEPARTMENT OF TRANSPORTATION 250 FRANK H. OGAWA PLAZA, SUITE 4314 OAKLAND, CA 94612 (510) 238-3437 FAX (510) 238-7227


100% SUBMITTAL

LAKESHORE AVENUE SEPARATED BIKE LANES PROJECT FROM E 18TH STREET TO MACARTHUR BOULEVARD

No. DATE BY REFERENCE No. 075749 08/30/28

DATE: 12/11/2024

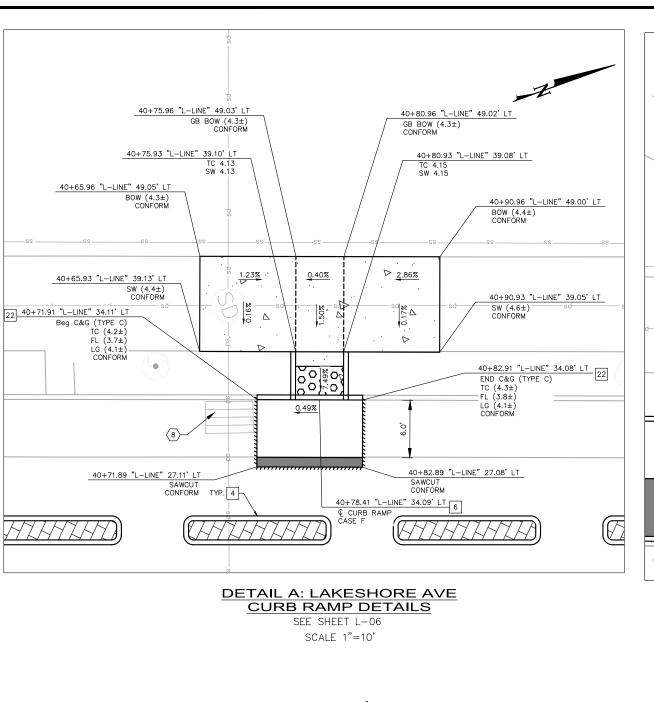

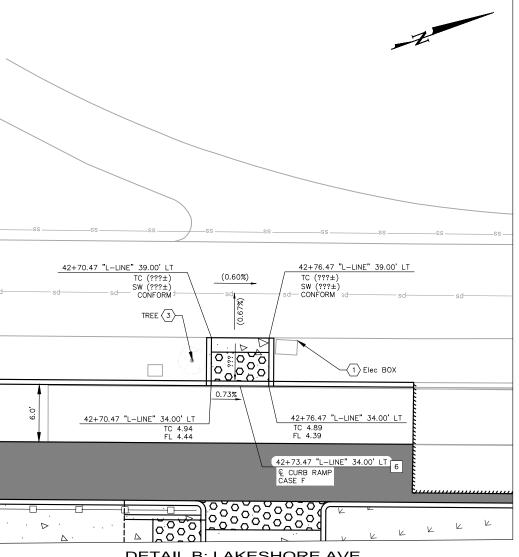

**DETAIL B: LAKESHORE AVE CURB RAMP DETAILS** 

> SEE SHEET L-06 SCALE 1"=10'

#### **LEGEND**

PROPOSED CONCRETE SIDEWALK, BUS BOARDING ISLAND, RAISED ISLAND, AND PEDESTRIAN REFUGE ISLAND

5000000 DETECTABLE WARNING SURFACE

> BASE REPAIR (21" HMA - TYPE A) (SEE NOTE 7). FOR ADDITIONAL DETAILS, SEE AC BASE REPAIR

DETAIL ON SHEET CD-19. HMA PAVEMENT (12" DEPTH)

PROPOSED LANDSCAPE AREA

HHHH RAISED ISLAND WITH DOWEL CURB

HAM (TYPE A) OVERLAY (6" MAX)

TRENCH GRATE (SEE DD-01)

GRADE BREAK SAWCUT LIMITS

(X.XX%) Exist SLOPE

X.XX% PROPOSED SLOPE


#### SEE GENERAL NOTES ON SHEET CD-01

#### **CONSTRUCTION NOTES**

- INSTALL RAISED ISLAND WITH DOWEL CURB PER DETAIL A ON SHEET CD-19. CONCRETE AND AGGREGATE BASE THICKNESS PER CITY OF OAKLAND SIDEWALK STD DWG S-1.
- INSTALL CURB RAMP PER CALTRANS 2023 STD PLAN A88A. CASE NOTED PER PLANS.
- INSTALL CURB AND GUTTER (C&G) PER CITY OF OAKLAND STD DWG S-1. C&G TYPE AS SPECIFIED ON PLANS.

#### **UTILITY AND DEMOLITION NOTES**

- 1 ADJUST TO GRADE.
- PROTECT IN PLACE.
- REPLACE DRAINAGE INLET GRATE WITH HEEL PROOF AND ADA COMPLIANT GRATE.

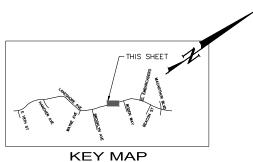

GRAPHIC SCALE IN FEET 10

PLAN PRODUCTION WARNING THE PLANS HAVE BEEN CREATED ON ANSI B (11" X 17") SHEETS. REFER TO GRAPHIC SCALE FOR SHEETS OF

DIFFERENT SIZES.

CHECKED BY RYAN DOLE, P.E. **DESIGNED BY** JORGE MORALES

**Kimley** » Horn

DRAWN BY TESSA KEMPER/PRIYA PALLIVATHUCAL

CONSTRUCTION

**DETAILS** 

**CURB RAMP** 

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PROJECT NO. 1007299

SCALE: AS SHOWN

SHEET NO. CD - 0936 OF 83 DATE: 12/11/2024

CITY OF OAKLAND


100% SUBMITTAL

CONSTRUCTION

DEPARTMENT OF TRANSPORTATION FROM E 18TH STREET TO MACARTHUR BOULEVARD 250 FRANK H. OGAWA PLAZA, SUITE 4314 OAKLAND, CA 94612 (510) 238-3437 FAX (510) 238-7227

No. DATE BY REFERENCE

LAKESHORE AVENUE SEPARATED BIKE LANES PROJECT

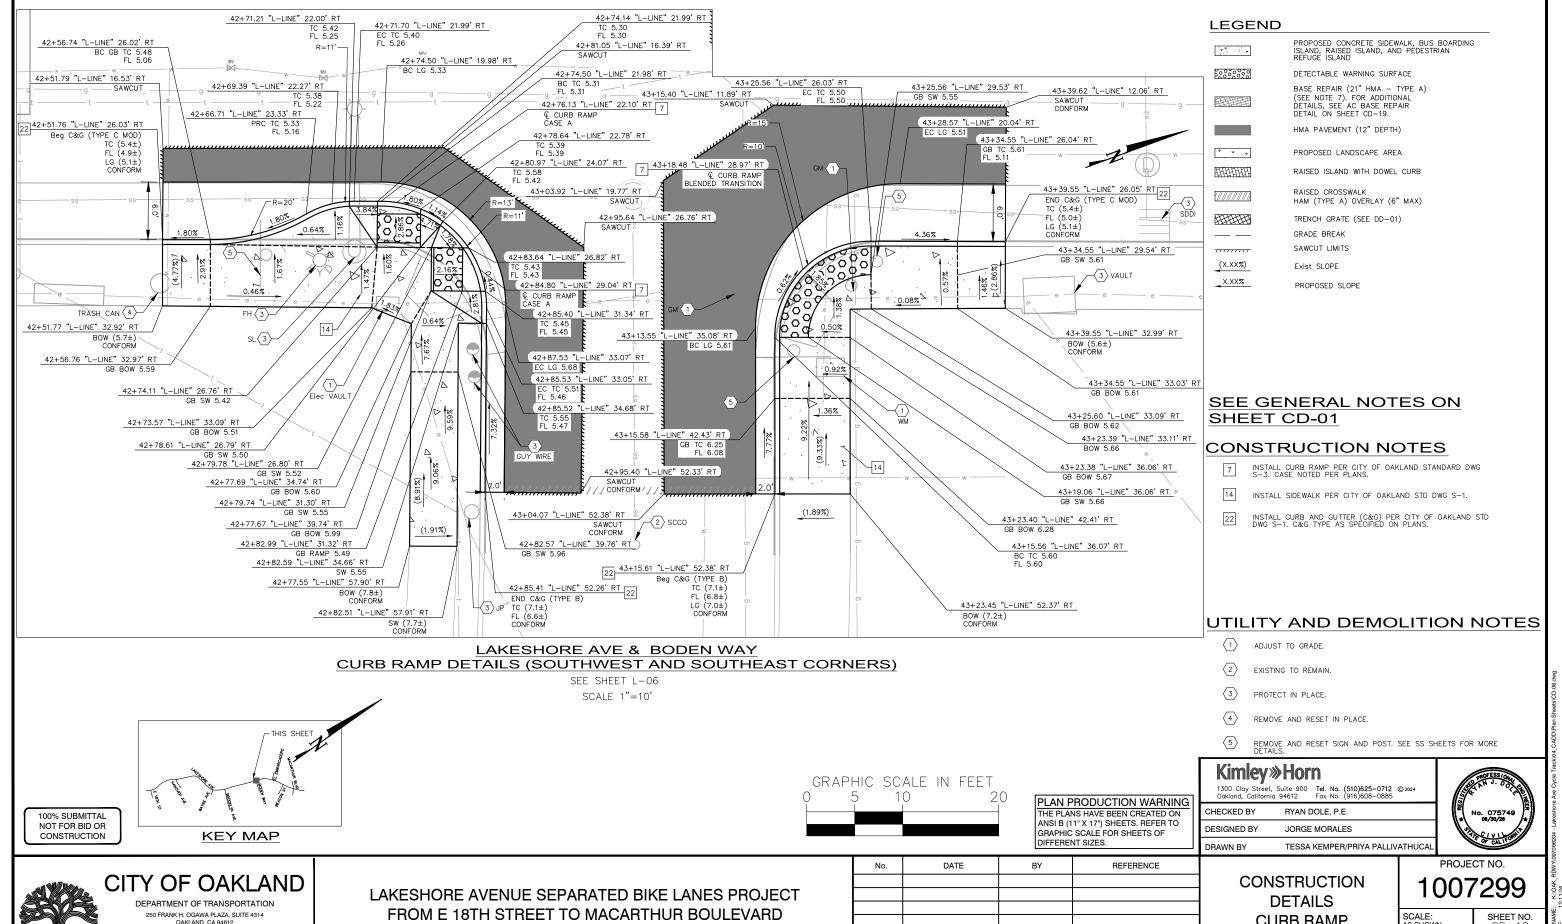


OAKLAND, CA 94612 (510) 238-3437 FAX (510) 238-7227

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**CURB RAMP** 

SCALE: AS SHOWN

CD-10 37 <sub>OF</sub> 83 DATE: 12/11/2024

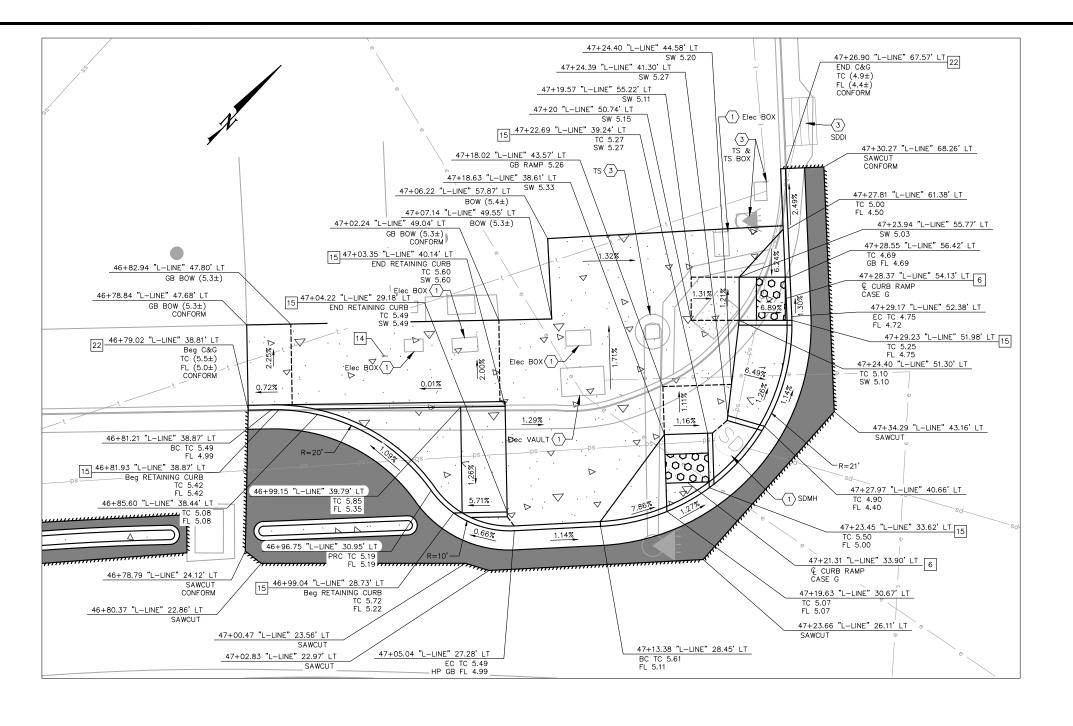

#### **LEGEND**

X.XX%

PROPOSED CONCRETE SIDEWALK, BUS BOARDING ISLAND, RAISED ISLAND, AND PEDESTRIAN REFUGE ISLAND 0000000 DETECTABLE WARNING SURFACE BASE REPAIR (21" HMA - TYPE A) (SEE NOTE 7). FOR ADDITIONAL DETAILS, SEE AC BASE REPAIR DETAIL ON SHEET CD-19. HMA PAVEMENT (12" DEPTH) PROPOSED LANDSCAPE AREA RAISED ISLAND WITH DOWEL CURB RAISED CROSSWALK HAM (TYPE A) OVERLAY (6" MAX) CHANNEL DRAIN (SEE DD-01) GRADE BREAK SAWCUT LIMITS (X.XX%) Exist SLOPE

# SEE GENERAL NOTES ON SHEET CD-01

PROPOSED SLOPE

#### **CONSTRUCTION NOTES**

- INSTALL CURB RAMP PER CALTRANS 2023 STD PLAN A88A. CASE NOTED PER PLANS.
- INSTALL SIDEWALK PER CITY OF OAKLAND STD DWG S-1.
- INSTALL RETAINING CURB PER DETAIL E ON SHEET CD-20.
- INSTALL CURB AND GUTTER (TYPE B) PER CITY OF OAKLAND STD DWG S-1.

#### **UTILITY AND DEMOLITION NOTES**


- ADJUST TO GRADE.
- PROTECT IN PLACE.

**KEY MAP** 

(510) 238-3437 FAX (510) 238-7227

### LAKESHORE AVE & EL EMBARCADERO **CURB RAMP DETAILS (NORTHWEST CORNER)**

SEE SHEET L-08 SCALE 1"=10'

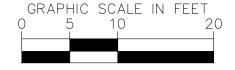

DATE

No.

PLAN PRODUCTION WARNING THE PLANS HAVE BEEN CREATED ON ANSI B (11" X 17") SHEETS. REFER TO GRAPHIC SCALE FOR SHEETS OF

DIFFERENT SIZES.

REFERENCE

# **Kimley** » Horn

1300 Clay Street, Suite 900 Oakland, California 94612 Fax No. (916)608-0885

**CONSTRUCTION** 

**DETAILS** 

**CURB RAMP** 

TESSA KEMPER/PRIYA PALLIVATHUCAL

CHECKED BY RYAN DOLE, P.E.

DRAWN BY

**DESIGNED BY** JORGE MORALES



PROJECT NO.

1007299

SCALE: AS SHOWN

DATE: 12/11/2024

SHEET NO. CD-1138 <sub>OF</sub> 83



100% SUBMITTAL


NOT FOR BID OR

CONSTRUCTION

LAKESHORE AVENUE SEPARATED BIKE LANES PROJECT FROM E 18TH STREET TO MACARTHUR BOULEVARD

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BY

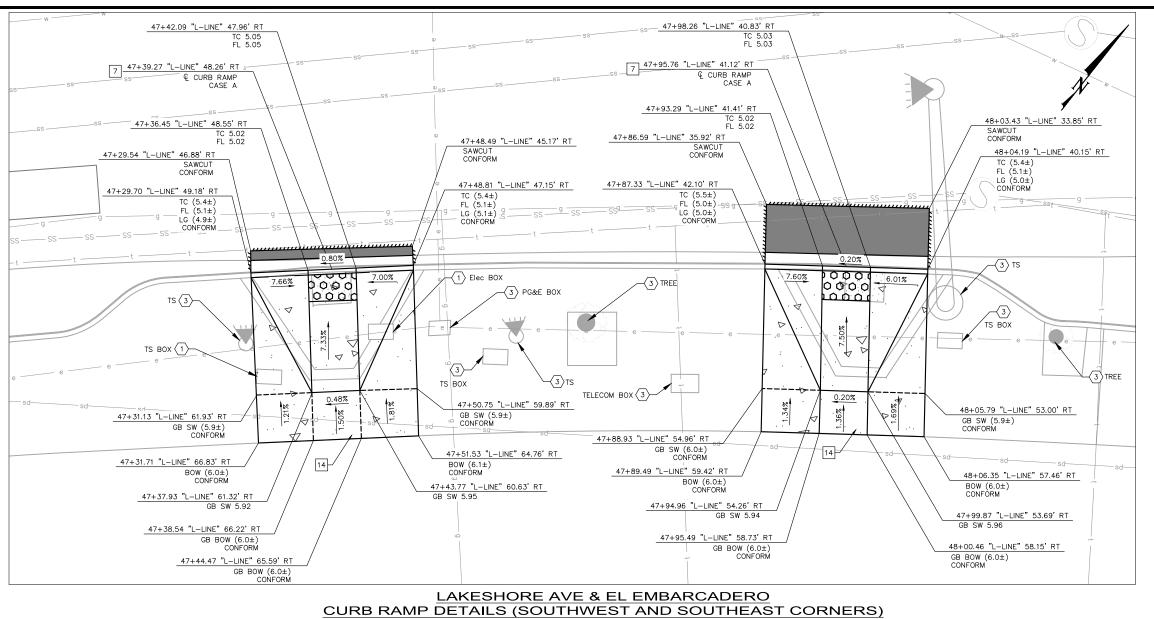

SEE SHEET L-08 SCALE 1"=10"

# LEGEND

HHHHH

PROPOSED CONCRETE SIDEWALK, BUS BOARDING ISLAND, RAISED ISLAND, AND PEDESTRIAN REFUGE ISLAND

500000 DETECTABLE WARNING SURFACE

> BASE REPAIR (21" HMA - TYPE A) (SEE NOTE 7). FOR ADDITIONAL DETAILS, SEE AC BASE REPAIR DETAIL ON SHEET CD—19.

HMA PAVEMENT (12" DEPTH)

RAISED ISLAND WITH DOWEL CURB

PROPOSED LANDSCAPE AREA

RAISED CROSSWALK HAM (TYPE A) OVERLAY (6" MAX)

CHANNEL DRAIN (SEE DD-01)

GRADE BREAK SAWCUT LIMITS 777777777

(X.XX%) Exist SLOPE \_X.XX% PROPOSED SLOPE

### SEE GENERAL NOTES ON SHEET CD-01

# **CONSTRUCTION NOTES**

- INSTALL CURB RAMP PER CITY OF OAKLAND STANDARD DWG S-3. CASE NOTED PER PLANS.
- INSTALL SIDEWALK PER CITY OF OAKLAND STD DWG S-1.

#### UTILITY AND DEMOLITION NOTES

TESSA KEMPER/PRIYA PALLIVATHUCAL

**CONSTRUCTION** 

**DETAILS** 

**CURB RAMP** 

- ADJUST TO GRADE.
- PROTECT IN PLACE.

**KEY MAP** 

GRAPHIC SCALE IN FEET

DATE

PLAN PRODUCTION WARNING THE PLANS HAVE BEEN CREATED ON ANSI B (11" X 17") SHEETS. REFER TO GRAPHIC SCALE FOR SHEETS OF

1300 Clay Street, Suite 900 Oakland, California 94612 Fax No. (916)608-0885 CHECKED BY RYAN DOLE, P.E. **DESIGNED BY** JORGE MORALES

DRAWN BY

**Kimley** »Horn



PROJECT NO.

1007299

SCALE: AS SHOWN

SHEET NO. CD-12 39 <sub>OF</sub> 83 DATE: 12/11/2024

CITY OF OAKLAND DEPARTMENT OF TRANSPORTATION

250 FRANK H. OGAWA PLAZA, SUITE 4314 OAKLAND, CA 94612

(510) 238-3437 FAX (510) 238-7227

100% SUBMITTAL

NOT FOR BID OR


CONSTRUCTION

FROM E 18TH STREET TO MACARTHUR BOULEVARD

NO.	DATE	BY	REFERENCE

DIFFERENT SIZES.

LAKESHORE AVENUE SEPARATED BIKE LANES PROJECT

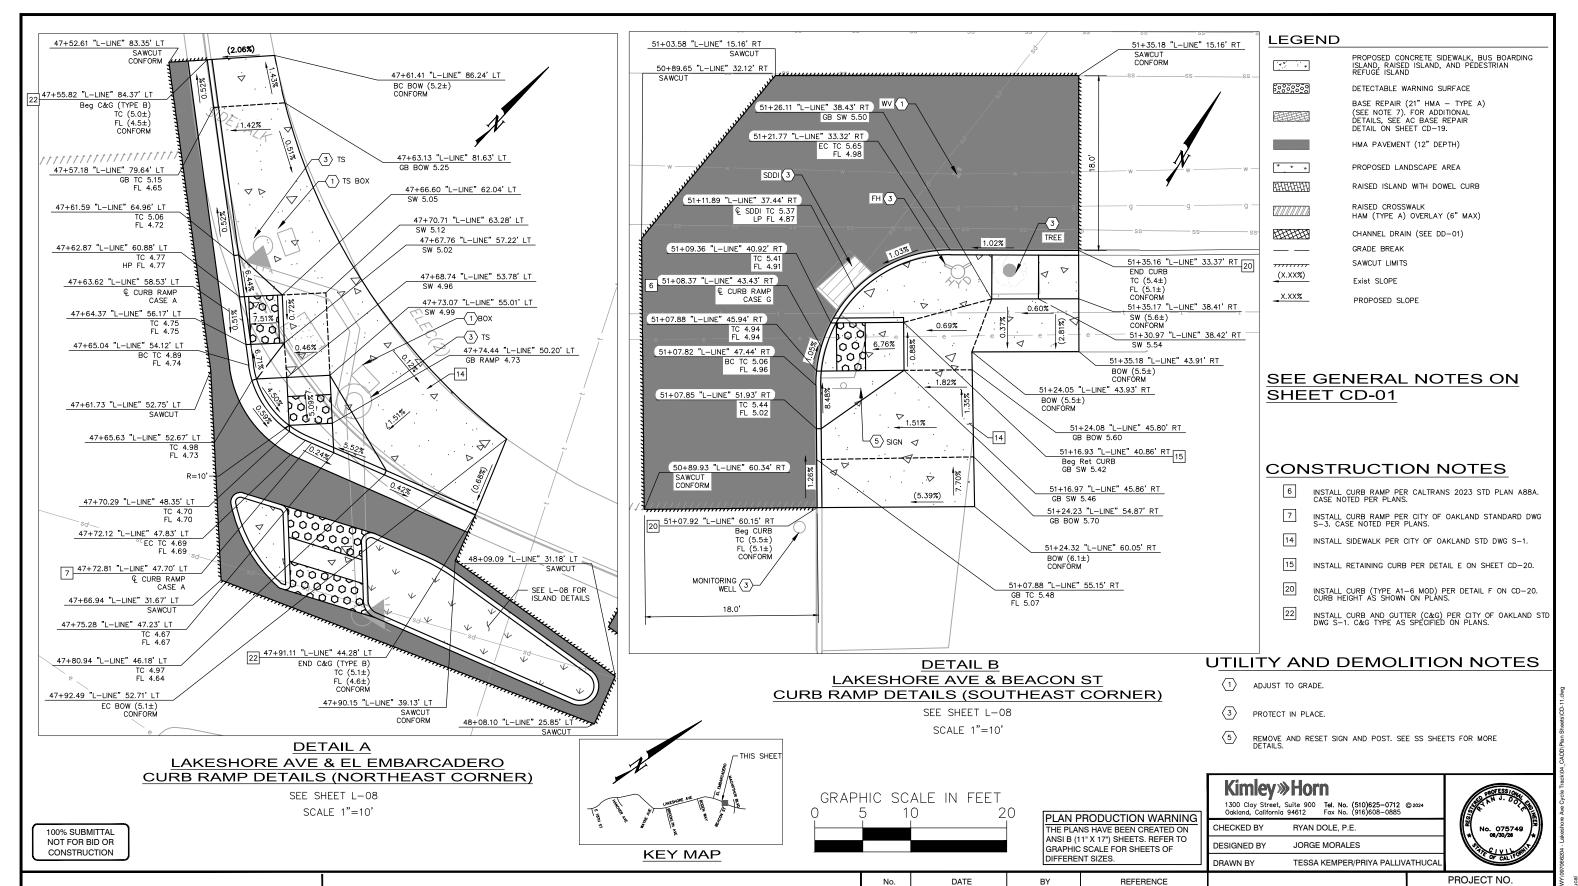

CITY OF OAKLAND DEPARTMENT OF TRANSPORTATION 250 FRANK H. OGAWA PLAZA, SUITE 4314

OAKLAND, CA 94612 (510) 238-3437 FAX (510) 238-7227

LAKESHORE AVENUE SEPARATED BIKE LANES PROJECT FROM E 18TH STREET TO MACARTHUR BOULEVARD

NO.	DATE	В	REFERENCE

DATE

**CONSTRUCTION DETAILS** 

**CURB RAMP** 


1007299

SCALE: AS SHOWN

DATE: 12/11/2024

 $\underline{40}_{\text{OF}}\underline{83}$ 

SHEET NO. CD-13

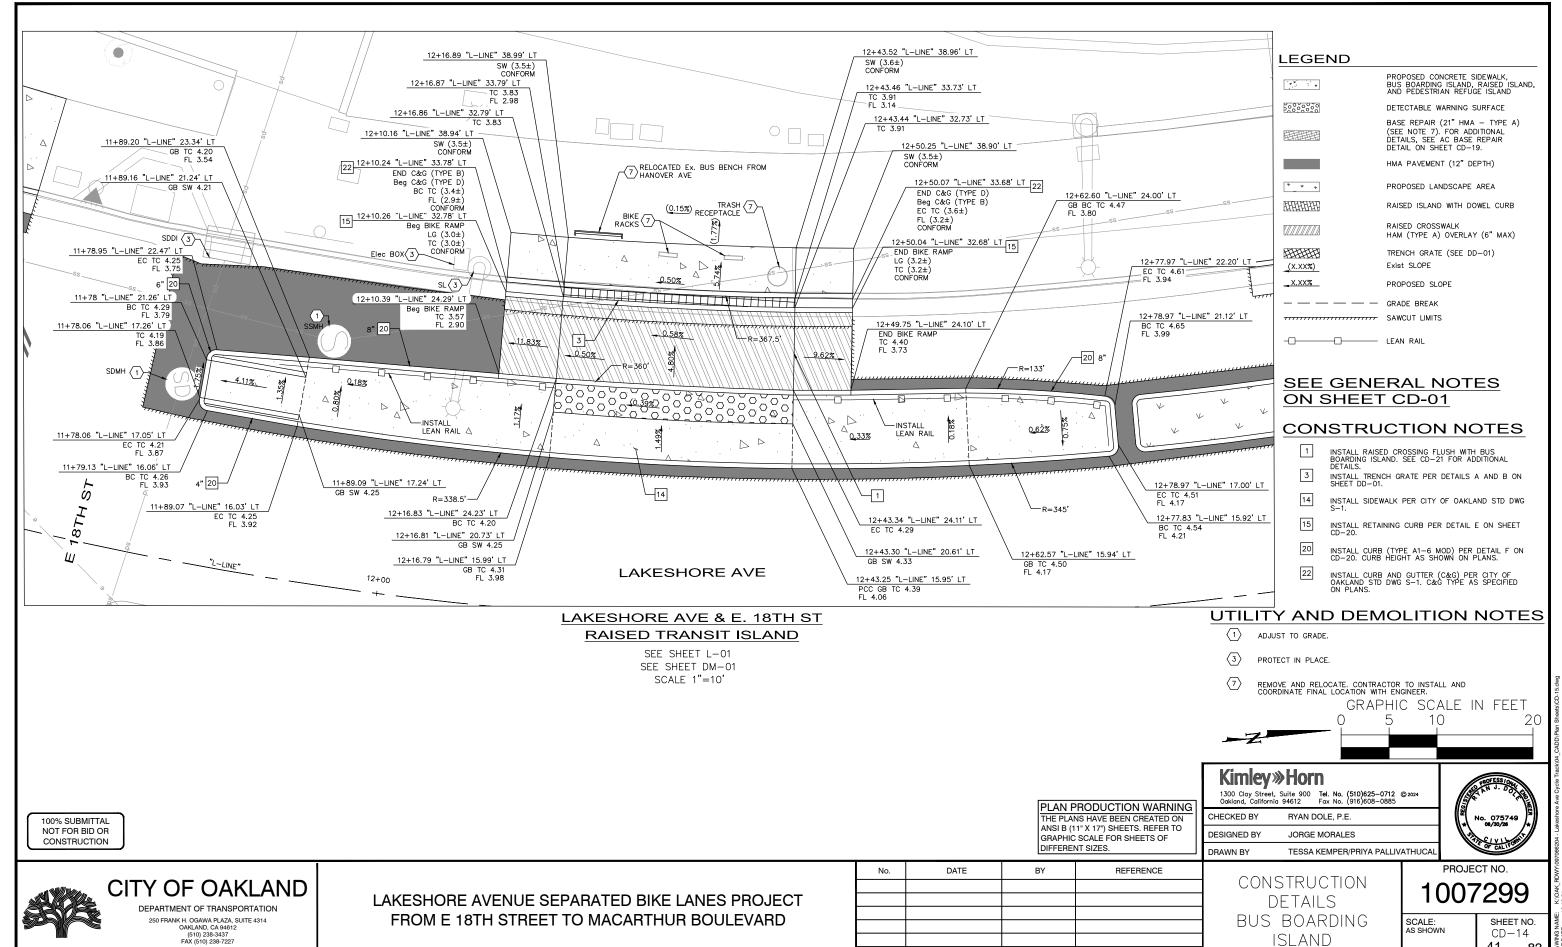


CD-14

41 oF 83

AS SHOWN

ISLAND

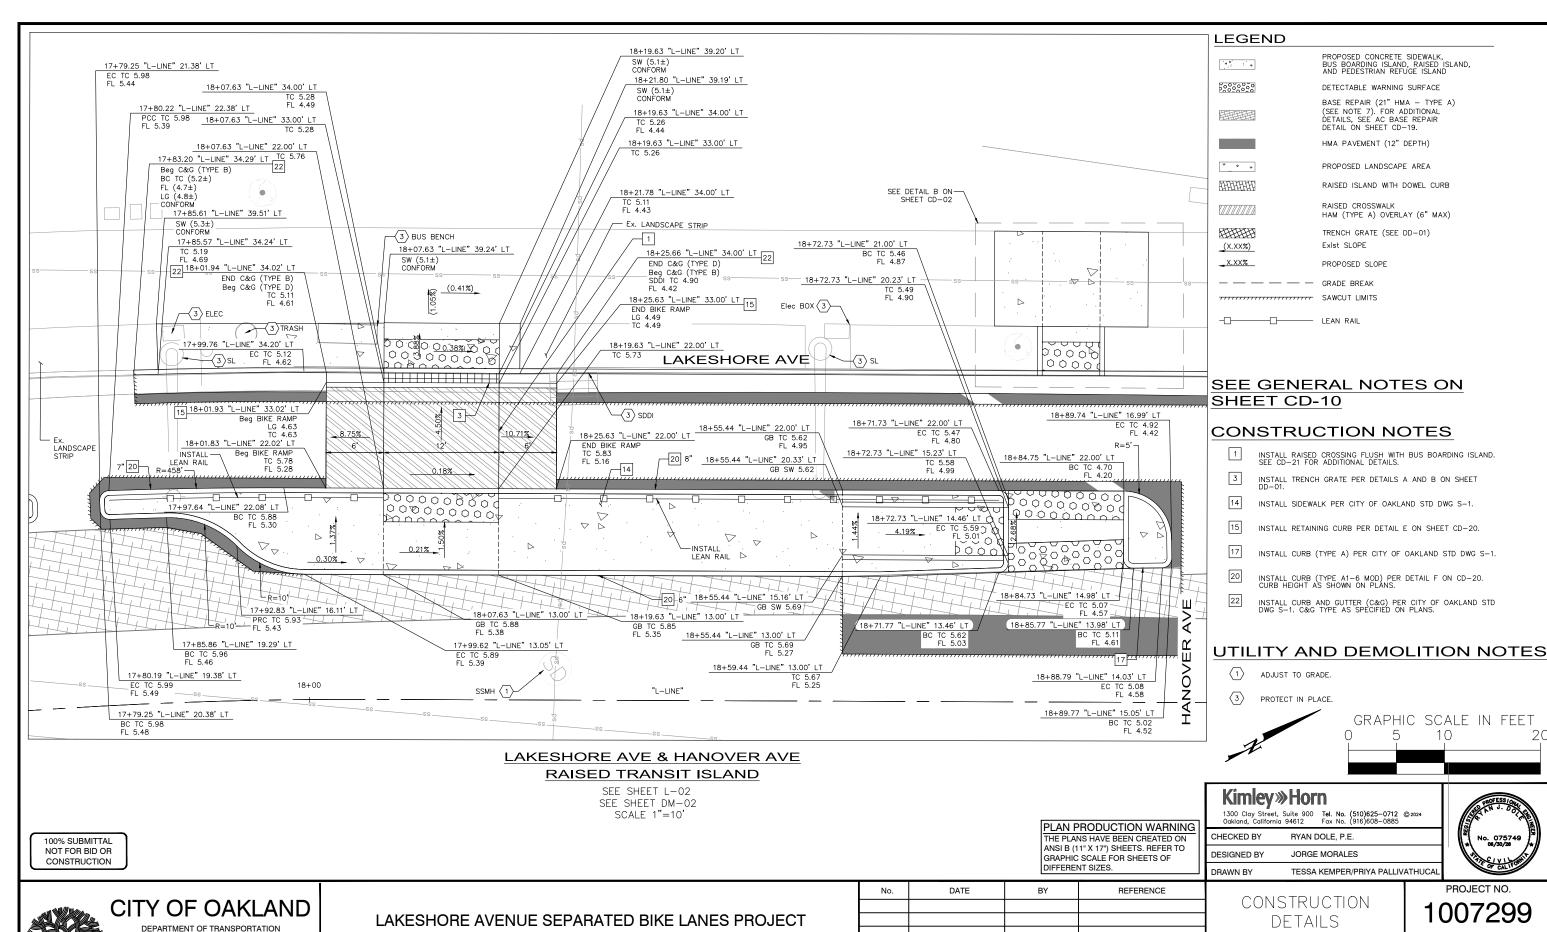

FROM E 18TH STREET TO MACARTHUR BOULEVARD

250 FRANK H. OGAWA PLAZA, SLITE 4314


OAKLAND, CA 94612 (510) 238-3437 FAX (510) 238-7227

SCALE: AS SHOWN

BUS BOARDING

ISLAND

SHEET NO. CD-15 42 of 83

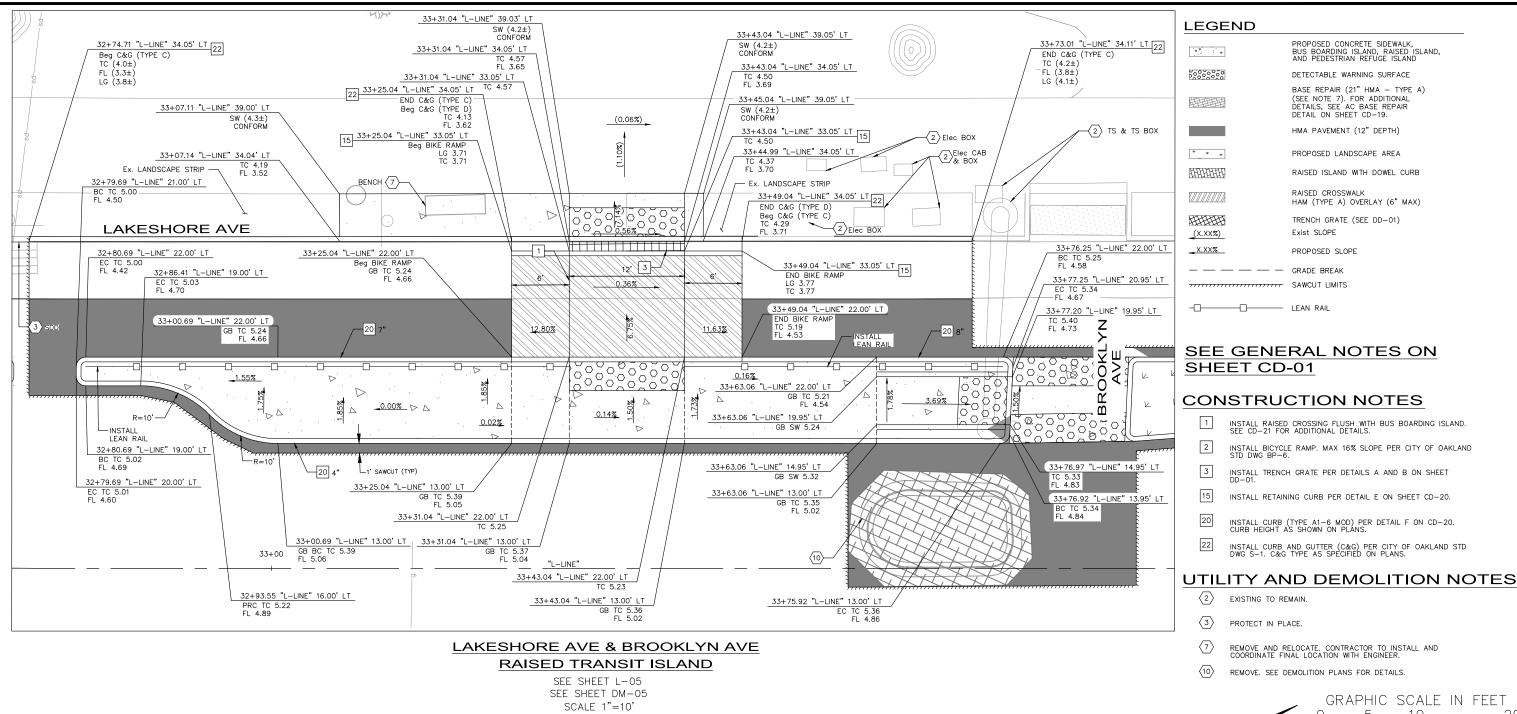

# $\langle 10 \rangle$

REMOVE. SEE DEMOLITION PLANS FOR DETAILS. GRAPHIC SCALE IN FEET 5 10

**Kimley** »Horn

EXISTING TO REMAIN.

PROTECT IN PLACE.

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CHECKED BY DESIGNED BY

DRAWN BY

RYAN DOLE, P.E. JORGE MORALES TESSA KEMPER/PRIYA PALLIVATHUCAL

PROPOSED CONCRETE SIDEWALK, BUS BOARDING ISLAND, RAISED ISLAND, AND PEDESTRIAN REFUGE ISLAND

DETECTABLE WARNING SURFACE

DETAIL ON SHEET CD-19.

HMA PAVEMENT (12" DEPTH)

PROPOSED LANDSCAPE AREA

TRENCH GRATE (SEE DD-01)

INSTALL RAISED CROSSING FLUSH WITH BUS BOARDING ISLAND. SEE CD-21 FOR ADDITIONAL DETAILS.

INSTALL TRENCH GRATE PER DETAILS A AND B ON SHEET DD-01.

INSTALL RETAINING CURB PER DETAIL E ON SHEET CD-20.

INSTALL CURB (TYPE A1—6 MOD) PER DETAIL F ON CD—20. CURB HEIGHT AS SHOWN ON PLANS.

REMOVE AND RELOCATE. CONTRACTOR TO INSTALL AND COORDINATE FINAL LOCATION WITH ENGINEER.

INSTALL CURB AND GUTTER (C&G) PER CITY OF OAKLAND STD DWG S-1. C&G TYPE AS SPECIFIED ON PLANS.

INSTALL BICYCLE RAMP. MAX 16% SLOPE PER CITY OF OAKLAND STD DWG BP-6.

RAISED CROSSWALK

Exist SLOPE

LEAN RAIL

PROPOSED SLOPE

RAISED ISLAND WITH DOWEL CURB

HAM (TYPE A) OVERLAY (6" MAX)

BASE REPAIR (21" HMA - TYPE A) (SEE NOTE 7). FOR ADDITIONAL DETAILS, SEE AC BASE REPAIR



PROJECT NO.

100% SUBMITTAL

NOT FOR BID OR

CONSTRUCTION

CITY OF OAKLAND

DEPARTMENT OF TRANSPORTATION 250 FRANK H. OGAWA PLAZA SUITE 4314 OAKLAND, CA 94612 (510) 238-3437 FAX (510) 238-7227

LAKESHORE AVENUE SEPARATED BIKE LANES PROJECT FROM E 18TH STREET TO MACARTHUR BOULEVARD

	No.	DATE	BY	REFERENCE
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PLAN PRODUCTION WARNING

THE PLANS HAVE BEEN CREATED ON

ANSLB (11" X 17") SHEETS BEFER TO

GRAPHIC SCALE FOR SHEETS OF


DIFFERENT SIZES.

CONSTRUCTION DETAILS BUS BOARDING ISLAND

1007299

SCALE: AS SHOWN

SHEET NO. CD-16 43 of 83

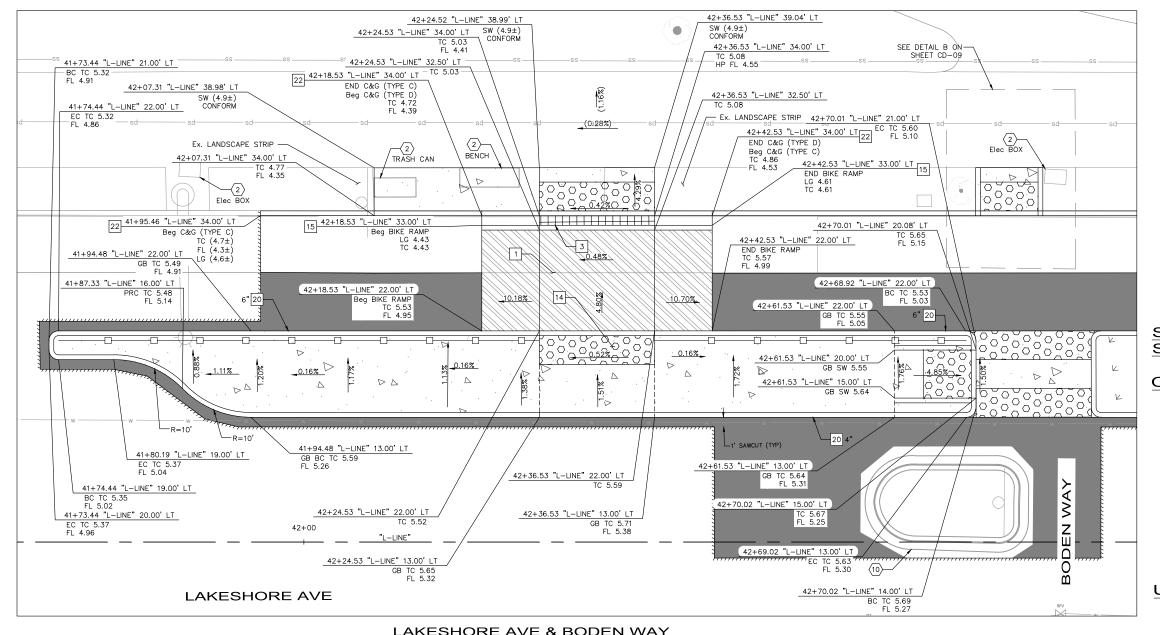

# LAKESHORE AVE & BODEN WAY RAISED TRANSIT ISLAND

SEE SHEET L-06 SEE SHEET DM-06 SCALE 1"=10'

# **LEGEND**

PROPOSED CONCRETE SIDEWALK, BUS BOARDING ISLAND, RAISED ISLAND, AND PEDESTRIAN REFUGE ISLAND 566666 DETECTABLE WARNING SURFACE BASE REPAIR (21" HMA - TYPE A) (SEE NOTE 7). FOR ADDITIONAL DETAILS, SEE AC BASE REPAIR DETAIL ON SHEET CD-19. HMA PAVEMENT (12" DEPTH) PROPOSED LANDSCAPE AREA HHHHH RAISED ISLAND WITH DOWEL CURB RAISED CROSSWALK HAM (TYPE A) OVERLAY (6" MAX) TRENCH GRATE (SEE DD-01) Exist SLOPE \_(X.XX%) \_X.XX% PROPOSED SLOPE GRADE BREAK SAWCUT LIMITS LEAN RAIL

# SEE GENERAL NOTES ON SHEET CD-01

# CONSTRUCTION NOTES

- INSTALL RAISED CROSSING FLUSH WITH BUS BOARDING ISLAND. SEE CD-21 FOR ADDITIONAL DETAILS.
- INSTALL BICYCLE RAMP. MAX 16% SLOPE PER CITY OF OAKLAND STD DWG BP-6.
- INSTALL TRENCH GRATE PER DETAILS A AND B ON SHEET DD-01
- INSTALL SIDEWALK PER CITY OF OAKLAND STD DWG S-1.
- 15 INSTALL RETAINING CURB PER DETAIL E ON SHEET CD-20.
- 20 INSTALL CURB (TYPE A1-6 MOD) PER DETAIL F ON CD-20. CURB HEIGHT AS SHOWN ON PLANS.
- INSTALL CURB AND GUTTER (C&G) PER CITY OF OAKLAND STD DWG S-1. C&G TYPE AS SPECIFIED ON PLANS.

# **UTILITY AND DEMOLITION NOTES**

- $\langle 2 \rangle$ EXISTING TO REMAIN.
- $\langle 10 \rangle$ REMOVE. SEE DEMOLITION PLANS FOR DETAILS.



GRAPHIC SCALE IN FEET 10

# **Kimley** » Horn

DRAWN BY

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TESSA KEMPER/PRIYA PALLIVATHUCAL

Odkidria, California	94012 Fu	( NO. (910)000—00
CHECKED BY	RYAN DOL	E, P.E.
DESIGNED BY	JORGE MC	RALES



PROJECT NO.

CITY OF OAKLAND DEPARTMENT OF TRANSPORTATION 250 FRANK H. OGAWA PLAZA, SLITE 4314 OAKLAND, CA 94612 (510) 238-3437 FAX (510) 238-7227

100% SUBMITTAL

NOT FOR BID OR

CONSTRUCTION

LAKESHORE AVENUE SEPARATED BIKE LANES PROJECT FROM E 18TH STREET TO MACARTHUR BOULEVARD

	·	·	

BY

No.

DATE

PLAN PRODUCTION WARNING THE PLANS HAVE BEEN CREATED ON

ANSLB (11" X 17") SHEETS BEFER TO

REFERENCE


GRAPHIC SCALE FOR SHEETS OF

DIFFERENT SIZES.

CONSTRUCTION DETAILS BUS BOARDING ISLAND

1007299

SCALE: AS SHOWN CD-17 44 of 83

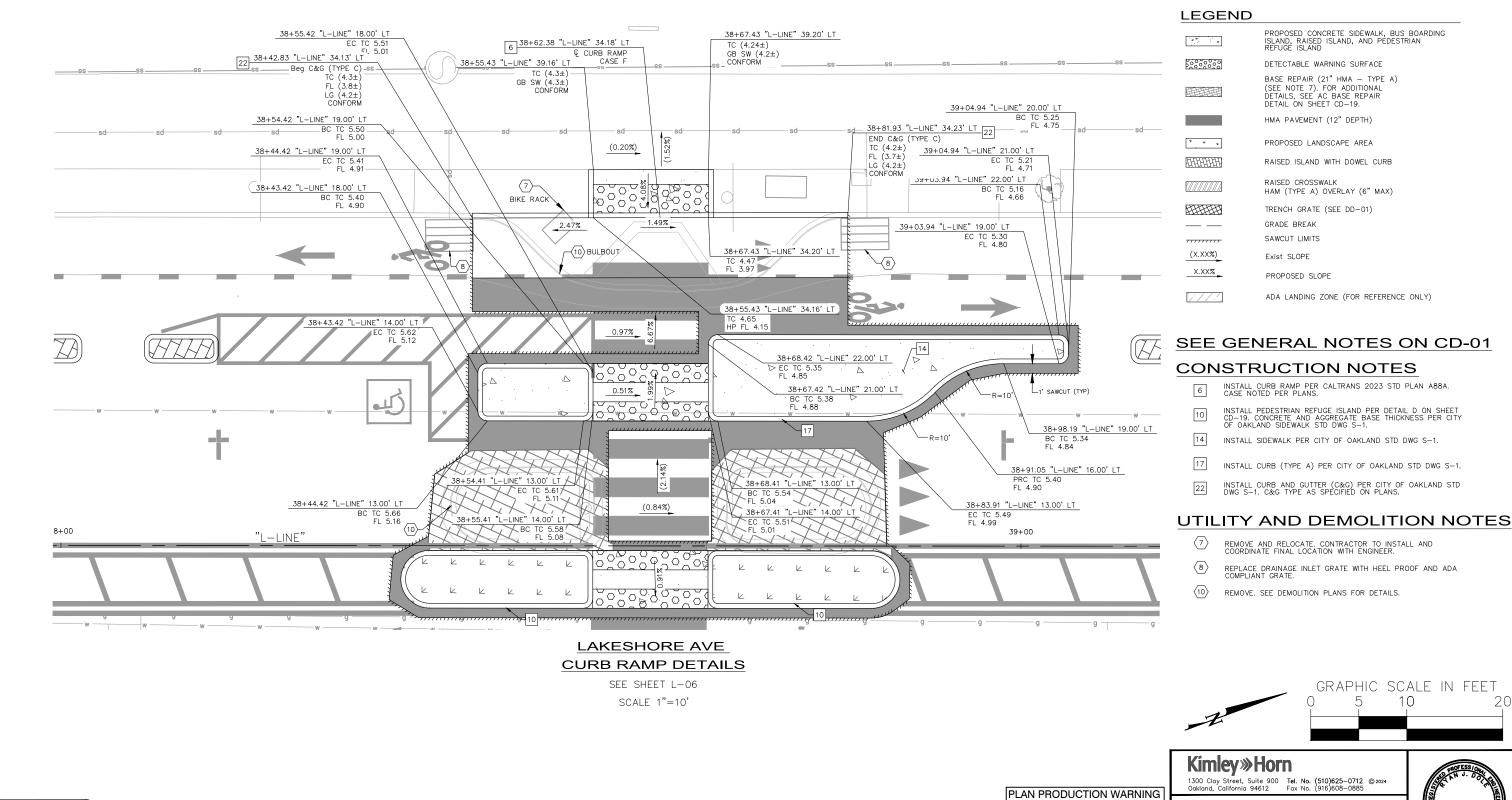

100% SUBMITTAL NOT FOR BID OR CONSTRUCTION

THE PLANS HAVE BEEN CREATED ON ANSLB (11" X 17") SHEETS BEFER TO GRAPHIC SCALE FOR SHEETS OF DIFFERENT SIZES.

CHECKED BY DESIGNED BY DRAWN BY REFERENCE

RYAN DOLE, P.E. No. 075749 JORGE MORALES TESSA KEMPER/PRIYA PALLIVATHUCAL

PROJECT NO.

ONSTRUCTION DETAILS

1007299

SCALE: AS SHOWN

45\_ <sub>OF</sub> <u>83</u>

CITY OF OAKLAND

DEPARTMENT OF TRANSPORTATION 250 FRANK H. OGAWA PLAZA SLIITE 4314 OAKLAND, CA 94612 (510) 238-3437 FAX (510) 238-7227

LAKESHORE AVENUE SEPARATED BIKE LANES PROJECT FROM E 18TH STREET TO MACARTHUR BOULEVARD


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BY

No.

DATE

SHEET NO. CD-18

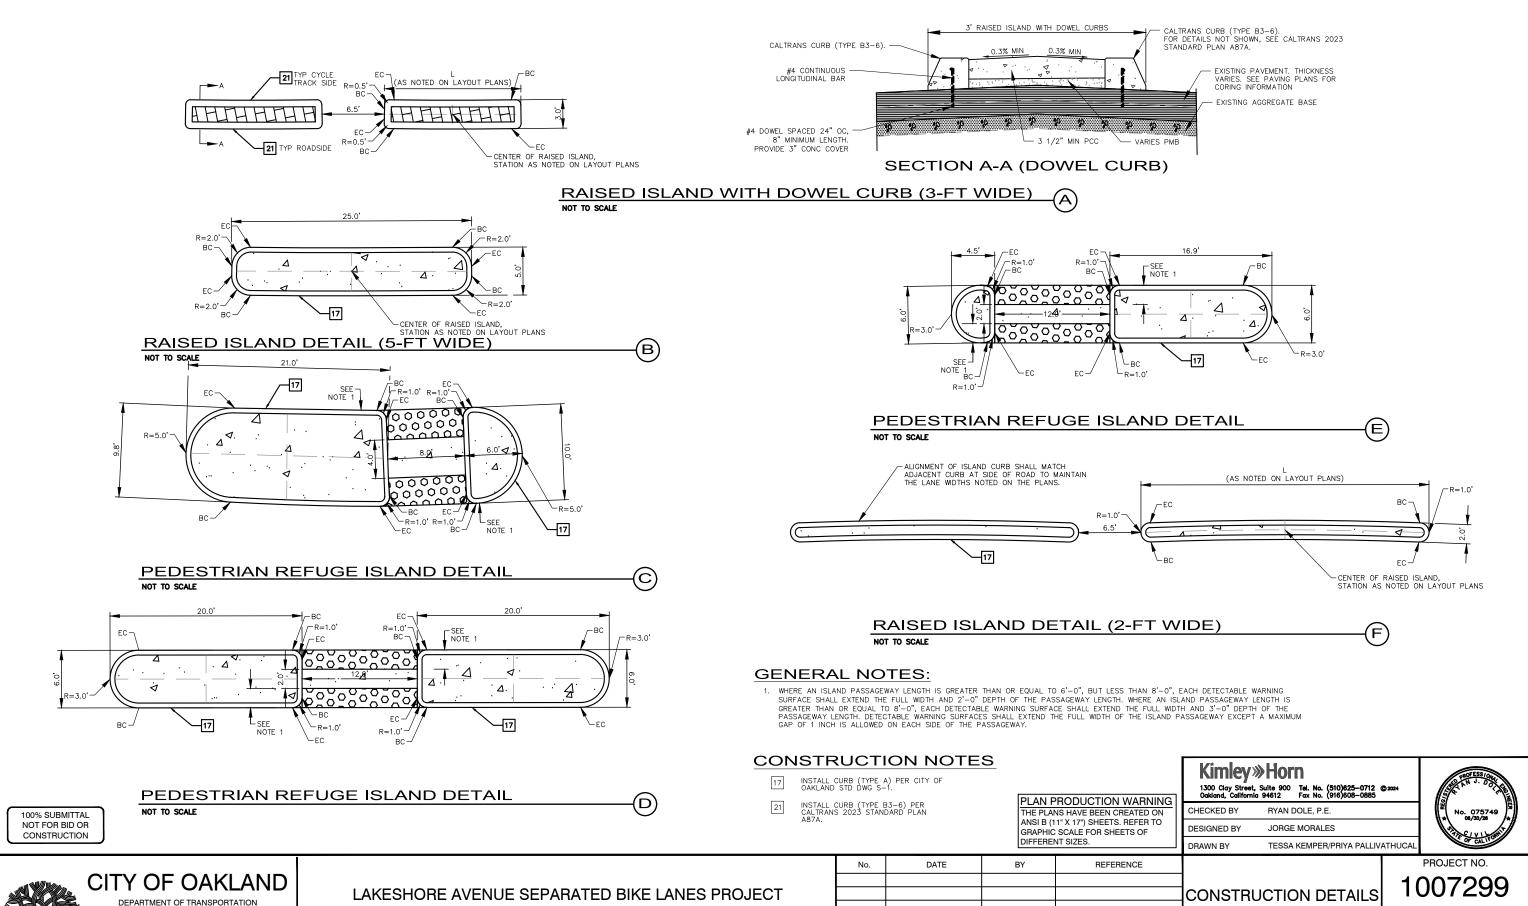

FROM E 18TH STREET TO MACARTHUR BOULEVARD

250 FRANK H. OGAWA PLAZA, SUITE 4314


OAKLAND, CA 94612 (510) 238-3437 FAX (510) 238-7227 NG NAME: K:\OAK\_RDWY\097066204 - Lak NATE: 12-11-24 ED BY: Priya.Pallivathucal


SHEET NO. CD-19

46 <sub>OF</sub> 83


SCALE: AS SHOWN

**RAISED ISLANDS** 

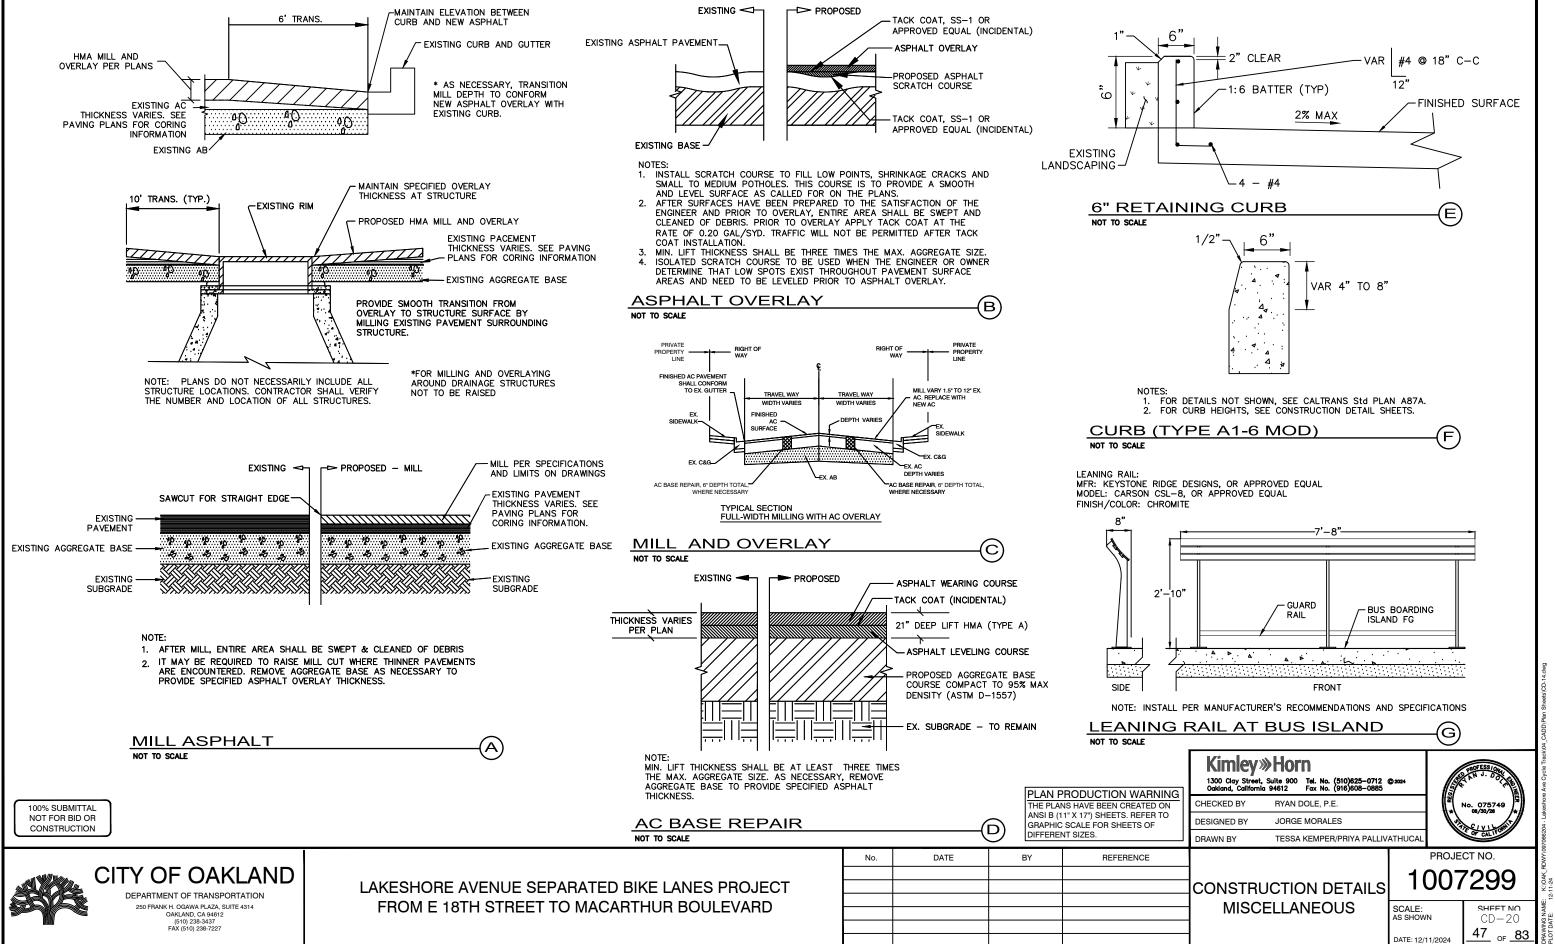

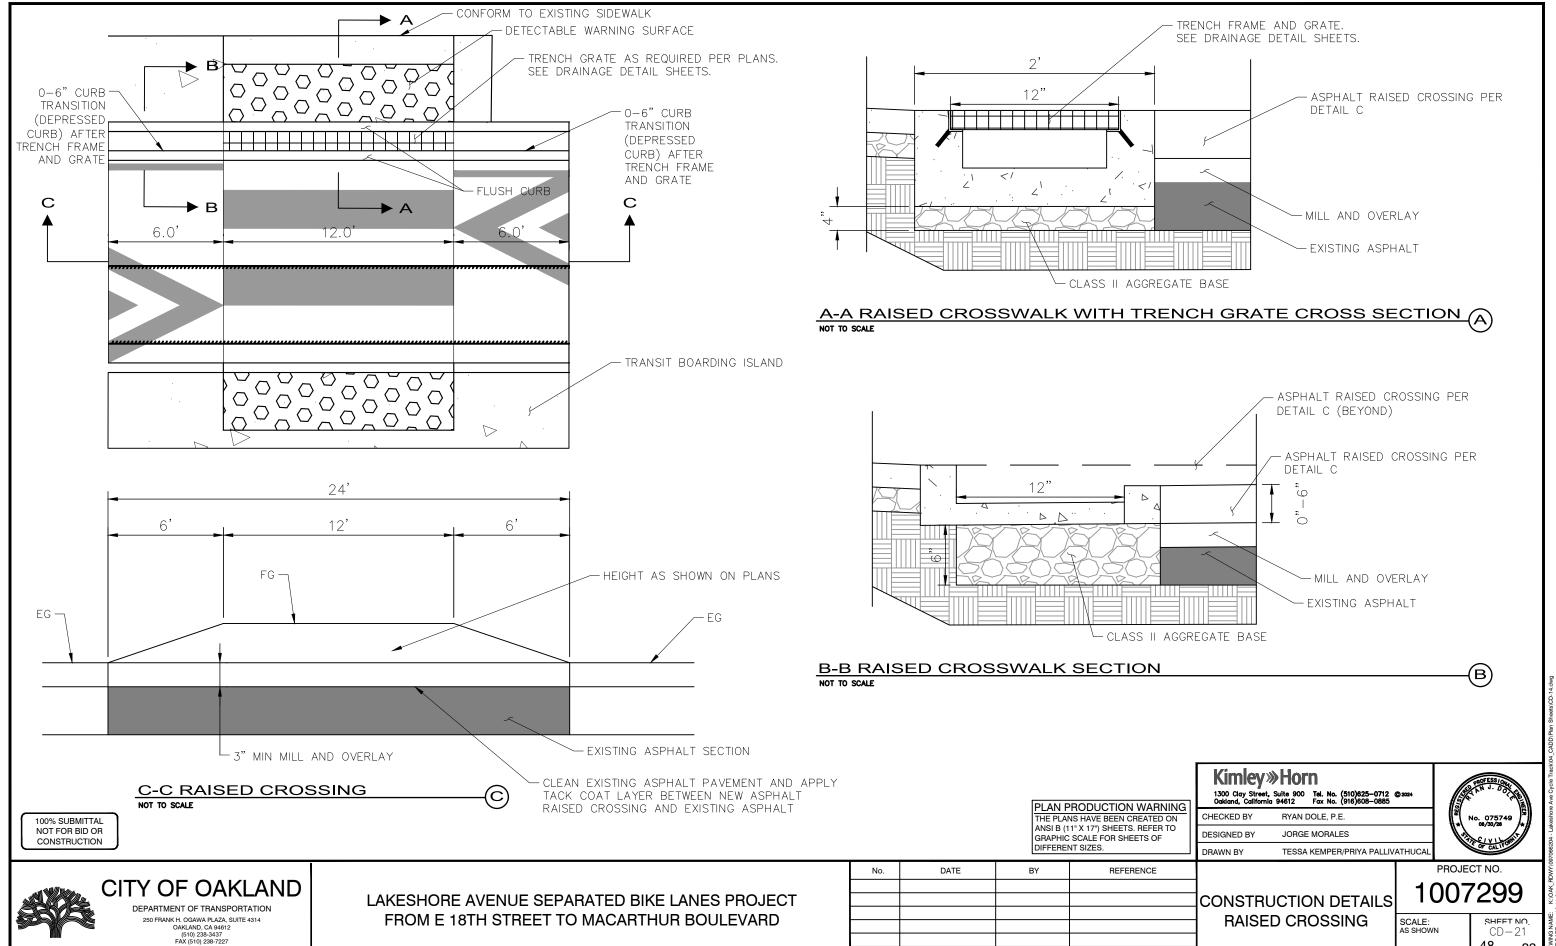


48 of 83

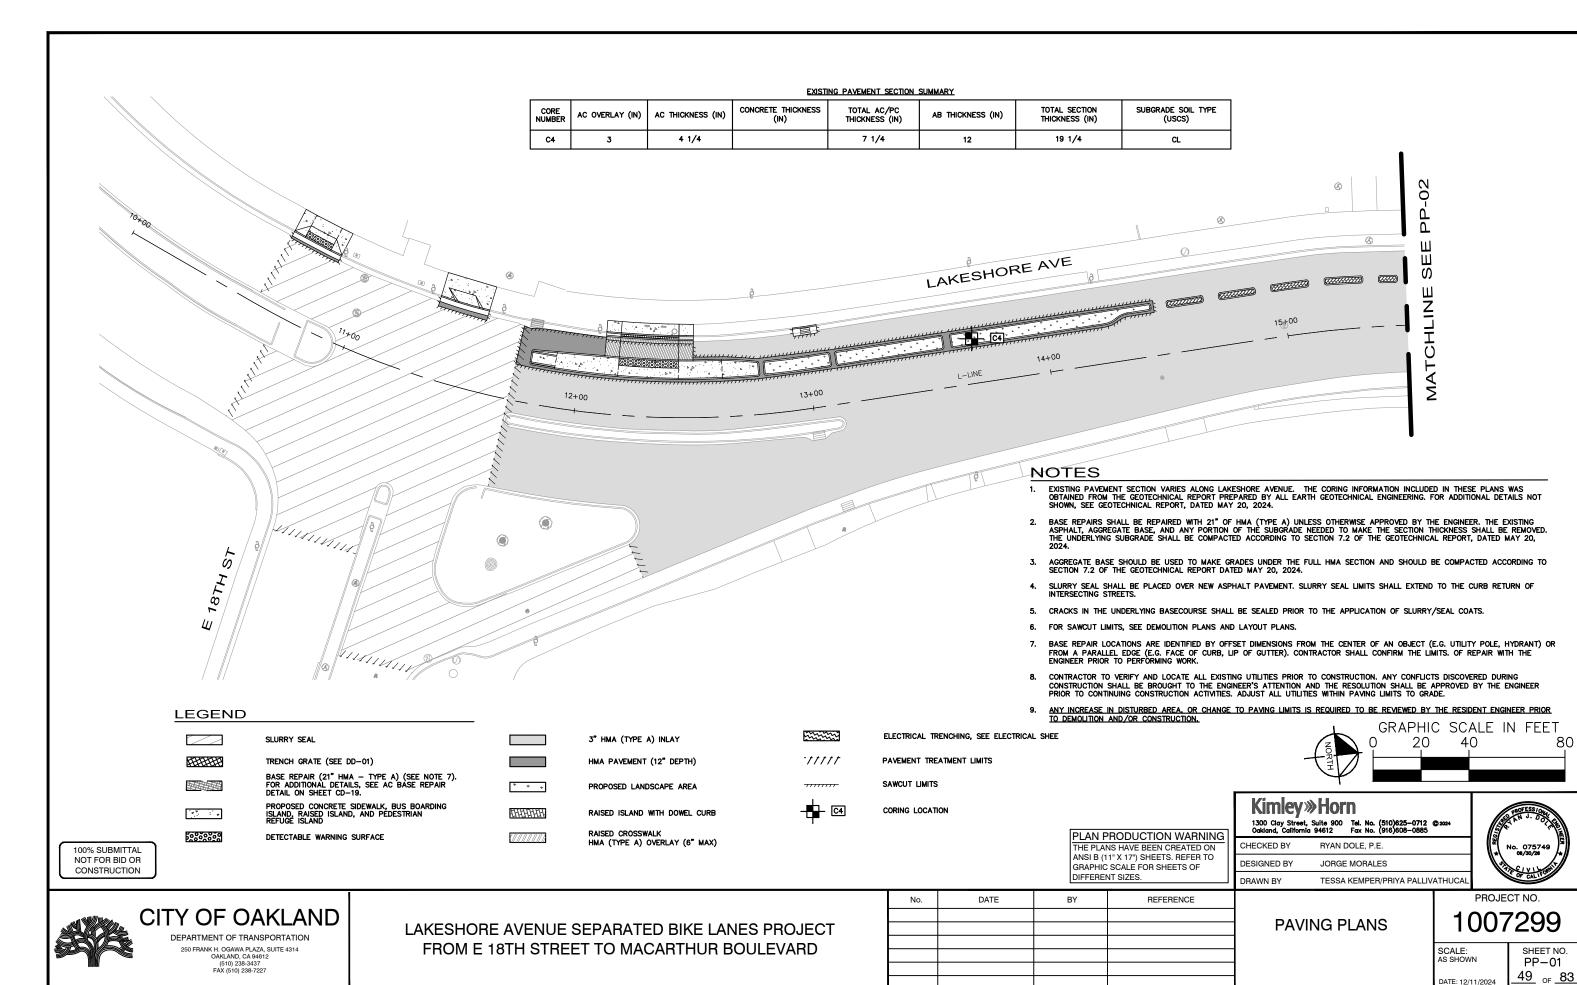

G NAME: K:\OAK\_RDWY\097066204 - Lakeshore A T.E: 12:11-24 D.BY: Priya.Palivathucal

#### EXISTING PAVEMENT SECTION SUMMARY

CORE NUMBER	AC OVERLAY (IN)	AC THICKNESS (IN)	CONCRETE THICKNESS (IN)	TOTAL AC/PC THICKNESS (IN)	AB THICKNESS (IN)	TOTAL SECTION THICKNESS (IN)	SUBGRADE SOIL TYPE (USCS)
C5	2 1/2	2 1/2		5	11	16	CL

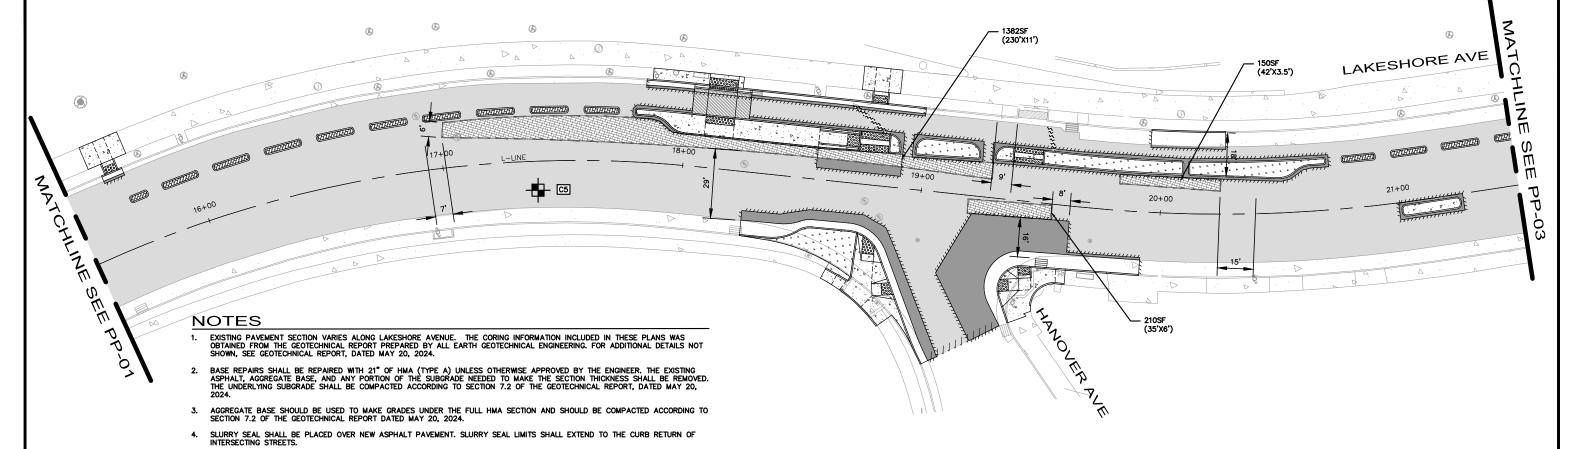

- 5. CRACKS IN THE UNDERLYING BASECOURSE SHALL BE SEALED PRIOR TO THE APPLICATION OF SLURRY/SEAL COATS.
- 6. FOR SAWCUT LIMITS, SEE DEMOLITION PLANS AND LAYOUT PLANS.
- BASE REPAIR LOCATIONS ARE IDENTIFIED BY OFFSET DIMENSIONS FROM THE CENTER OF AN OBJECT (E.G. UTILITY POLE, HYDRANT) OR FROM A PARALLEL EDGE (E.G. FACE OF CURB, LIP OF GUTTER). CONTRACTOR SHALL CONFIRM THE LIMITS. OF REPAIR WITH THE ENGINEER PRIOR TO PERFORMING WORK.
- 8. CONTRACTOR TO VERIFY AND LOCATE ALL EXISTING UTILITIES PRIOR TO CONSTRUCTION. ANY CONFLICTS DISCOVERED DURING CONSTRUCTION SHALL BE BROUGHT TO THE ENGINEER'S ATTENTION AND THE RESOLUTION SHALL BE APPROVED BY THE ENGINEER PRIOR TO CONTINUING CONSTRUCTION ACTIVITIES. ADJUST ALL UTILITIES WITHIN PAVING LIMITS TO GRADE.
- 9. ANY INCREASE IN DISTURBED AREA, OR CHANGE TO PAYING LIMITS IS REQUIRED TO BE REVIEWED BY THE RESIDENT ENGINEER PRIOR TO DEMOLITION AND/OR CONSTRUCTION.

#### **LEGEND**

SLURRY SEAL	
TRENCH GRATE (SEE DD-01)	
BASE REPAIR (21" HMA — TYPE A) (SEE NOTE 7). FOR ADDITIONAL DETAILS, SEE AC BASE REPAIR DETAIL ON SHEET CD—19.	Ľ
PROPOSED CONCRETE SIDEWALK, BUS BOARDING ISLAND, RAISED ISLAND, AND PEDESTRIAN	T.

DETECTABLE WARNING SURFACE

	3" HMA (TYPE A) INLAY
	HMA PAVEMENT (12" DEPTH)
Ψ Ψ Ψ	PROPOSED LANDSCAPE AREA
	RAISED ISLAND WITH DOWEL CURB
	RAISED CROSSWALK HMA (TYPE A) OVERLAY (6" MAX)

ELECTRICAL TRENCHING, SEE ELECTRICAL SHEETS. PAVEMENT TREATMENT LIMITS SAWCUT LIMITS

CORING LOCATION

OR CHANGE TO PAVI REQUIRED TO BE RE RESIDENT ENGINEER DEMOLITION AND/OR	NG LIMITS, IS VIEWED BY THE PRIOR TO CONSTRUCTION.
PLAN PRODUCTI	ON WARNING
THE PLANS HAVE BEE	N CREATED ON

ANY INCREASE IN DISTURBED AREA,

PLAN PRODUCTION WARNING	
THE PLANS HAVE BEEN CREATED ON	
ANSI B (11" X 17") SHEETS. REFER TO	
GRAPHIC SCALE FOR SHEETS OF	
DIFFERENT SIZES.	



**Kimley** » Horn CHECKED BY RYAN DOLE, P.E. DESIGNED BY JORGE MORALES

TESSA KEMPER/PRIYA PALLIVATHUCAL



100% SUBMITTAL

NOT FOR BID OR

CONSTRUCTION

CITY OF OAKLAND

286888

DEPARTMENT OF TRANSPORTATION 250 FRANK H. OGAWA PLAZA, SUITE 4314 OAKLAND, CA 94612 (510) 238-3437 FAX (510) 238-7227

LAKESHORE AVENUE SEPARATED BIKE LANES PROJECT FROM E 18TH STREET TO MACARTHUR BOULEVARD


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**PAVING PLANS** 

PROJECT NO. 1007299


GRAPHIC SCALE IN FEET

SHEET NO. PP-02 50<sub>OF</sub> 83

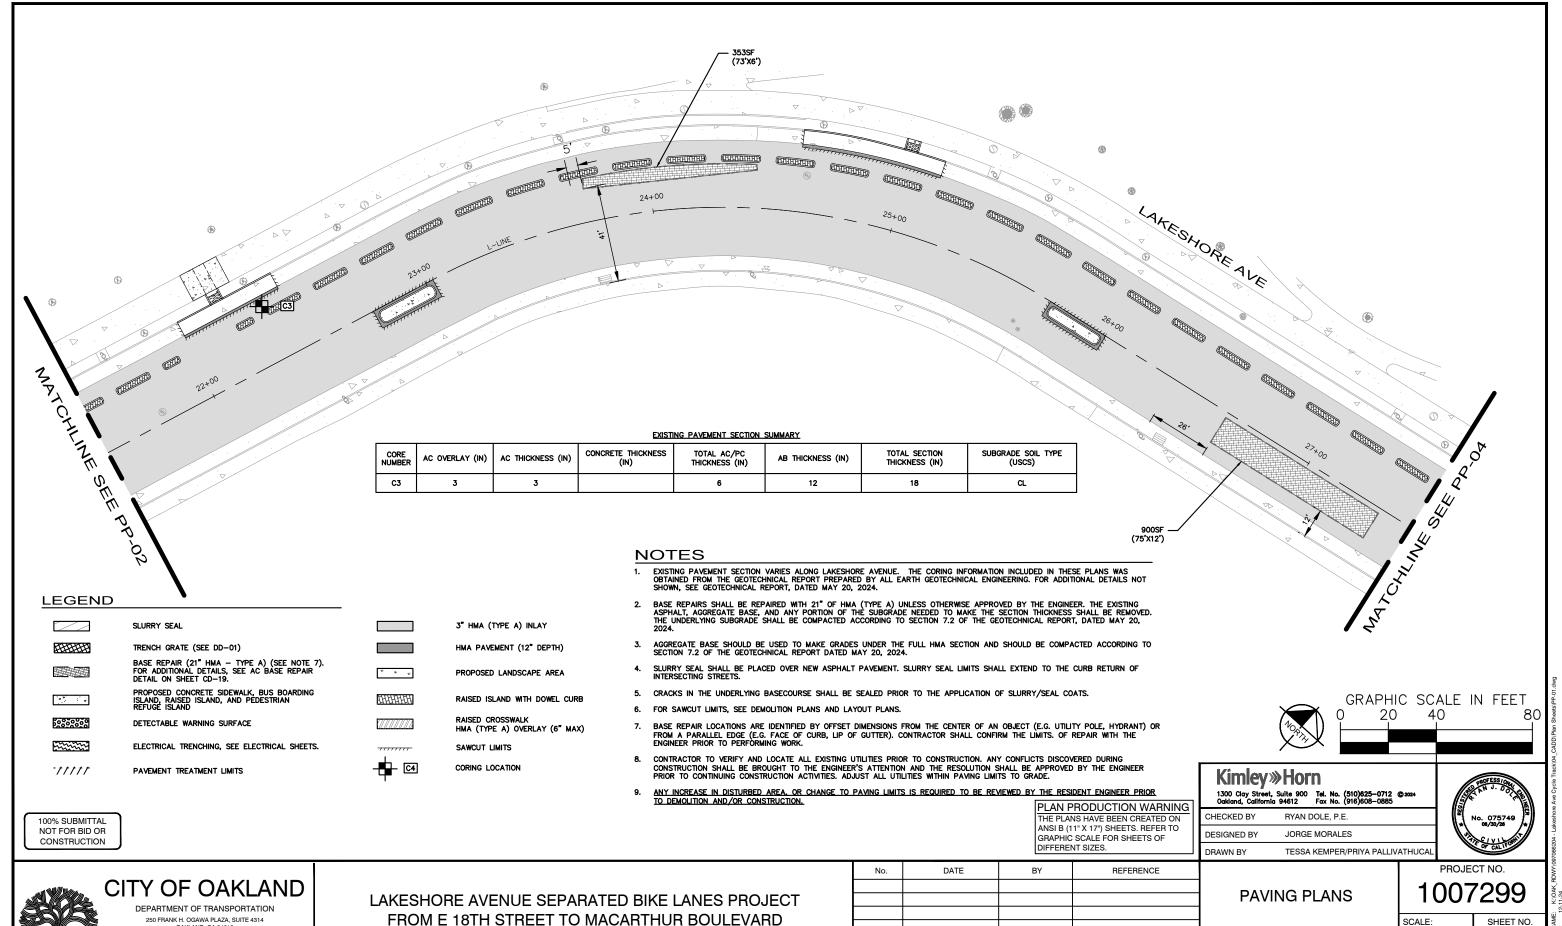

OAKLAND, CA 94612 (510) 238-3437 FAX (510) 238-7227

PP-03 51 of 83

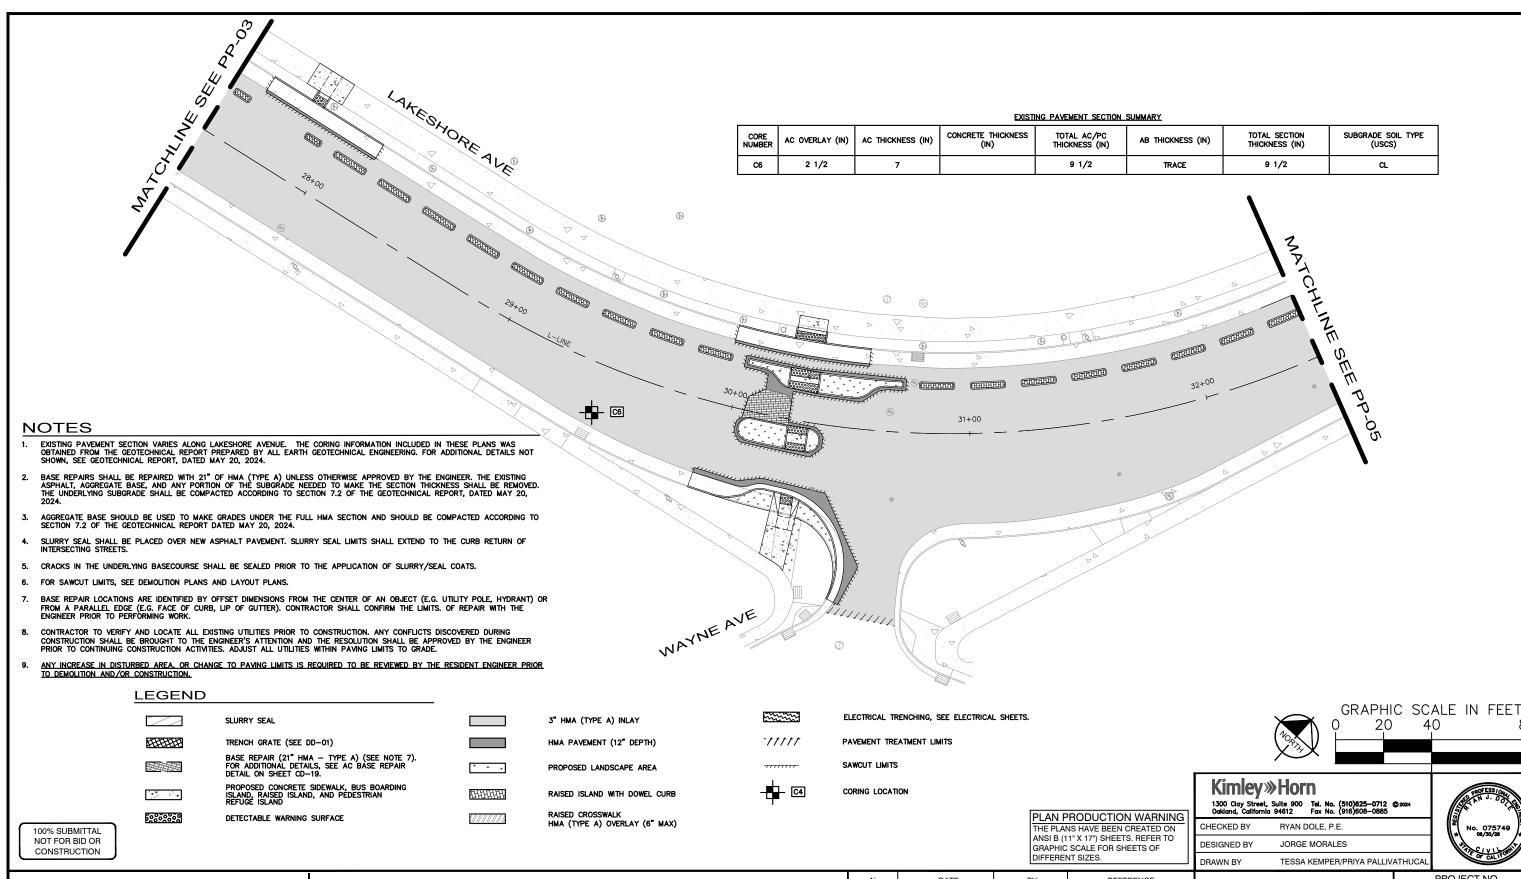

CITY OF OAKLAND

DEPARTMENT OF TRANSPORTATION

250 FRANK H. OGAWA PLAZA, SUITE 4314

OAKLAND, CA 94612

(510) 238-3437

FAX (510) 238-7227

LAKESHORE AVENUE SEPARATED BIKE LANES PROJECT FROM E 18TH STREET TO MACARTHUR BOULEVARD

No.	DATE	BY	REFERENCE

PAVING PLANS


PROJECT NO. 1007299

SCALE: AS SHOWN

SHEET NO. PP-04
52 of 83

VING NAME: K:\OAK\_RDWY\0970662 DATE: 12-11-24 TED BY: Priva.Pallivathucal

CORE NUMBER	AC OVERLAY (IN)	AC THICKNESS (IN)	CONCRETE THICKNESS (IN)	TOTAL AC/PC THICKNESS (IN)	AB THICKNESS (IN)	TOTAL SECTION THICKNESS (IN)	SUBGRADE SOIL TYPE (USCS)
C2	4 1/2	2		6 1/2	4 1/2	11	CL

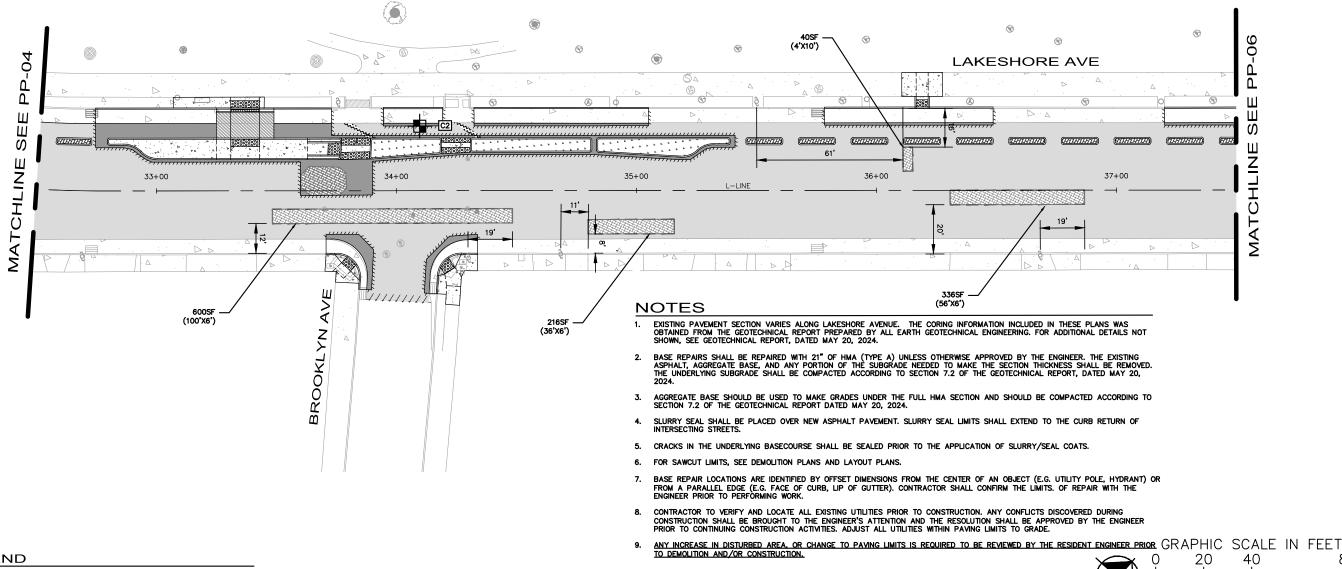

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**LEGEND** 


SLURRY SEAL

TRENCH GRATE (SEE DD-01) BASE REPAIR (21" HMA - TYPE A) (SEE NOTE 7). FOR ADDITIONAL DETAILS, SEE AC BASE REPAIR DETAIL ON SHEET CD-19.

PROPOSED CONCRETE SIDEWALK, BUS BOARDING ISLAND, RAISED ISLAND, AND PEDESTRIAN REFUGE ISLAND 5686868

DETECTABLE WARNING SURFACE

3" HMA (TYPE A) INLAY HMA PAVEMENT (12" DEPTH)

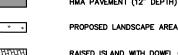

RAISED ISLAND WITH DOWEL CURB HMA (TYPE A) OVERLAY (6" MAX) ELECTRICAL TRENCHING, SEE ELECTRICAL SHEETS.

PAVEMENT TREATMENT LIMITS

SAWCUT LIMITS

CORING LOCATION

PLAN PRODUCTION WARNING THE PLANS HAVE BEEN CREATED ON ANSI B (11" X 17") SHEETS. REFER TO GRAPHIC SCALE FOR SHEETS OF DIFFERENT SIZES.

**Kimley** » Horn

CHECKED BY RYAN DOLE, P.E. **DESIGNED BY** JORGE MORALES

TESSA KEMPER/PRIYA PALLIVATHUCAL



CITY OF OAKLAND

100% SUBMITTAL

NOT FOR BID OR

CONSTRUCTION

DEPARTMENT OF TRANSPORTATION 250 FRANK H. OGAWA PLAZA, SUITE 4314 OAKLAND, CA 94612 (510) 238-3437 FAX (510) 238-7227


LAKESHORE AVENUE SEPARATED BIKE LANES PROJECT FROM E 18TH STREET TO MACARTHUR BOULEVARD

No.	DATE	BY	REFERENCE	

**PAVING PLANS** 

PROJECT NO. 1007299

PP-05 <u>53</u> of <u>83</u>

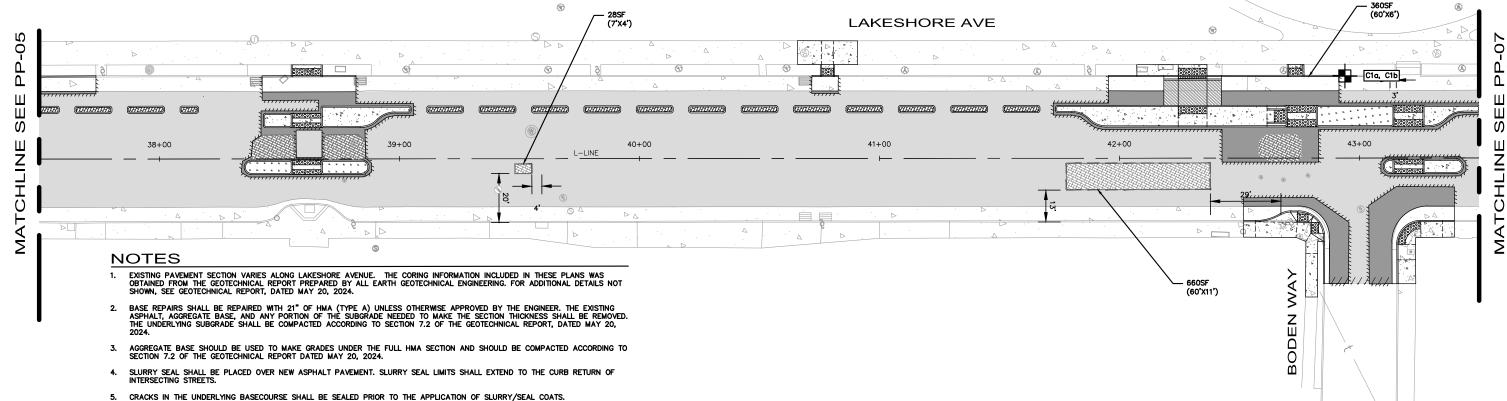

6. FOR SAWCUT LIMITS, SEE DEMOLITION PLANS AND LAYOUT PLANS.

7. BASE REPAIR LOCATIONS ARE IDENTIFIED BY OFFSET DIMENSIONS FROM THE CENTER OF AN OBJECT (E.G. UTILITY POLE, HYDRANT) OR FROM A PARALLEL EDGE (E.G. FACE OF CURB, LIP OF GUTTER). CONTRACTOR SHALL CONFIRM THE LIMITS. OF REPAIR WITH THE ENGINEER PRIOR TO PERFORMING WORK.

8. CONTRACTOR TO VERIFY AND LOCATE ALL EXISTING UTILITIES PRIOR TO CONSTRUCTION. ANY CONFLICTS DISCOVERED DURING CONSTRUCTION SHALL BE BROUGHT TO THE ENGINEER'S ATTENTION AND THE RESOLUTION SHALL BE APPROVED BY THE ENGINEER PRIOR TO CONTINUING CONSTRUCTION ACTIVITIES. ADJUST ALL UTILITIES WITHIN PAVING LIMITS TO GRADE.

9. ANY INCREASE IN DISTURBED AREA, OR CHANGE TO PAYING LIMITS IS REQUIRED TO BE REVIEWED BY THE RESIDENT ENGINEER PRIOR

#### **LEGEND**

3585858

SLURRY SEAL HHHH TRENCH GRATE (SEE DD-01) BASE REPAIR (21" HMA — TYPE A) (SEE NOTE 7). FOR ADDITIONAL DETAILS, SEE AC BASE REPAIR DETAIL ON SHEET CD—19. PROPOSED CONCRETE SIDEWALK, BUS BOARDING ISLAND, RAISED ISLAND, AND PEDESTRIAN REFUGE ISLAND

DETECTABLE WARNING SURFACE

3" HMA (TYPE A) INLAY HMA PAVEMENT (12" DEPTH) PROPOSED LANDSCAPE AREA

RAISED ISLAND WITH DOWEL CURB HMA (TYPE A) OVERLAY (6" MAX) ELECTRICAL TRENCHING, SEE ELECTRICAL SHEETS. 77777 PAVEMENT TREATMENT LIMITS SAWCUT LIMITS CORING LOCATION

PLAN PRODUCTION WARNING THE PLANS HAVE BEEN CREATED ON ANSI B (11" X 17") SHEETS, REFER TO GRAPHIC SCALE FOR SHEETS OF DIFFERENT SIZES.

GRAPHIC SCALE IN FEET

**Kimley** » Horn

CHECKED BY RYAN DOLE, P.E. **DESIGNED BY** JORGE MORALES TESSA KEMPER/PRIYA PALLIVATHUCAL



100% SUBMITTAL

NOT FOR BID OR

CONSTRUCTION

CITY OF OAKLAND

DEPARTMENT OF TRANSPORTATION 250 FRANK H. OGAWA PLAZA, SUITE 4314 OAKLAND, CA 94612 (510) 238-3437 FAX (510) 238-7227

LAKESHORE AVENUE SEPARATED BIKE LANES PROJECT FROM E 18TH STREET TO MACARTHUR BOULEVARD

RAISED CROSSWALK


No.	DATE	BY	REFERENCE

**PAVING PLANS** 

PROJECT NO. 1007299

SCALE: AS SHOWN

PP-06 54 of 83

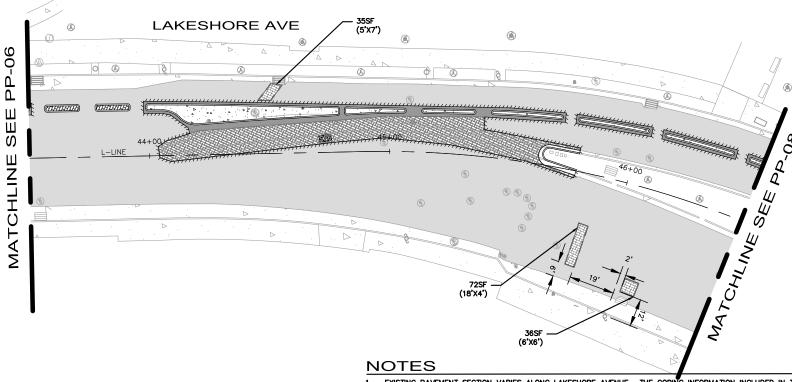

#### **LEGEND**

SLURRY SEAL 3" HMA (TYPE A) INLAY TRENCH GRATE (SEE DD-01) HMA PAVEMENT (12" DEPTH) BASE REPAIR (21" HMA - TYPE A) (SEE NOTE 7). FOR ADDITIONAL DETAILS, SEE AC BASE REPAIR PROPOSED LANDSCAPE AREA DETAIL ON SHEET CD-19. PROPOSED CONCRETE SIDEWALK, BUS BOARDING ISLAND, RAISED ISLAND, AND PEDESTRIAN REFUGE ISLAND RAISED ISLAND WITH DOWEL CURB RAISED CROSSWALK 8588888 DETECTABLE WARNING SURFACE HMA (TYPE A) OVERLAY (6" MAX) ELECTRICAL TRENCHING, SEE ELECTRICAL SHEETS. SAWCUT LIMITS \_\_\_\_\_\_ C4 CORING LOCATION 7//// PAVEMENT TREATMENT LIMITS

EXISTING PAVEMENT SECTION VARIES ALONG LAKESHORE AVENUE. THE CORING INFORMATION INCLUDED IN THESE PLANS WAS OBTAINED FROM THE GEOTECHNICAL REPORT PREPARED BY ALL EARTH GEOTECHNICAL ENGINEERING. FOR ADDITIONAL DETAILS NOT SHOWN, SEE GEOTECHNICAL REPORT, DATED MAY 20, 2024.

- 2. BASE REPAIRS SHALL BE REPAIRED WITH 21" OF HMA (TYPE A) UNLESS OTHERWISE APPROVED BY THE ENGINEER. THE EXISTING ASPHALT, AGGREGATE BASE, AND ANY PORTION OF THE SUBGRADE NEEDED TO MAKE THE SECTION THICKNESS SHALL BE REMOVED. THE UNDERLYING SUBGRADE SHALL BE COMPACTED ACCORDING TO SECTION 7.2 OF THE GEOTECHNICAL REPORT, DATED MAY 20,
- 3. AGGREGATE BASE SHOULD BE USED TO MAKE GRADES UNDER THE FULL HMA SECTION AND SHOULD BE COMPACTED ACCORDING TO SECTION 7.2 OF THE GEOTECHNICAL REPORT DATED MAY 20, 2024.
- SLURRY SEAL SHALL BE PLACED OVER NEW ASPHALT PAVEMENT. SLURRY SEAL LIMITS SHALL EXTEND TO THE CURB RETURN OF INTERSECTING STREETS.
- 5. CRACKS IN THE UNDERLYING BASECOURSE SHALL BE SEALED PRIOR TO THE APPLICATION OF SLURRY/SEAL COATS.

DATE

- 6. FOR SAWCUT LIMITS, SEE DEMOLITION PLANS AND LAYOUT PLANS.
- 7. BASE REPAIR LOCATIONS ARE IDENTIFIED BY OFFSET DIMENSIONS FROM THE CENTER OF AN OBJECT (E.G. UTILITY POLE, HYDRANT) OR FROM A PARALLEL EDGE (E.G. FACE OF CURB, LIP OF GUTTER). CONTRACTOR SHALL CONFIRM THE LIMITS. OF REPAIR WITH THE ENGINEER PRIOR TO PERFORMING WORK.
- CONTRACTOR TO VERIFY AND LOCATE ALL EXISTING UTILITIES PRIOR TO CONSTRUCTION. ANY CONFLICTS DISCOVERED DURING CONSTRUCTION SHALL BE BROUGHT TO THE ENGINEER'S ATTENTION AND THE RESOLUTION SHALL BE APPROVED BY THE ENGINEER PRIOR TO CONTINUING CONSTRUCTION ACTIVITIES. ADJUST ALL UTILITIES WITHIN PAVING LIMITS TO GRADE.

9. ANY INCREASE IN DISTURBED AREA. OR CHANGE TO PAYING LIMITS IS REQUIRED TO BE REVIEWED BY THE RESIDENT ENGINEER PRIOR TO DEMOLITION AND/OR CONSTRUCTION.



GRAPHIC SCALE IN FEET 40

PLAN PRODUCTION WARNING THE PLANS HAVE BEEN CREATED ON ANSI B (11" X 17") SHEETS. REFER TO GRAPHIC SCALE FOR SHEETS OF

REFERENCE

**Kimley** »Horn 1300 Clay Street, Suite 900 Tel. No. (510)625-0712 @2020 Fax No. (916)608-0885 CHECKED BY RYAN DOLE, P.E.

JORGE MORALES DESIGNED BY

DRAWN BY TESSA KEMPER/PRIYA PALLIVATHUCAL



PROJECT NO.

100% SUBMITTAL

NOT FOR BID OR

CONSTRUCTION

# CITY OF OAKLAND

DEPARTMENT OF TRANSPORTATION 250 FRANK H. OGAWA PLAZA, SUITE 4314 OAKLAND, CA 94612 (510) 238-3437 FAX (510) 238-7227

LAKESHORE AVENUE SEPARATED BIKE LANES PROJECT FROM E 18TH STREET TO MACARTHUR BOULEVARD

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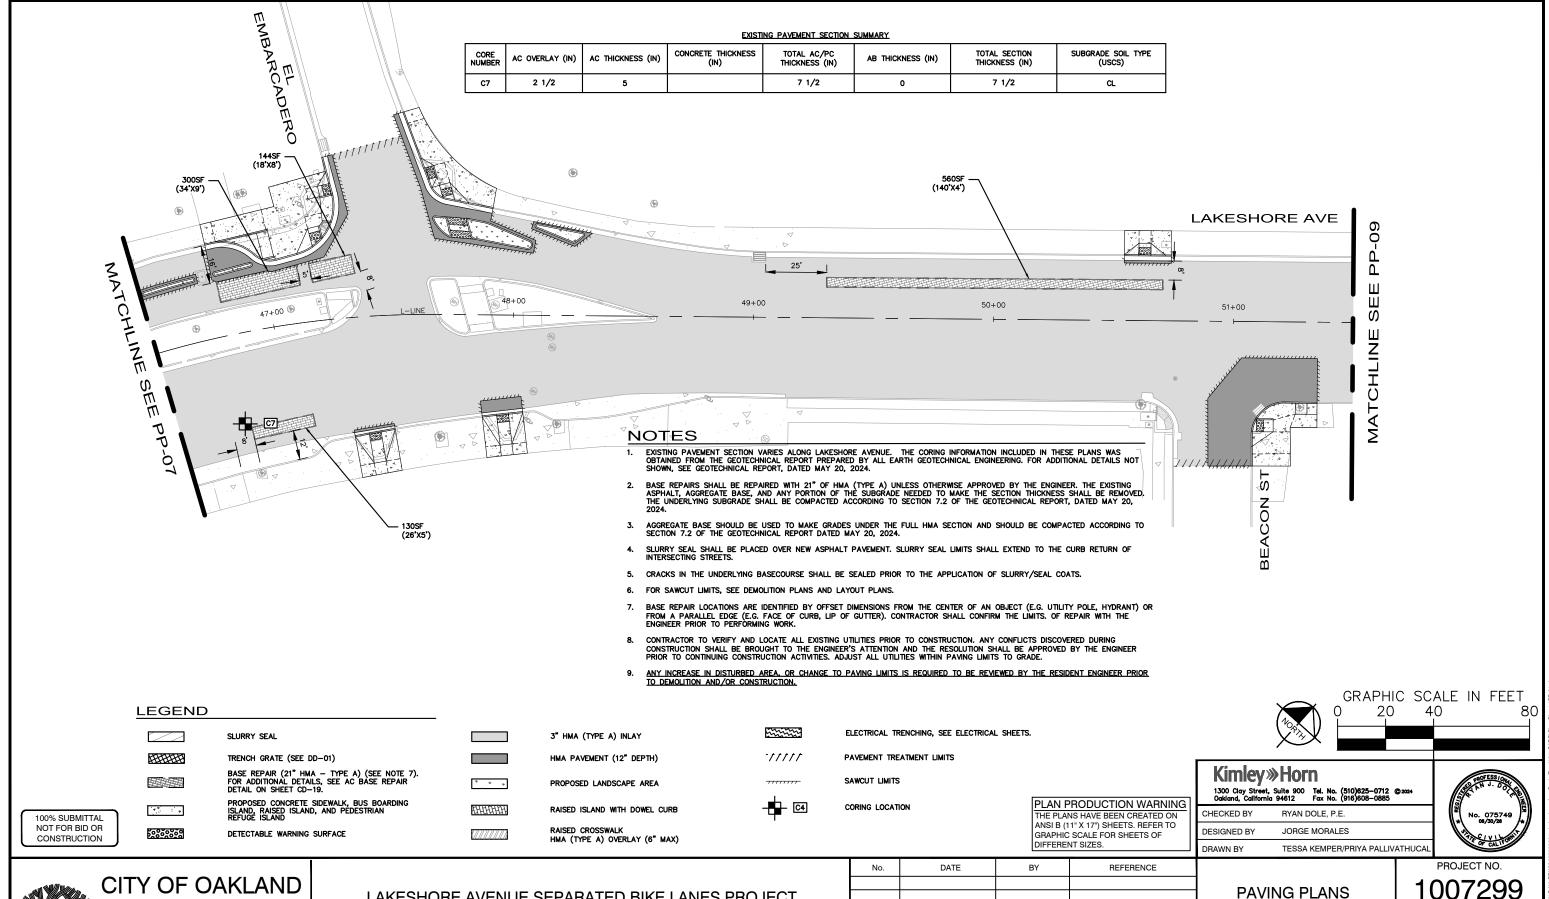
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DIFFERENT SIZES.

**PAVING PLANS** 

1007299

PP-07 55 OF 83



DEPARTMENT OF TRANSPORTATION 250 FRANK H. OGAWA PLAZA, SUITE 4314 OAKLAND, CA 94612 (510) 238-3437 FAX (510) 238-7227


LAKESHORE AVENUE SEPARATED BIKE LANES PROJECT FROM E 18TH STREET TO MACARTHUR BOULEVARD

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AS SHOWN

PP-08 56 <sub>OF 83</sub>



DEPARTMENT OF TRANSPORTATION 250 FRANK H. OGAWA PLAZA, SUITE 4314 OAKLAND, CA 94612 (510) 238-3437 FAX (510) 238-7227

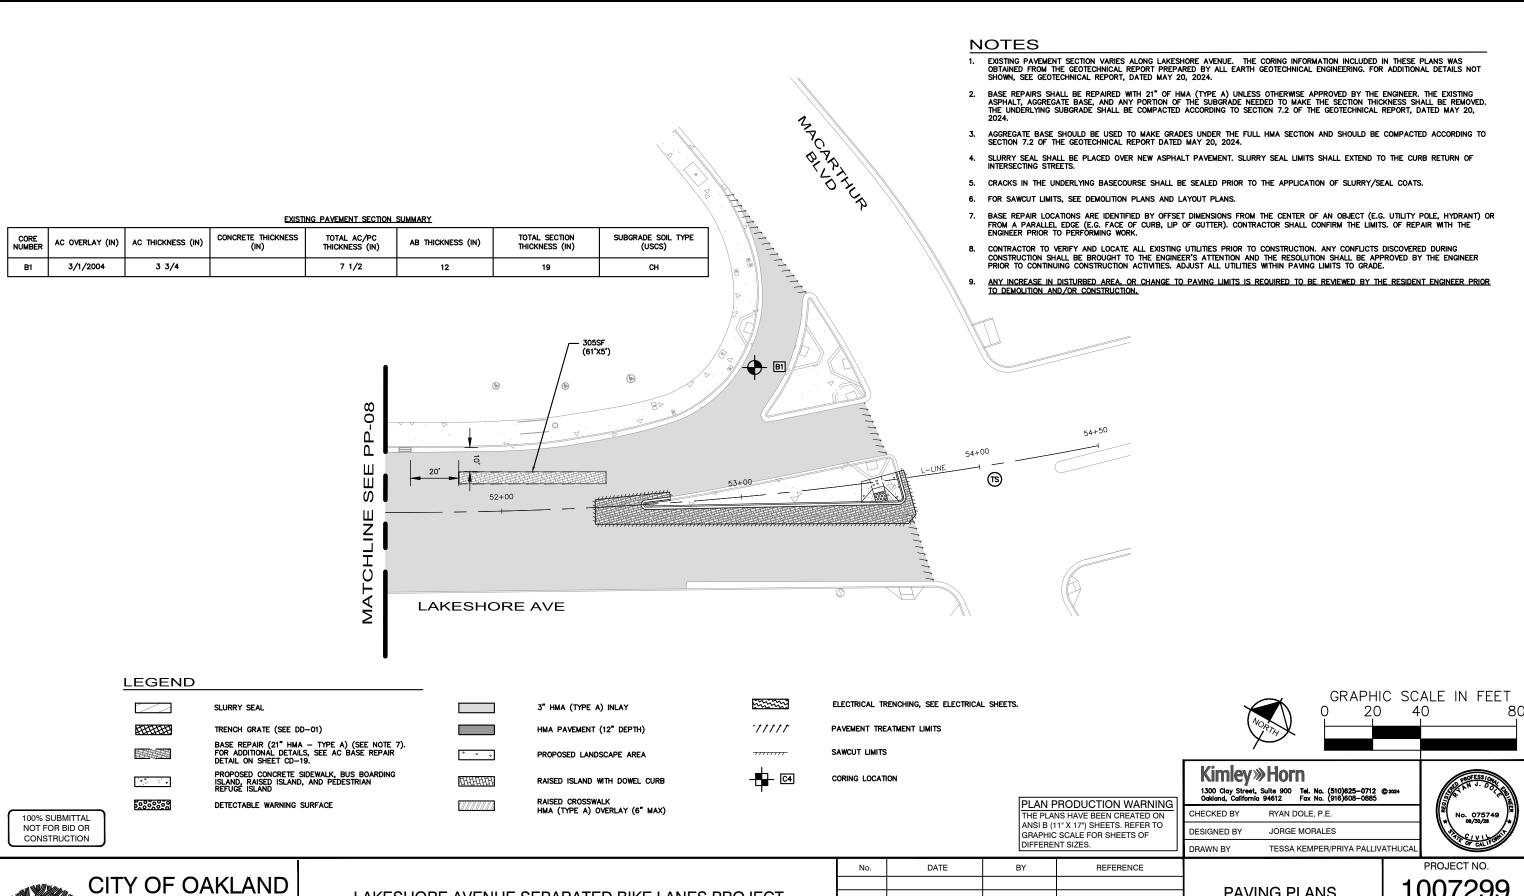
LAKESHORE AVENUE SEPARATED BIKE LANES PROJECT FROM E 18TH STREET TO MACARTHUR BOULEVARD

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**PAVING PLANS** 

1007299

SHEET NO. PP-09 57 of 83

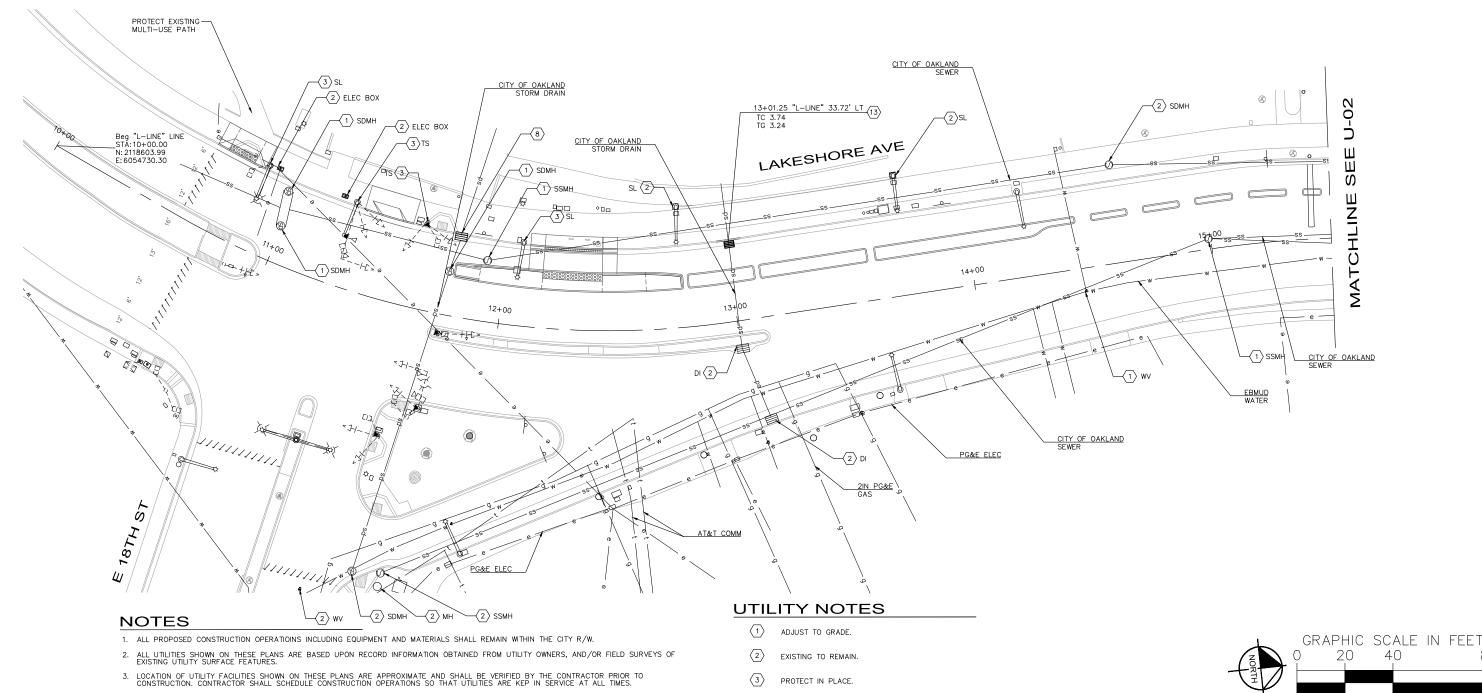

4. CONTRACTOR SHALL VERIFY LOCATION AND DEPTH OF ALL EXISTING UTILITIES PRIOR TO WORK AND SHALL BE HELD LIABLE FOR ALL DAMAGES INCURRED. CALL SERVICE ALERT (U.S.A) AT (800) 227-2600 48 HOURS PRIOR TO EXCAVATION. ANY CONFLICTS DISCOVERED DURING CONSTRUCTION SHALL BE REPOUGHT TO THE ENGINEER'S ATTENTION AND THE RESOLUTION SHALL BE APPROVED BY BOTH THE CITY AND THE ENGINEER PRIOR TO CONTINUING CONSTRUCTION ACTIVITIES. ADJUST ALL UTILITIES WITHIN PAVING LIMITS TO GRADE.

- 5. CONTRACTOR TO MAINTAIN NECESSARY CLEARANCE TO OVERHEAD LINES AT ALL TIMES.
- 6. CONTRACTOR TO RAISE DRAINAGE INLET GRATE TO NEW GRADES AS SHOWN. PROTECT IN PLACE EXISTING SD LINE AND STRUCTURE.
- 7. CONTRACTOR SHALL REPLACE ALL DRAINAGE INLET GRATES WITH HEEL PROOF AND ADA COMPLIANT GRATES.
- 8. FOR CHANNEL DRAIN DETAIL, SEE DRAINAGE DETAILS.
- 9. FOR TRAFFIC SIGNAL IMPROVEMENTS, SEE ELECTRICAL PLANS.

REPLACE DRAINAGE INLET GRATE WITH HEEL PROOF AND ADA COMPLIANT GRATE.

DATE

INSTALL DRAINAGE INLET WITH HEEL PROOF AND ADA COMPLIANT GRATE.

PLAN PRODUCTION WARNING THE PLANS HAVE BEEN CREATED ON ANSI B (11" X 17") SHEETS, REFER TO GRAPHIC SCALE FOR SHEETS OF DIFFERENT SIZES.

REFERENCE

# **Kimley** »Horn

		TEOO A LICENSED IDDINA DALLINATURO
	DESIGNED BY	JORGE MORALES
ı	CHECKED BY	RYAN DOLE, P.E.

TESSA KEMPER/PRIYA PALLIVATHUCAI

PROJECT NO.

1007299



100% SUBMITTAL

NOT FOR BID OR

CONSTRUCTION

# CITY OF OAKLAND


DEPARTMENT OF TRANSPORTATION 250 FRANK H. OGAWA PLAZA. SUITE 4314 OAKLAND, CA 94612 (510) 238-3437 FAX (510) 238-7227

LAKESHORE AVENUE SEPARATED BIKE LANES PROJECT FROM E 18TH STREET TO MACARTHUR BOULEVARD

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RAINAGE AND UTILITY **PLANS** 

SCALE: AS SHOWN SHEET NO. U - 0158 <sub>OF</sub> 83

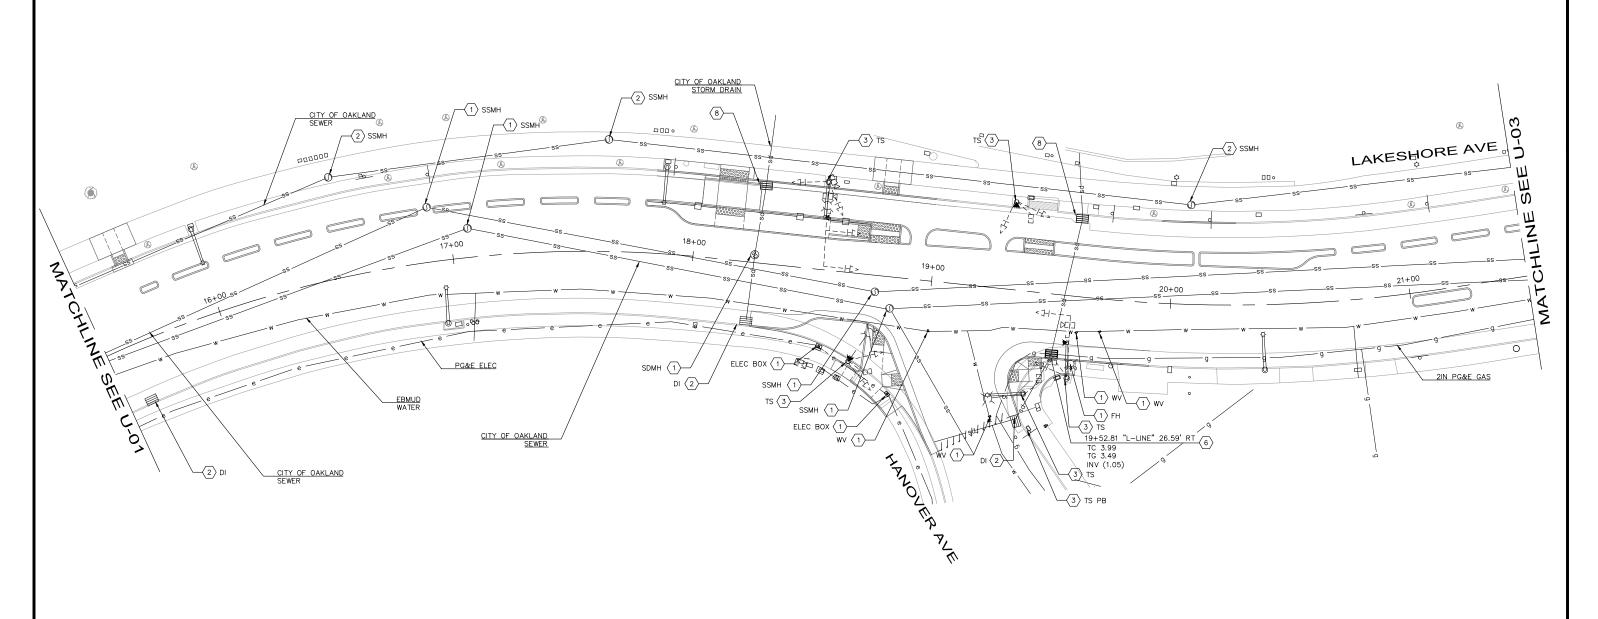

- 1. ALL PROPOSED CONSTRUCTION OPERATIONS INCLUDING EQUIPMENT AND MATERIALS SHALL REMAIN WITHIN THE CITY R/W.
- 2. ALL UTILITIES SHOWN ON THESE PLANS ARE BASED UPON RECORD INFORMATION OBTAINED FROM UTILITY OWNERS, AND/OR FIELD SURVEYS OF EXISTING UTILITY SURFACE FEATURES.
- 3. LOCATION OF UTILITY FACILITIES SHOWN ON THESE PLANS ARE APPROXIMATE AND SHALL BE VERIFIED BY THE CONTRACTOR PRIOR TO CONSTRUCTION. CONTRACTOR SHALL SCHEDULE CONSTRUCTION OPERATIONS SO THAT UTILITIES ARE KEP IN SERVICE AT ALL TIMES.
- 4. CONTRACTOR SHALL VERIFY LOCATION AND DEPTH OF ALL EXISTING UTILITIES PRIOR TO WORK AND SHALL BE HELD LIABLE FOR ALL DAMAGES INCURRED. CALL SERVICE ALERT (U.S.A) AT (800) 227-2600 48 HOURS PRIOR TO EXCAVATION. ANY CONFLICTS DISCOVERED DURING CONSTRUCTION SHALL BE BROUGHT TO THE ENGINEER'S ATTENTION AND THE RESOLUTION SHALL BE APPROVED BY BOTH THE CITY AND THE ENGINEER PRIOR TO CONTINUING CONSTRUCTION ACTIVITIES. ADJUST ALL UTILITIES WITHIN PAYING LIMITS TO GRADE.
- 5. CONTRACTOR TO MAINTAIN NECESSARY CLEARANCE TO OVERHEAD LINES AT ALL TIMES.
- 6. CONTRACTOR TO RAISE DRAINAGE INLET GRATE TO NEW GRADES AS SHOWN. PROTECT IN PLACE EXISTING SD LINE AND STRUCTURE.
- 7. CONTRACTOR SHALL REPLACE ALL DRAINAGE INLET GRATES WITH HEEL PROOF AND ADA COMPLIANT GRATES.
- 8. FOR CHANNEL DRAIN DETAIL, SEE DRAINAGE DETAILS.
- 9. FOR TRAFFIC SIGNAL IMPROVEMENTS, SEE ELECTRICAL PLANS.

#### **UTILITY NOTES**

- ADJUST TO GRADE.
- EXISTING TO REMAIN.
- 3 PROTECT IN PLACE.
- REMOVE AND REPLACE STORM DRAIN INLET.
- REPLACE DRAINAGE INLET GRATE WITH HEEL PROOF AND ADA COMPLIANT GRATE.

# Kimley»Horn

1300 Clay Street, Suite 900 Tel. No. (510)625-0712 © 2024 Gallond, California 94612 Fax No. (916)608-0885

CHECKED BY RYAN DOLE, P.E.

JORGE MORALES **DESIGNED BY** TESSA KEMPER/PRIYA PALLIVATHUCAL



PROJECT NO.

1007299

GRAPHIC SCALE IN FEET

SHEET NO. U - 0259 OF 83

PLAN PRODUCTION WARNING THE PLANS HAVE BEEN CREATED ON ANSI B (11" X 17") SHEETS. REFER TO GRAPHIC SCALE FOR SHEETS OF DIFFERENT SIZES.

DATE REFERENCE DRAINAGE AND UTILITY **PLANS** 

100% SUBMITTAL


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CONSTRUCTION

# CITY OF OAKLAND

DEPARTMENT OF TRANSPORTATION 250 FRANK H. OGAWA PLAZA, SUITE 4314 OAKLAND, CA 94612 (510) 238-3437 FAX (510) 238-7227

LAKESHORE AVENUE SEPARATED BIKE LANES PROJECT FROM E 18TH STREET TO MACARTHUR BOULEVARD

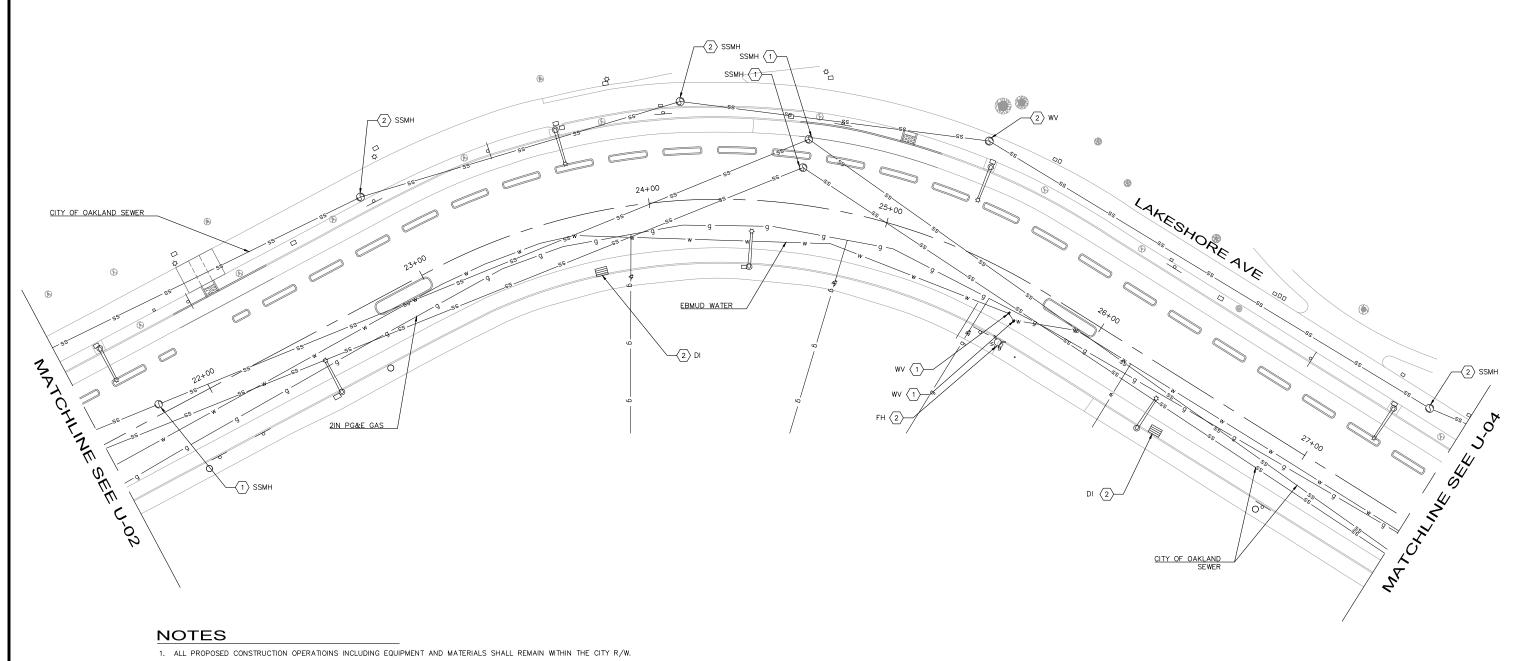

- 2. ALL UTILITIES SHOWN ON THESE PLANS ARE BASED UPON RECORD INFORMATION OBTAINED FROM UTILITY OWNERS, AND/OR FIELD SURVEYS OF EXISTING UTILITY SURFACE FEATURES.
- 3. LOCATION OF UTILITY FACILITIES SHOWN ON THESE PLANS ARE APPROXIMATE AND SHALL BE VERIFIED BY THE CONTRACTOR PRIOR TO CONSTRUCTION. CONTRACTOR SHALL SCHEDULE CONSTRUCTION OPERATIONS SO THAT UTILITIES ARE KEP IN SERVICE AT ALL TIMES.
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- 5. CONTRACTOR TO MAINTAIN NECESSARY CLEARANCE TO OVERHEAD LINES AT ALL TIMES.
- 6. CONTRACTOR TO RAISE DRAINAGE INLET GRATE TO NEW GRADES AS SHOWN. PROTECT IN PLACE EXISTING SD LINE AND STRUCTURE.
- 7. CONTRACTOR SHALL REPLACE ALL DRAINAGE INLET GRATES WITH HEEL PROOF AND ADA COMPLIANT GRATES.
- 8. FOR CHANNEL DRAIN DETAIL, SEE DRAINAGE DETAILS.
- 9. FOR TRAFFIC SIGNAL IMPROVEMENTS, SEE ELECTRICAL PLANS.

# **UTILITY NOTES**

1 ADJUST TO GRADE.

2 EXISTING TO REMAIN.

DESIGNED BY JORGE MORALES

DRAWN BY TESSA KEMPER/PRIYA PALLIVATHUCAL



GRAPHIC SCALE IN FEET

PROJECT NO.

100% SUBMITTAL

NOT FOR BID OR

CONSTRUCTION

# CITY OF OAKLAND

DEPARTMENT OF TRANSPORTATION

250 FRANK H. OGAWA PLAZA, SUITE 4314

OAKLAND, CA 94612

(510) 238-3437

FAX (510) 238-7227

LAKESHORE AVENUE SEPARATED BIKE LANES PROJECT FROM E 18TH STREET TO MACARTHUR BOULEVARD

	REFERENCE	BY	DATE	No.
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THE PLANS HAVE BEEN CREATED ON

ANSI B (11" X 17") SHEETS. REFER TO

GRAPHIC SCALE FOR SHEETS OF

DIFFERENT SIZES.


# DRAINAGE AND UTILITY PLANS

1007299

SCALE: AS SHOWN	SHEET N
DATE: 12/11/2024	<u>60</u> of

NO.

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- 4. CONTRACTOR SHALL VERIFY LOCATION AND DEPTH OF ALL EXISTING UTILITIES PRIOR TO WORK AND SHALL BE HELD LIABLE FOR ALL DAMAGES INCURRED. CALL SERVICE ALERT (U.S.A) AT (800) 227-2600 48 HOURS PRIOR TO EXCAVATION. ANY CONFLICTS DISCOVERED DURING CONSTRUCTION SHALL BE BROUGHT TO THE ENGINEER'S ATTENTION AND THE RESOLUTION SHALL BE APPROVED BY BOTH THE CITY AND THE ENGINEER PRIOR TO CONTINUING CONSTRUCTION ACTIVITIES. ADJUST ALL UTILITIES WITHIN PAYING LIMITS TO GRADE.
- 5. CONTRACTOR TO MAINTAIN NECESSARY CLEARANCE TO OVERHEAD LINES AT ALL TIMES.
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- 7. CONTRACTOR SHALL REPLACE ALL DRAINAGE INLET GRATES WITH HEEL PROOF AND ADA COMPLIANT GRATES.
- 8. FOR CHANNEL DRAIN DETAIL, SEE DRAINAGE DETAILS.
- 9. FOR TRAFFIC SIGNAL IMPROVEMENTS, SEE ELECTRICAL PLANS.

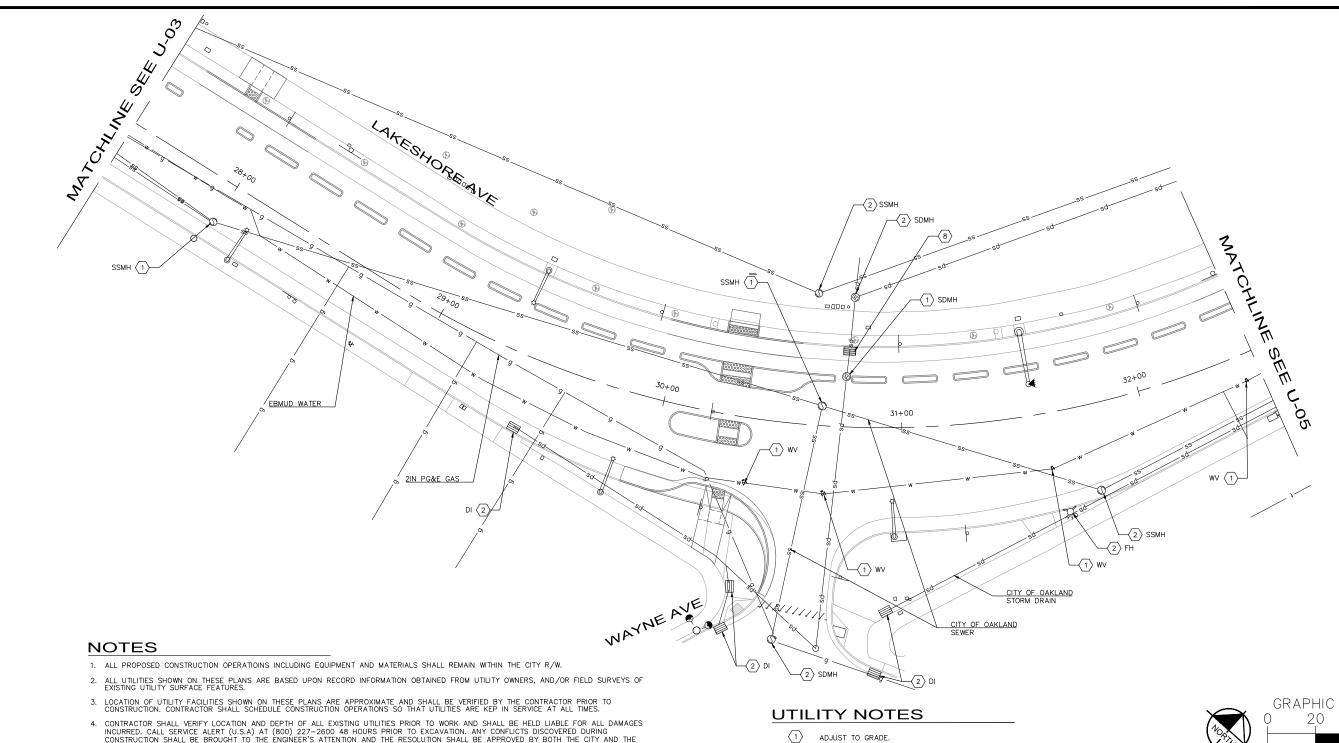- EXISTING TO REMAIN.
- REPLACE DRAINAGE INLET WITH HEEL PROOF AND ADA COMPLIANT GRATE.

PLAN PRODUCTION WARNING	
THE PLANS HAVE BEEN CREATED ON	
ANSI B (11" X 17") SHEETS. REFER TO	
GRAPHIC SCALE FOR SHEETS OF	
DIFFERENT SIZES.	

GRAPHIC SCALE IN FEET

Kimley»Horn

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CHECKED BY	RYAN DOLE, P.E.	
DESIGNED BY	IORGE MORALES	

TESSA KEMPER/PRIYA PALLIVATHUCAL DRAWN BY



PROJECT NO.

1007299

U - 04

CITY OF OAKLAND

100% SUBMITTAL NOT FOR BID OR CONSTRUCTION

> DEPARTMENT OF TRANSPORTATION 250 FRANK H. OGAWA PLAZA, SUITE 4314 OAKLAND, CA 94612 (510) 238-3437 FAX (510) 238-7227


LAKESHORE AVENUE SEPARATED BIKE LANES PROJECT FROM E 18TH STREET TO MACARTHUR BOULEVARD

	REFERENCE	BY	DATE	No.
DF				

RAINAGE AND UTILITY **PLANS** 

SHEET NO.

61 of 83

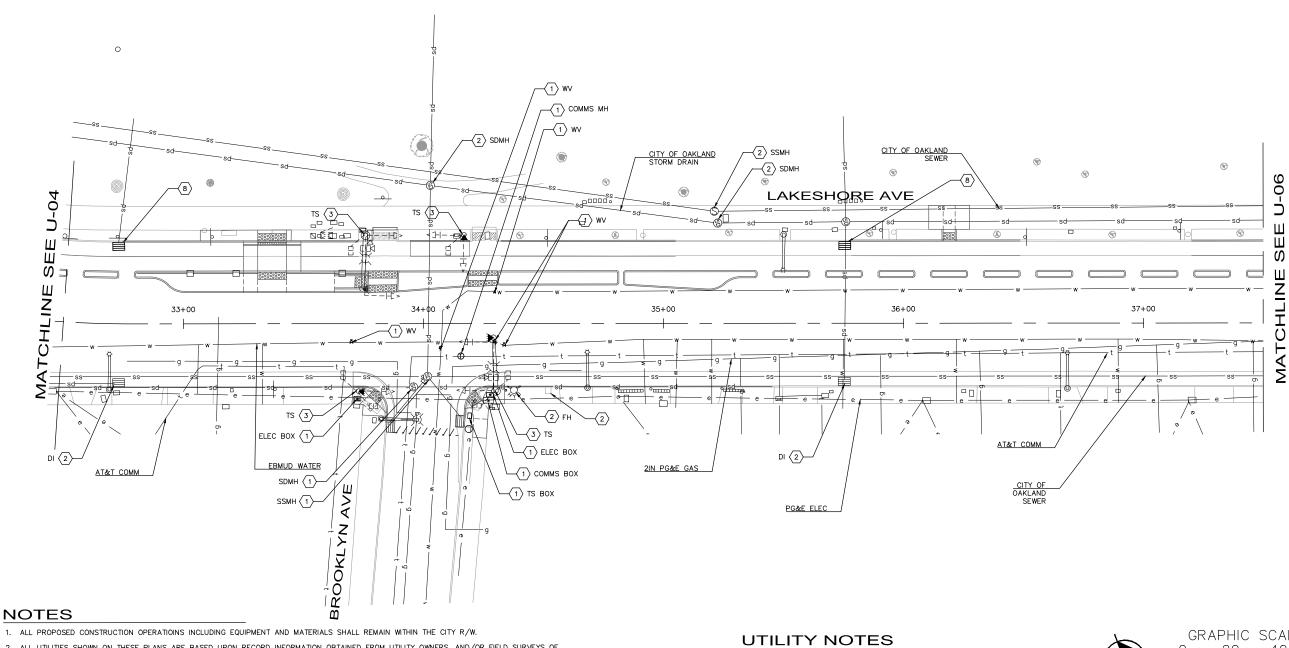

- 1. ALL PROPOSED CONSTRUCTION OPERATIONS INCLUDING EQUIPMENT AND MATERIALS SHALL REMAIN WITHIN THE CITY R/W.
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ADJUST TO GRADE.

EXISTING TO REMAIN.

PROTECT IN PLACE.

REPLACE DRAINAGE INLET GRATE WITH HEEL PROOF AND ADA COMPLIANT GRATE. PLAN PRODUCTION WARNING

ANSI B (11" X 17") SHEETS. REFER TO GRAPHIC SCALE FOR SHEETS OF DIFFERENT SIZES.

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GRAPHIC SCALE IN FEET 20

# **Kimley \*\*Horn**

DRAWN BY

Oakland, Cali	ifornia 94612	Fax No. (916)608-0885
CHECKED BY	RYAN	DOLE, P.E.
DESIGNED BY	' JORGE	MORALES



PROJECT NO.

1007299

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CONSTRUCTION

DEPARTMENT OF TRANSPORTATION 250 FRANK H. OGAWA PLAZA, SUITE 4314 OAKLAND, CA 94612 (510) 238-3437 FAX (510) 238-7227


LAKESHORE AVENUE SEPARATED BIKE LANES PROJECT FROM E 18TH STREET TO MACARTHUR BOULEVARD

	REFERENCE	BY	DATE	No.
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RAINAGE AND UTILITY **PLANS** 

TESSA KEMPER/PRIYA PALLIVATHUCAL

SHEET NO. 62 of 83

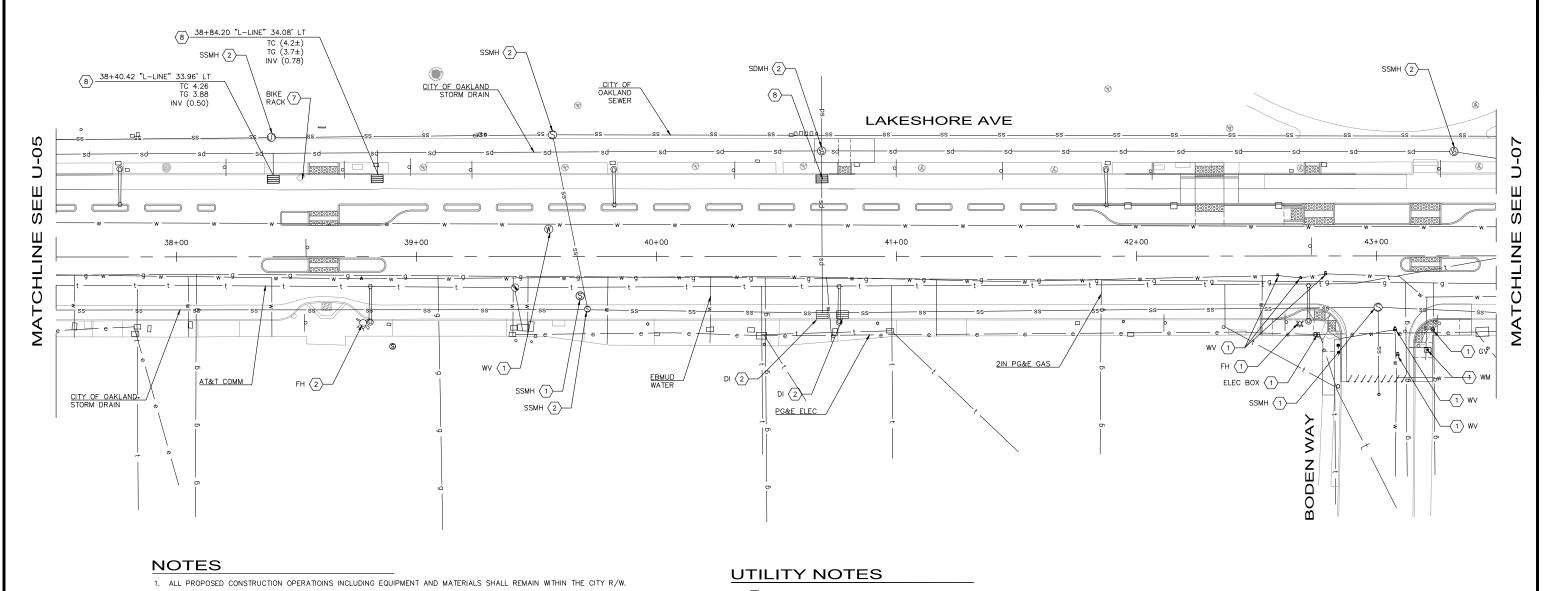

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- 1 ADJUST TO GRADE.
- EXISTING TO REMAIN.
- REMOVE AND RELOCATE. CONTRACTOR TO INSTALL AND COORDINATE FINAL LOCATION WITH ENGINEER.
- REPLACE DRAINAGE INLET GRATE WITH HEEL PROOF AND ADA COMPLIANT GRATE.



GRAPHIC SCALE IN FEET

Kimley» Horn

100 Cldy Street, Suite 900

Tel. No. (510)625-0712 © 2024

DRAWN BY

TESSA KEMPER/PRIYA PALLIVATHUCAL

PLAN PRODUCTION WARNING	Oakland, California	94612 Fax No. (916)608-0885
	CHECKED BY	RYAN DOLE, P.E.
ANSI B (11" X 17") SHEETS. REFER TO	DESIGNED BY	JORGE MORALES



PROJECT NO.

100% SUBMITTAL

NOT FOR BID OR CONSTRUCTION

# CITY OF OAKLAND

DEPARTMENT OF TRANSPORTATION 250 FRANK H. OGAWA PLAZA, SUITE 4314 OAKLAND, CA 94612 (510) 238-3437 FAX (510) 238-7227

LAKESHORE AVENUE SEPARATED BIKE LANES PROJECT FROM E 18TH STREET TO MACARTHUR BOULEVARD

	REFERENCE	BY	DATE	No.
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ANSI B (11" X 17") SHEETS. REFER TO GRAPHIC SCALE FOR SHEETS OF

DIFFERENT SIZES.

DRAINAGE AND UTILITY **PLANS** 

1007299

SHEET NO. U - 0663 OF 83

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### **UTILITY NOTES**

- 1 ADJUST TO GRADE.
- EXISTING TO REMAIN.
- REMOVE AND RELOCATE. CONTRACTOR TO INSTALL AND COORDINATE FINAL LOCATION WITH ENGINEER.
- REPLACE DRAINAGE INLET GRATE WITH HEEL PROOF AND ADA COMPLIANT GRATE.
- MODIFY STORM DRAIN INLET TO STORM DRAIN MAINTENANCE HOLE. SEE DETAIL F ON SHEET DD-02.

PLAN PRODUCTION WARNING THE PLANS HAVE BEEN CREATED ON ANSI B (11" X 17") SHEETS. REFER TO GRAPHIC SCALE FOR SHEETS OF DIFFERENT SIZES.



DRAWN BY

GRAPHIC SCALE IN FEET 20

# Kimley»Horn

Oakland, California		Fax No.	(916)608-0885	<b>Q</b> 1
CHECKED BY	RYAN D	OLE, P.E	Ē.	
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PROJECT NO.

1007299

U - 0764 of 83

REFERENCE DATE

LAKESHORE AVENUE SEPARATED BIKE LANES PROJECT

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100% SUBMITTAL


NOT FOR BID OR

CONSTRUCTION

# CITY OF OAKLAND

DEPARTMENT OF TRANSPORTATION 250 FRANK H. OGAWA PLAZA, SUITE 4314 OAKLAND, CA 94612 (510) 238-3437 FAX (510) 238-7227

FROM E 18TH STREET TO MACARTHUR BOULEVARD

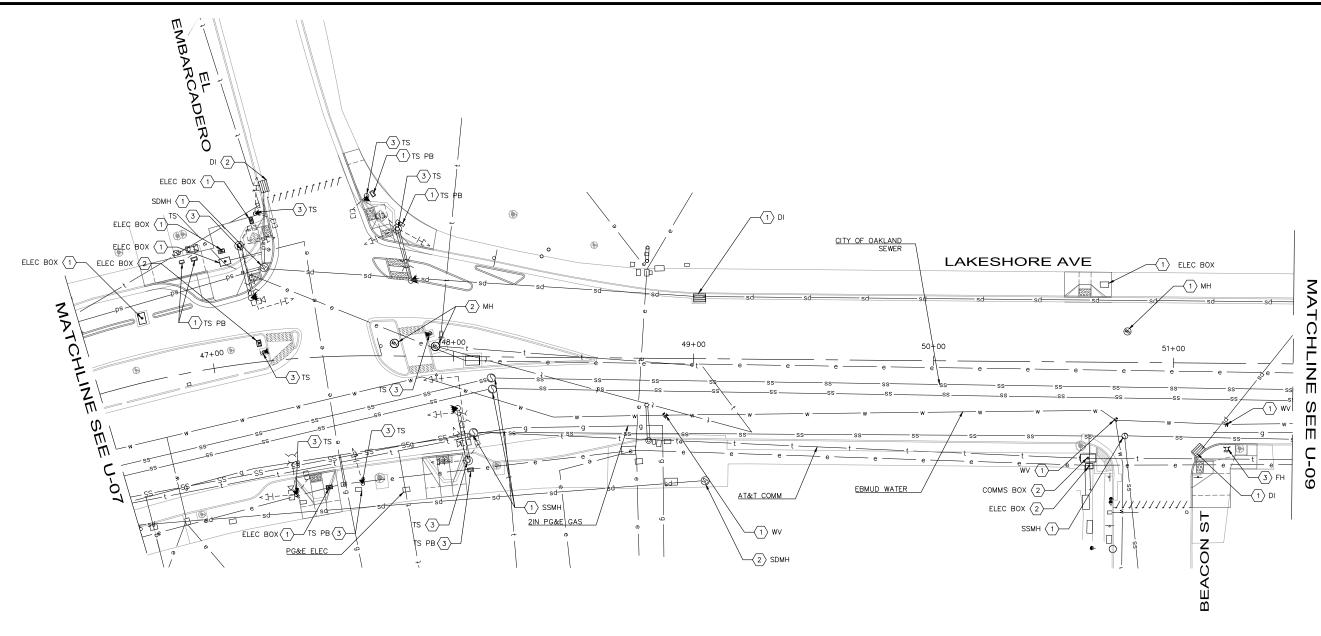

- 1. ALL PROPOSED CONSTRUCTION OPERATIONS INCLUDING EQUIPMENT AND MATERIALS SHALL REMAIN WITHIN THE CITY R/W.
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# **UTILITY NOTES**

ADJUST TO GRADE.

2 EXISTING TO REMAIN.

3 PROTECT IN PLACE.

PLAN PRODUCTION WARNING
THE PLANS HAVE BEEN CREATED ON ANSI B (11" X 17") SHEETS. REFER TO
ANSI B (11" X 17") SHEETS. REFER TO
GRAPHIC SCALE FOR SHEETS OF
DIFFERENT SIZES.



GRAPHIC SCALE IN FEET

# Kimley»Horn

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CHECKED I	ВҮ	RYAN	N DOLE, P.E.	
DESIGNED	RV	JORG	SE MORALES	

TESSA KEMPER/PRIYA PALLIVATHUCAL

PROJECT NO.

100% SUBMITTAL NOT FOR BID OR CONSTRUCTION

# CITY OF OAKLAND

DEPARTMENT OF TRANSPORTATION 250 FRANK H. OGAWA PLAZA, SUITE 4314 OAKLAND, CA 94612 (510) 238-3437 FAX (510) 238-7227


LAKESHORE AVENUE SEPARATED BIKE LANES PROJECT FROM E 18TH STREET TO MACARTHUR BOULEVARD

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# RAINAGE AND UTILITY **PLANS**

1007299

SHEET NO. U-08 65 <sub>OF</sub> 83

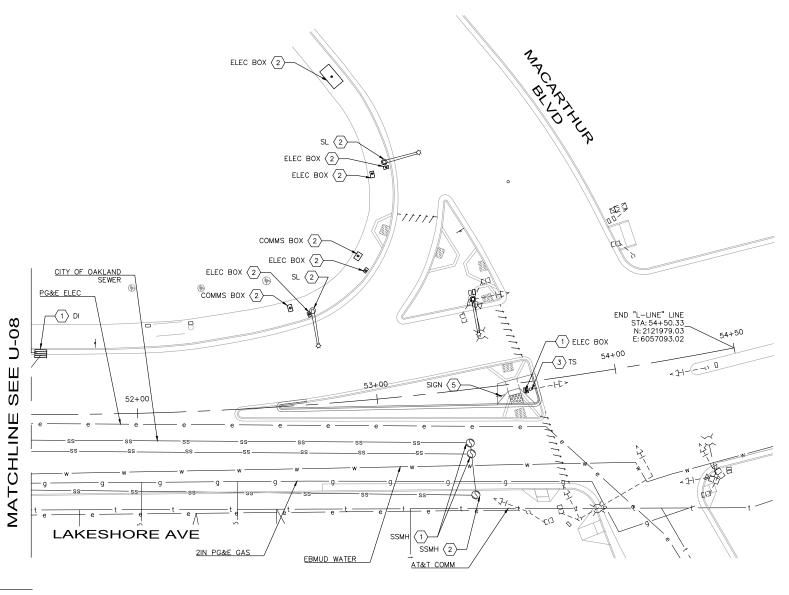

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#### **UTILITY NOTES**

- ADJUST TO GRADE.
- 2 EXISTING TO REMAIN.
- PROTECT IN PLACE.
- REMOVE AND RESET SIGN AND POST. SEE SS SHEETS FOR MORE DETAILS.

PLAN PRODUCTION WARNING THE PLANS HAVE BEEN CREATED ON ANSI B (11" X 17") SHEETS. REFER TO GRAPHIC SCALE FOR SHEETS OF DIFFERENT SIZES.



GRAPHIC SCALE IN FEET

# **Kimley \*\*Horn**

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	CHECKED BY	RYAN DOLE, P.E.
l	DESIGNED BY	IORGE MORALES

TESSA KEMPER/PRIYA PALLIVATHUCAL DRAWN BY



PROJECT NO.

1007299

SHEET NO. U - 09

CITY OF OAKLAND

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NOT FOR BID OR

CONSTRUCTION


DEPARTMENT OF TRANSPORTATION 250 FRANK H. OGAWA PLAZA, SUITE 4314 OAKLAND, CA 94612 (510) 238-3437 FAX (510) 238-7227

LAKESHORE AVENUE SEPARATED BIKE LANES PROJECT FROM E 18TH STREET TO MACARTHUR BOULEVARD


	REFERENCE	BY	DATE	No.
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RAINAGE AND UTILITY **PLANS** 

66 <sub>OF</sub> 83

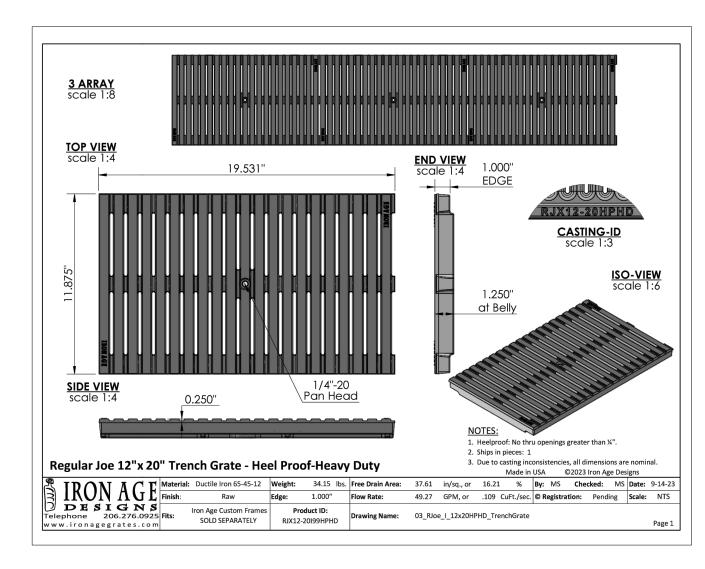

**DETAIL A:** TRENCH GRATE DETAIL

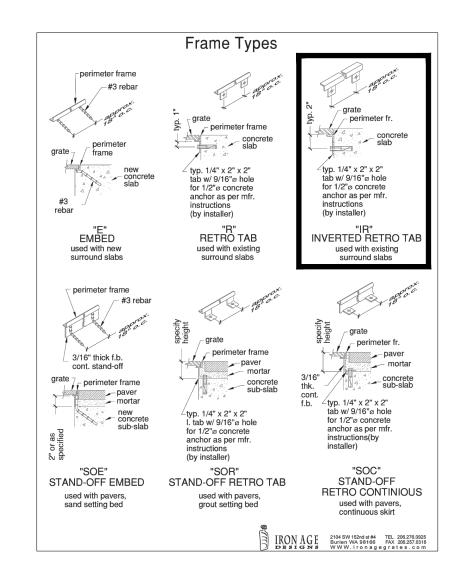

#### **DETAIL B:** TRENCH GRATE FRAME DETAIL

PLAN PRODUCTION WARNING

THE PLANS HAVE BEEN CREATED ON

ANSI B (11" X 17") SHEETS, REFER TO

GRAPHIC SCALE FOR SHEETS OF

DIFFERENT SIZES.

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LAKESHORE AVENUE SEPARATED BIKE LANES PROJECT FROM E 18TH STREET TO MACARTHUR BOULEVARD

No.	DATE	BY	REFERENCE

# **Kimley** »Horn

CHECKED BY RYAN DOLE, P.E. JORGE MORALES DESIGNED BY TESSA KEMPER/PRIYA PALLIVATHUCAL DRAWN BY




PROJECT NO.


DRAINAGE DETAILS


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SCALE: NTS

SHEET NO. 67 of 83



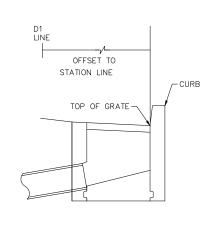


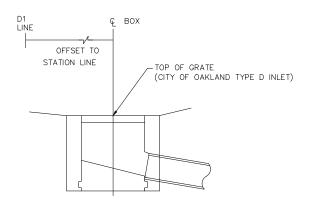


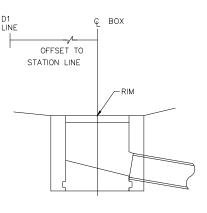


**SECTION B-B** FIELD DRAINAGE INLET STATION AND OFFSET DETAIL

**SECTION C-C** MANHOLE STATION AND OFFSET DETAIL NTS

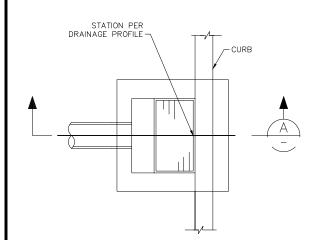

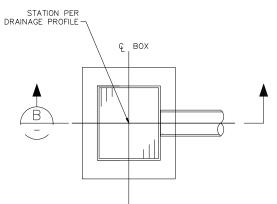

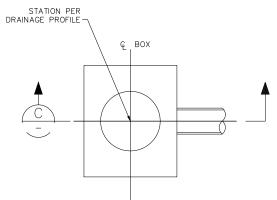



CITY OF OAKLAND TYPE "D" INLET B NOT TO SCALE

MAINTENANCE HOLE NOT TO SCALE

DETAIL A: DRAINAGE STRUCTURES AND OFFSET DETAIL NTS

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3'-0" TO 4'-0" PLAN

# **Kimley** »Horn CHECKED BY RYAN DOLE, P.E. JORGE MORALES DESIGNED BY

TESSA KEMPER/PRIYA PALLIVATHUCAL

EXIST FRAME AND COVER

NOT TO SCALE

REMOVE MIN 12" EXIST CATCH BASIN

REMOVE EXIST— CONE RINGS, FRAME AND COVER

INVERT IN

SECTION A-A

ADJUST MH COVER TO GRADE (E)

WATERTIGHT KEYWAY

ADJUSTMENT RINGS AND RISERS AS NECESSARY WATERTIGHT KEYWAY-

 $\bigcirc$ 

-#6 BARS (TOP AND BOTTOM)

MODIFY INLET TO MAINTENANCE HOLE F



-RESET EXIST CONE SECTION

FIELD VERIFY

MORTAR ALL AROUND

SEE DETAIL D ON THIS SHEET

INSTALL AND EPOXY

#4 DOWELS © 6"

(5" EMBEDMENT)
OR SAVE EXISTING
REBAR (12" MIN)
& SPLICE TO NEW
REBAR

EXIST PIPE

-EXIST CONE SECTION

\_EXIST MH

CITY OF OAKLAND

DEPARTMENT OF TRANSPORTATION 250 FRANK H. OGAWA PLAZA. SUITE 4314 OAKLAND, CA 94612 (510) 238-3437 FAX (510) 238-7227

LAKESHORE AVENUE SEPARATED BIKE LANES PROJECT FROM E 18TH STREET TO MACARTHUR BOULEVARD

No.	DATE	BY	REFERENCE

**REBAR DETAILS** 

NOT TO SCALE

NOT TO SCALE


DRAINAGE DETAILS

DRAWN BY

PROJECT NO. 1007299

SCALE:

SHEET NO. DD-02 68 <sub>OF</sub> 83

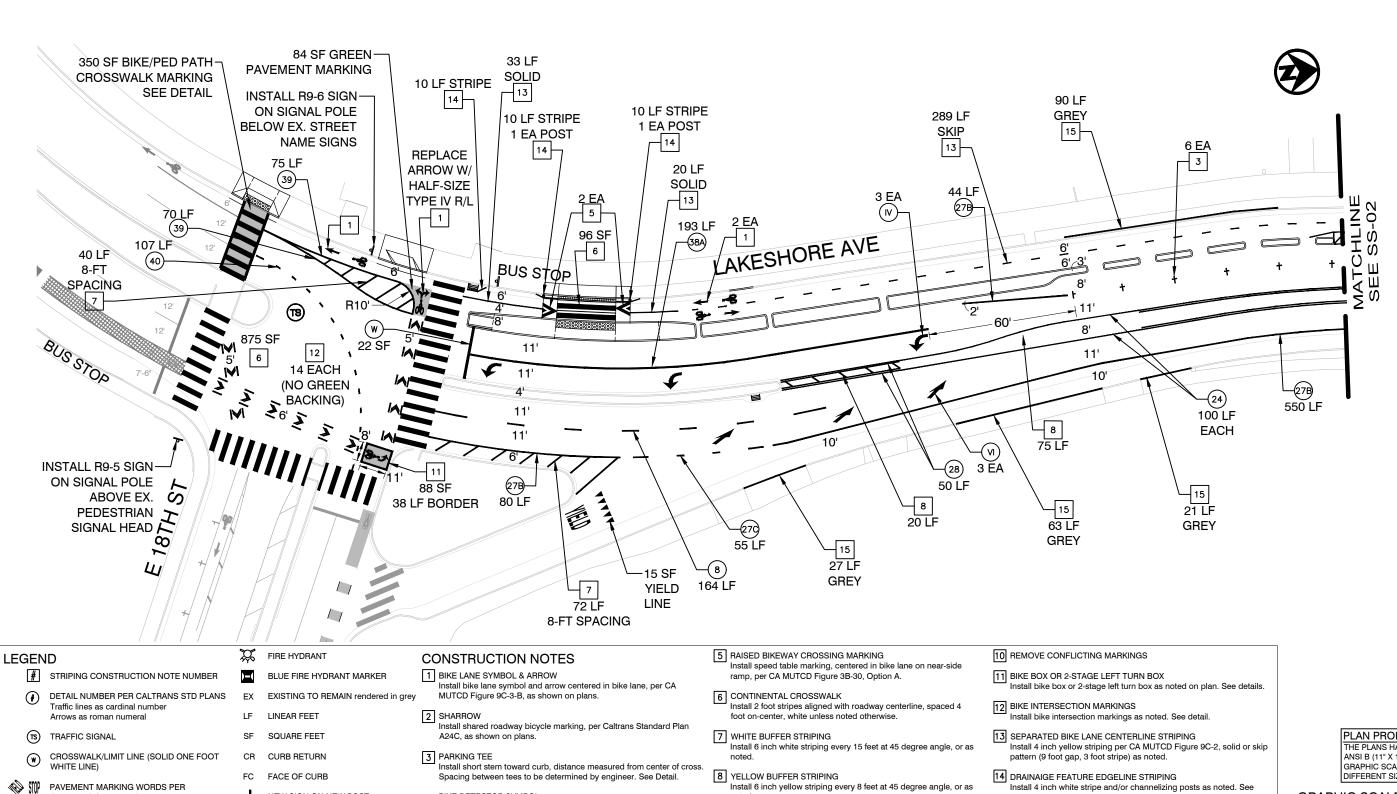

# CITY OF OAKLAND

CALTRANS STD PLANS as shown

EXISTING SIGN ON EXISTING POST

DEPARTMENT OF TRANSPORTATION 250 FRANK H. OGAWA PLAZA, SUITE 4314 OAKLAND, CA 94612 (510) 238-3437 FAX (510) 238-7227

LAKESHORE AVENUE SEPARATED **BIKE LANES PROJECT** FROM E 18TH STREET TO MACARTHUR BLVD

BIKE DETECTOR SYMBOL

4 Install bike detector pavement marking, per CA MUTCD Figure 9C-7,1

foot back from limit line and centered in lane, or as noted.

NEW SIGN ON NEW POST

NEW SIGN ON EXISTING POST



DATE REFERENCE CHECKED BY JASON PATTON DESIGNED BY DRAWN BY DEP

Install 6 inch yellow striping every 8 feet at 45 degree angle, or as

9 REMOVE CONFLICTING STRIPING

14 DRAINAIGE FEATURE EDGELINE STRIPING Install 4 inch white stripe and/or channelizing posts as noted. See

15 CURB PAINT Install curb paint. Color as noted. PLAN PRODUCTION WARNING THE PLANS HAVE BEEN CREATED ON ANSI B (11" X 17") SHEETS. REFER TO

GRAPHIC SCALE FOR SHEETS OF DIFFERENT SIZES.


**GRAPHIC SCALE (IN FEET)** 

SIGNAGE AND STRIPING PLANS

PROJECT NO. 1007299

SCALE:

SS-01  $\underline{69}_{\text{OF}}\,\underline{83}$ 

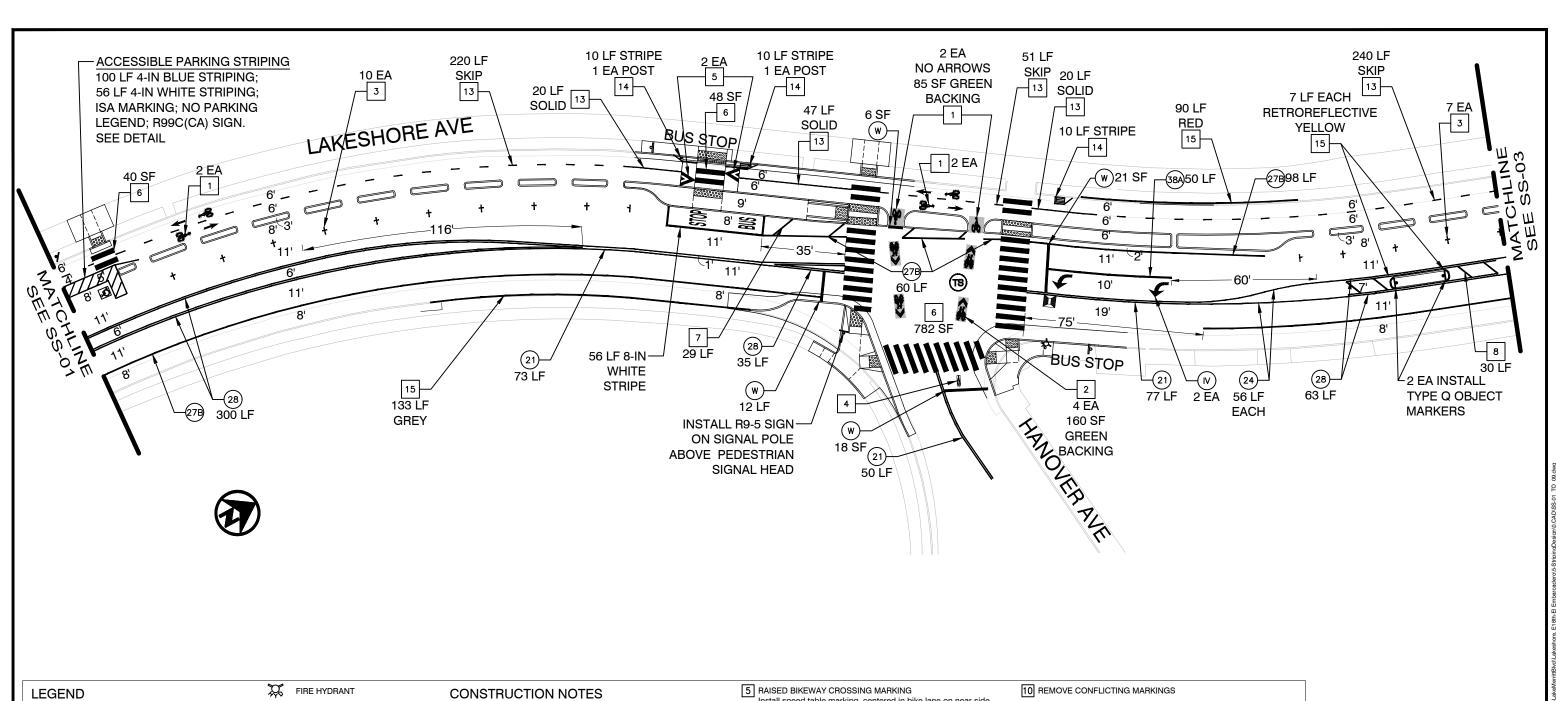

- # STRIPING CONSTRUCTION NOTE NUMBER
- DETAIL NUMBER PER CALTRANS STD PLANS Traffic lines as cardinal number Arrows as roman numeral
- (TS) TRAFFIC SIGNAL
- CROSSWALK/LIMIT LINE (SOLID ONE FOOT WHITE LINE)
- PAVEMENT MARKING WORDS PER

CALTRANS STD PLANS as shown

EXISTING SIGN ON EXISTING POST

- BLUE FIRE HYDRANT MARKER
- EXISTING TO REMAIN rendered in grey
- LINEAR FEET
- SQUARE FEET
- CURB RETURN
- FACE OF CURB
- NEW SIGN ON NEW POST
- NEW SIGN ON EXISTING POST

- 1 BIKE LANE SYMBOL & ARROW Install bike lane symbol and arrow centered in bike lane, per CA MUTCD Figure 9C-3-B, as shown on plans.
- 2 SHARROW Install shared roadway bicycle marking, per Caltrans Standard Plan A24C, as shown on plans.
- Install short stem toward curb, distance measured from center of cross Spacing between tees to be determined by engineer. See Detail.
- BIKE DETECTOR SYMBOL
- 4 Install bike detector pavement marking, per CA MUTCD Figure 9C-7,1 foot back from limit line and centered in lane, or as noted.

- Install speed table marking, centered in bike lane on near-side ramp, per CA MUTCD Figure 3B-30, Option A.
- 6 CONTINENTAL CROSSWALK Install 2 foot stripes aligned with roadway centerline, spaced 4 foot on-center, white unless noted otherwise.
- 7 WHITE BUFFER STRIPING Install 6 inch white striping every 15 feet at 45 degree angle, or as
- 8 YELLOW BUFFER STRIPING Install 6 inch yellow striping every 8 feet at 45 degree angle, or as
- 9 REMOVE CONFLICTING STRIPING

- 11 BIKE BOX OR 2-STAGE LEFT TURN BOX Install bike box or 2-stage left turn box as noted on plan. See details.
- 12 BIKE INTERSECTION MARKINGS Install bike intersection markings as noted. See detail.
- 13 SEPARATED BIKE LANE CENTERLINE STRIPING Install 4 inch yellow striping per CA MUTCD Figure 9C-2, solid or skip
- pattern (9 foot gap, 3 foot stripe) as noted. 14 DRAINAIGE FEATURE EDGELINE STRIPING Install 4 inch white stripe and/or channelizing posts as noted. See
- 15 CURB PAINT Install curb paint. Color as noted.

PLAN PRODUCTION WARNING THE PLANS HAVE BEEN CREATED ON

ANSI B (11" X 17") SHEETS. REFER TO GRAPHIC SCALE FOR SHEETS OF DIFFERENT SIZES.

**GRAPHIC SCALE (IN FEET)** 



# CITY OF OAKLAND

DEPARTMENT OF TRANSPORTATION 250 FRANK H. OGAWA PLAZA, SUITE 4314 OAKLAND, CA 94612 (510) 238-3437 FAX (510) 238-7227

LAKESHORE AVENUE SEPARATED **BIKE LANES PROJECT** FROM E 18TH STREET TO MACARTHUR BLVD




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SIGNAGE AND STRIPING PLANS

PROJECT NO. 1007299

SCALE:

SHEET NO. SS-02 70 of 83



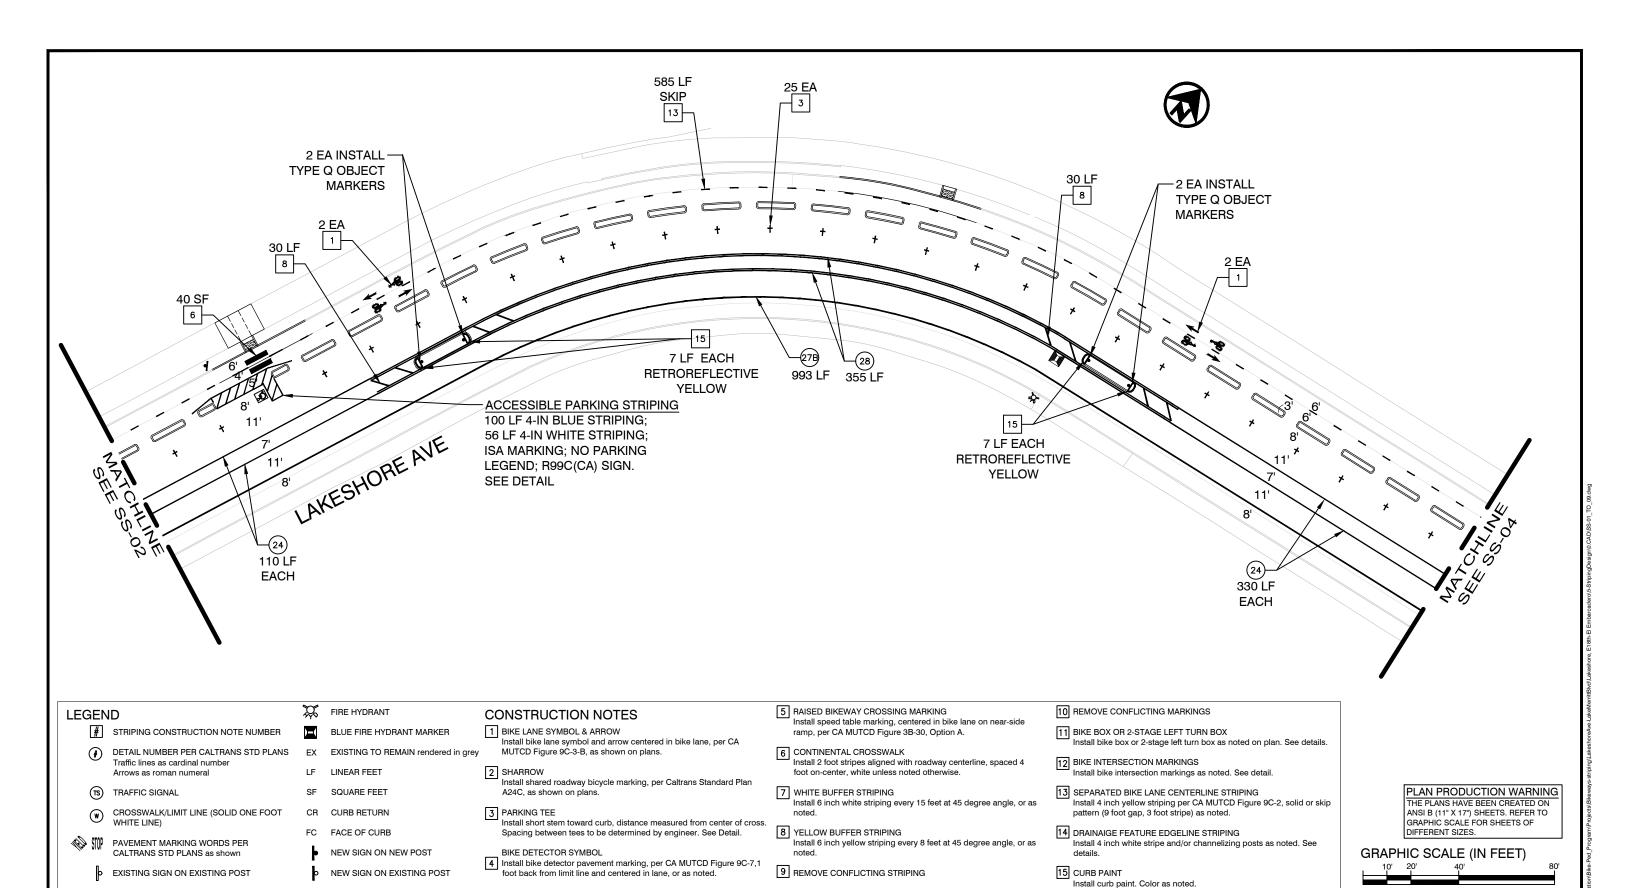

# CITY OF OAKLAND

DEPARTMENT OF TRANSPORTATION 250 FRANK H. OGAWA PLAZA, SUITE 4314 OAKLAND, CA 94612 (510) 238-3437 FAX (510) 238-7227

LAKESHORE AVENUE SEPARATED **BIKE LANES PROJECT** FROM E 18TH STREET TO MACARTHUR BLVD




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SIGNAGE AND STRIPING PLANS PROJECT NO.

SCALE:

71 of 83

SHEET NO. SS - 03

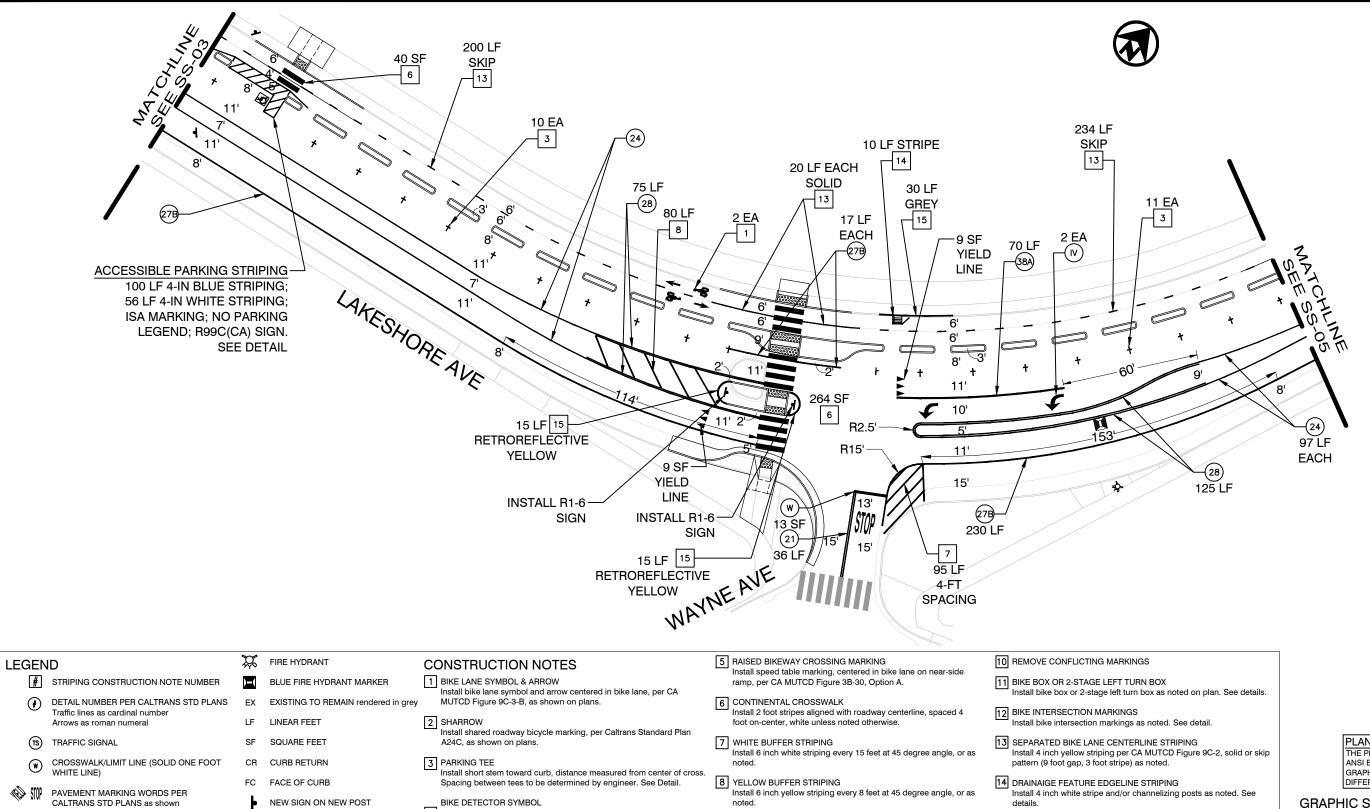

# CITY OF OAKLAND

EXISTING SIGN ON EXISTING POST

DEPARTMENT OF TRANSPORTATION 250 FRANK H. OGAWA PLAZA, SUITE 4314 OAKLAND, CA 94612 (510) 238-3437 FAX (510) 238-7227

LAKESHORE AVENUE SEPARATED **BIKE LANES PROJECT** FROM E 18TH STREET TO MACARTHUR BLVD

NEW SIGN ON EXISTING POST



4 Install bike detector pavement marking, per CA MUTCD Figure 9C-7,1

foot back from limit line and centered in lane, or as noted.

DATE REFERENCE CHECKED BY JASON PATTON DESIGNED BY DRAWN BY DEP

9 REMOVE CONFLICTING STRIPING

15 CURB PAINT Install curb paint. Color as noted. PLAN PRODUCTION WARNING THE PLANS HAVE BEEN CREATED ON ANSI B (11" X 17") SHEETS. REFER TO


GRAPHIC SCALE FOR SHEETS OF DIFFERENT SIZES. **GRAPHIC SCALE (IN FEET)** 

SIGNAGE AND STRIPING PLANS PROJECT NO.

SCALE: SHEET NO.

SS-04 72 of 83



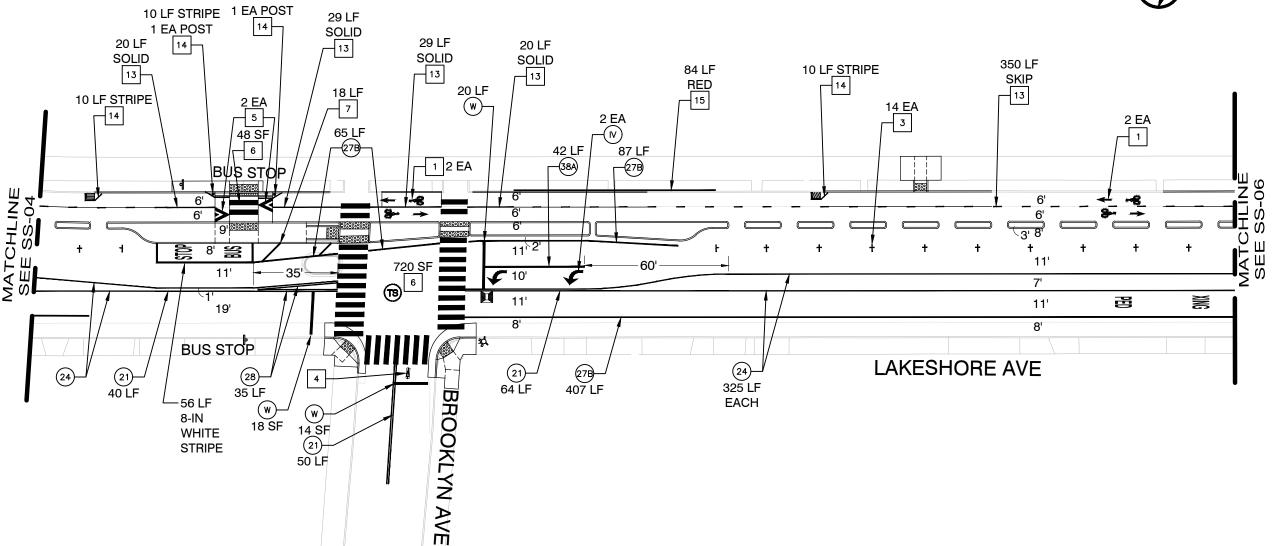

#### **LEGEND**

# STRIPING CONSTRUCTION NOTE NUMBER

DETAIL NUMBER PER CALTRANS STD PLANS Traffic lines as cardinal number Arrows as roman numeral

TS TRAFFIC SIGNAL

CROSSWALK/LIMIT LINE (SOLID ONE FOOT WHITE LINE)

PAVEMENT MARKING WORDS PER CALTRANS STD PLANS as shown

EXISTING SIGN ON EXISTING POST

FIRE HYDRANT

BLUE FIRE HYDRANT MARKER

EXISTING TO REMAIN rendered in grey

LINEAR FEET

SQUARE FEET

CURB RETURN

FACE OF CURB

NEW SIGN ON NEW POST

NEW SIGN ON EXISTING POST

**CONSTRUCTION NOTES** 

10 LF STRIPE

1 BIKE LANE SYMBOL & ARROW Install bike lane symbol and arrow centered in bike lane, per CA MUTCD Figure 9C-3-B, as shown on plans.

50 LF

2 SHARROW Install shared roadway bicycle marking, per Caltrans Standard Plan

A24C, as shown on plans.

Install short stem toward curb, distance measured from center of cross. Spacing between tees to be determined by engineer. See Detail.

BIKE DETECTOR SYMBOL

4 Install bike detector pavement marking, per CA MUTCD Figure 9C-7,1 foot back from limit line and centered in lane, or as noted.

5 RAISED BIKEWAY CROSSING MARKING Install speed table marking, centered in bike lane on near-side

ramp, per CA MUTCD Figure 3B-30, Option A.

6 CONTINENTAL CROSSWALK

Install 2 foot stripes aligned with roadway centerline, spaced 4 foot on-center, white unless noted otherwise.

7 WHITE BUFFER STRIPING

Install 6 inch white striping every 15 feet at 45 degree angle, or as

8 YELLOW BUFFER STRIPING Install 6 inch yellow striping every 8 feet at 45 degree angle, or as

9 REMOVE CONFLICTING STRIPING

10 REMOVE CONFLICTING MARKINGS

11 BIKE BOX OR 2-STAGE LEFT TURN BOX Install bike box or 2-stage left turn box as noted on plan. See details.

12 BIKE INTERSECTION MARKINGS Install bike intersection markings as noted. See detail.

pattern (9 foot gap, 3 foot stripe) as noted.

13 SEPARATED BIKE LANE CENTERLINE STRIPING Install 4 inch yellow striping per CA MUTCD Figure 9C-2, solid or skip

14 DRAINAIGE FEATURE EDGELINE STRIPING Install 4 inch white stripe and/or channelizing posts as noted. See

15 CURB PAINT Install curb paint. Color as noted. PLAN PRODUCTION WARNING THE PLANS HAVE BEEN CREATED ON

ANSI B (11" X 17") SHEETS. REFER TO GRAPHIC SCALE FOR SHEETS OF DIFFERENT SIZES.

**GRAPHIC SCALE (IN FEET)** 



CITY OF OAKLAND

DEPARTMENT OF TRANSPORTATION 250 FRANK H. OGAWA PLAZA, SUITE 4314 OAKLAND, CA 94612 (510) 238-3437 FAX (510) 238-7227

LAKESHORE AVENUE SEPARATED **BIKE LANES PROJECT** FROM E 18TH STREET TO MACARTHUR BLVD


STRIPE



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SIGNAGE AND STRIPING PLANS PROJECT NO.

SHEET NO. SS-05 73 of 83

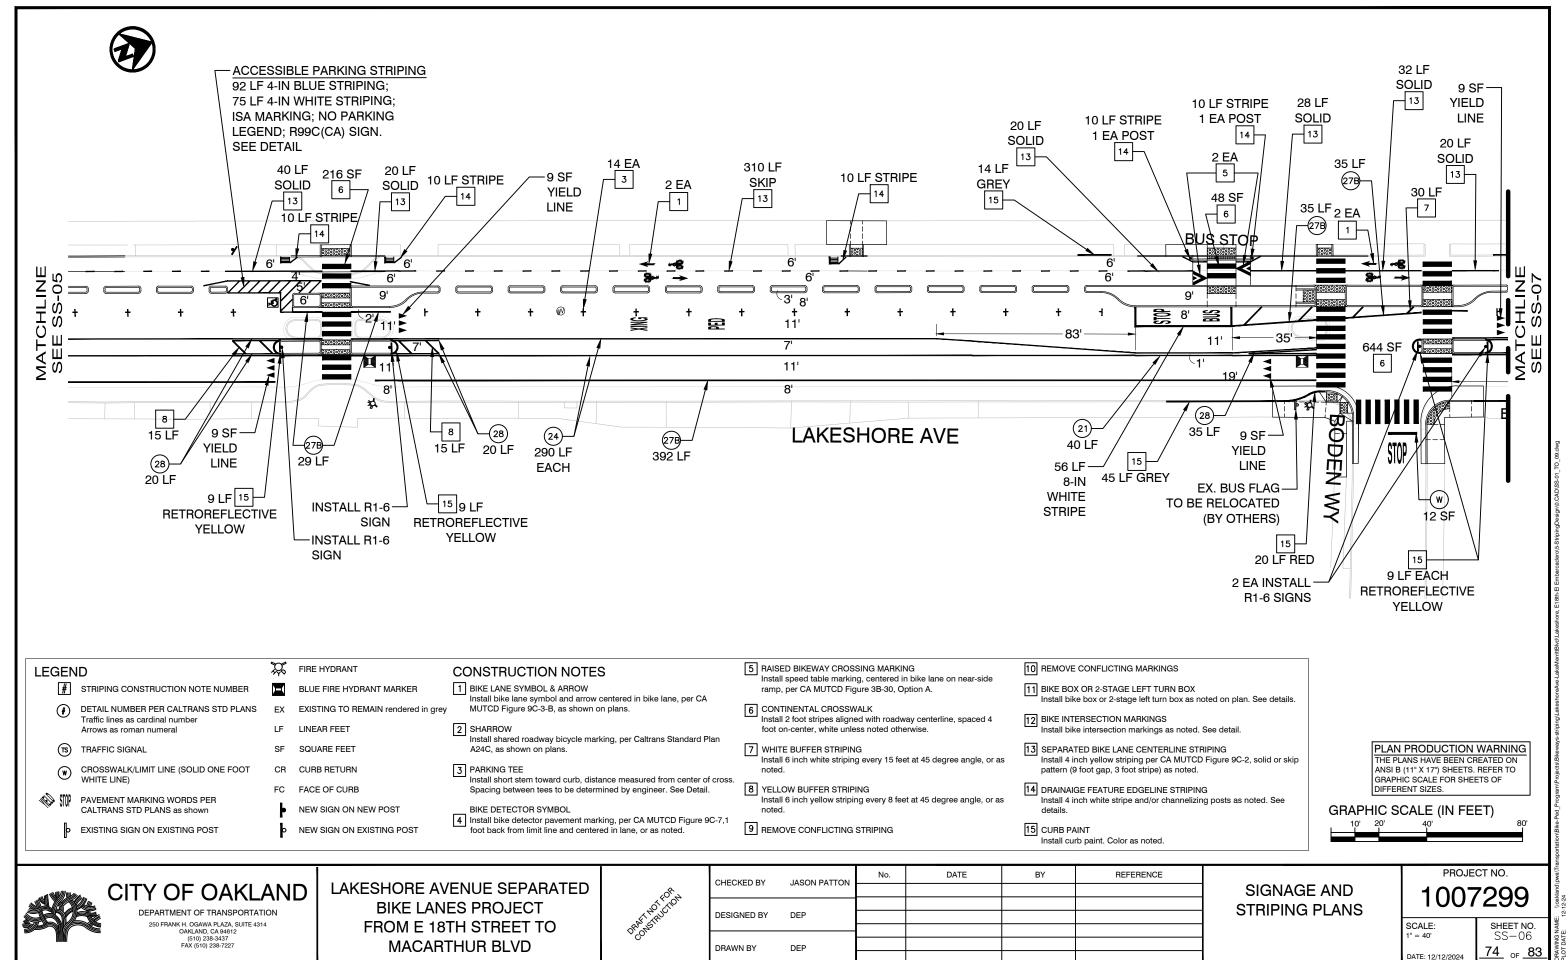

DRAWING NAME: \\oake PLOT DATE: 12-12-24 PLOTTED BY: pene9d



- # STRIPING CONSTRUCTION NOTE NUMBER
- DETAIL NUMBER PER CALTRANS STD PLANS Traffic lines as cardinal number Arrows as roman numeral
- TS TRAFFIC SIGNAL
- CROSSWALK/LIMIT LINE (SOLID ONE FOOT WHITE LINE)



PAVEMENT MARKING WORDS PER CALTRANS STD PLANS as shown

EXISTING SIGN ON EXISTING POST

FIRE HYDRANT

BLUE FIRE HYDRANT MARKER

EXISTING TO REMAIN rendered in grey

LINEAR FEET

SQUARE FEET

CURB RETURN

FACE OF CURB

NEW SIGN ON NEW POST

NEW SIGN ON EXISTING POST

**CONSTRUCTION NOTES** 1 BIKE LANE SYMBOL & ARROW

Install bike lane symbol and arrow centered in bike lane, per CA MUTCD Figure 9C-3-B, as shown on plans.

2 SHARROW

Install shared roadway bicycle marking, per Caltrans Standard Plan A24C, as shown on plans.

Install short stem toward curb, distance measured from center of cross. Spacing between tees to be determined by engineer. See Detail.

BIKE DETECTOR SYMBOL

4 Install bike detector pavement marking, per CA MUTCD Figure 9C-7,1 foot back from limit line and centered in lane, or as noted.

5 RAISED BIKEWAY CROSSING MARKING

Install speed table marking, centered in bike lane on near-side ramp, per CA MUTCD Figure 3B-30, Option A.

6 CONTINENTAL CROSSWALK

Install 2 foot stripes aligned with roadway centerline, spaced 4 foot on-center, white unless noted otherwise.

7 WHITE BUFFER STRIPING

Install 6 inch white striping every 15 feet at 45 degree angle, or as

8 YELLOW BUFFER STRIPING Install 6 inch yellow striping every 8 feet at 45 degree angle, or as

9 REMOVE CONFLICTING STRIPING

- 10 REMOVE CONFLICTING MARKINGS
- 11 BIKE BOX OR 2-STAGE LEFT TURN BOX Install bike box or 2-stage left turn box as noted on plan. See details.
- 12 BIKE INTERSECTION MARKINGS Install bike intersection markings as noted. See detail.
- 13 SEPARATED BIKE LANE CENTERLINE STRIPING Install 4 inch yellow striping per CA MUTCD Figure 9C-2, solid or skip pattern (9 foot gap, 3 foot stripe) as noted.
- 14 DRAINAIGE FEATURE EDGELINE STRIPING Install 4 inch white stripe and/or channelizing posts as noted. See
- 15 CURB PAINT Install curb paint. Color as noted.

PLAN PRODUCTION WARNING THE PLANS HAVE BEEN CREATED ON

ANSI B (11" X 17") SHEETS. REFER TO GRAPHIC SCALE FOR SHEETS OF DIFFERENT SIZES.

**GRAPHIC SCALE (IN FEET)** 



# CITY OF OAKLAND

DEPARTMENT OF TRANSPORTATION 250 FRANK H. OGAWA PLAZA, SUITE 4314 OAKLAND, CA 94612 (510) 238-3437 FAX (510) 238-7227

LAKESHORE AVENUE SEPARATED **BIKE LANES PROJECT** FROM E 18TH STREET TO MACARTHUR BLVD




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SIGNAGE AND STRIPING PLANS PROJECT NO.

SCALE:

SHEET NO. SS-07 75 OF 83

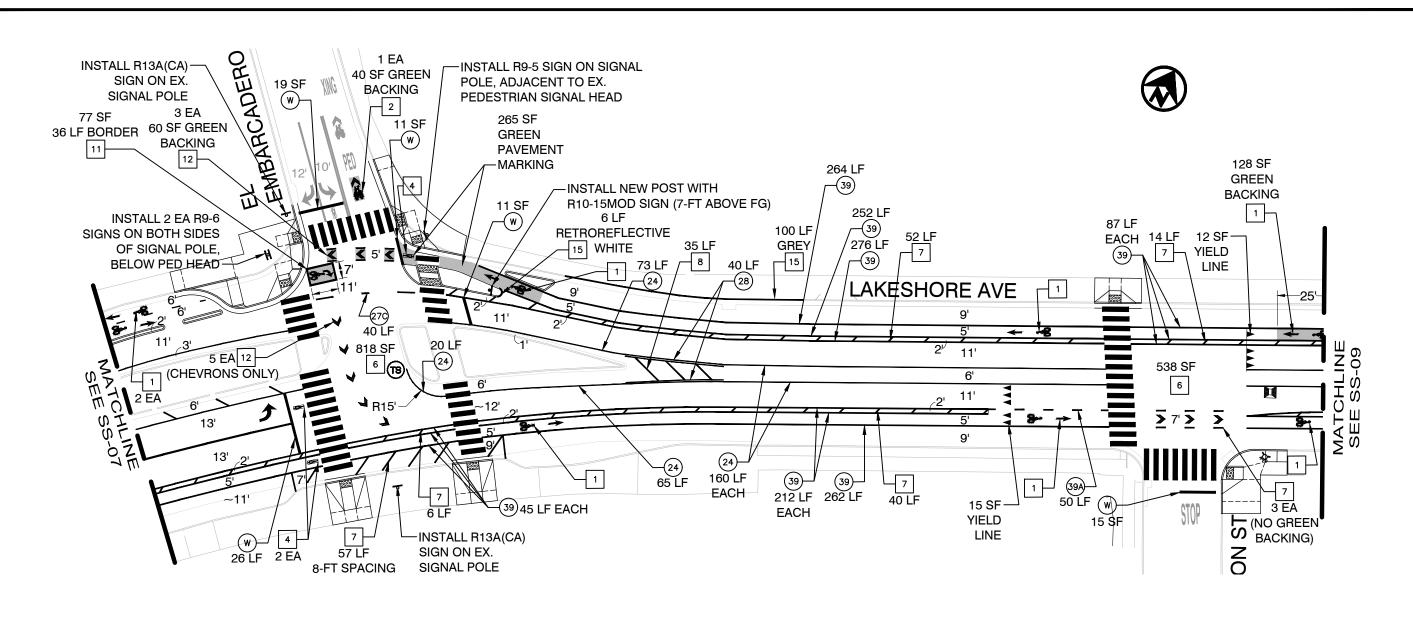

LEGEND

# STRIPING CONSTRUCTION NOTE NUMBER

DETAIL NUMBER PER CALTRANS STD PLANS Traffic lines as cardinal number Arrows as roman numeral

TS TRAFFIC SIGNAL

CROSSWALK/LIMIT LINE (SOLID ONE FOOT WHITE LINE)

PAVEMENT MARKING WORDS PER CALTRANS STD PLANS as shown

EXISTING SIGN ON EXISTING POST

FIRE HYDRANT

BLUE FIRE HYDRANT MARKER

EXISTING TO REMAIN rendered in grey

LINEAR FEET

SQUARE FEET

CURB RETURN

FACE OF CURB

NEW SIGN ON NEW POST

NEW SIGN ON EXISTING POST

**CONSTRUCTION NOTES** 

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Install short stem toward curb, distance measured from center of cross Spacing between tees to be determined by engineer. See Detail.

**BIKE DETECTOR SYMBOL** 4 Install bike detector pavement marking, per CA MUTCD Figure 9C-7,1 foot back from limit line and centered in lane, or as noted.

5 RAISED BIKEWAY CROSSING MARKING Install speed table marking, centered in bike lane on near-side

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GRAPHIC SCALE FOR SHEETS OF DIFFERENT SIZES.

**GRAPHIC SCALE (IN FEET)** 



CITY OF OAKLAND

DEPARTMENT OF TRANSPORTATION 250 FRANK H. OGAWA PLAZA, SUITE 4314 OAKLAND, CA 94612 (510) 238-3437 FAX (510) 238-7227

LAKESHORE AVENUE SEPARATED **BIKE LANES PROJECT** FROM E 18TH STREET TO MACARTHUR BLVD



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SIGNAGE AND STRIPING PLANS PROJECT NO.

SCALE:

SHEET NO. SS-08 76<sub>OF</sub> 83



- # STRIPING CONSTRUCTION NOTE NUMBER
- DETAIL NUMBER PER CALTRANS STD PLANS Traffic lines as cardinal number Arrows as roman numeral
- TS TRAFFIC SIGNAL
- CROSSWALK/LIMIT LINE (SOLID ONE FOOT WHITE LINE)



PAVEMENT MARKING WORDS PER CALTRANS STD PLANS as shown

EXISTING SIGN ON EXISTING POST

FIRE HYDRANT

BLUE FIRE HYDRANT MARKER

EXISTING TO REMAIN rendered in grey

LINEAR FEET

SQUARE FEET

CURB RETURN

FACE OF CURB

NEW SIGN ON NEW POST

NEW SIGN ON EXISTING POST

#### **CONSTRUCTION NOTES**

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- Install short stem toward curb, distance measured from center of cross. Spacing between tees to be determined by engineer. See Detail.
- BIKE DETECTOR SYMBOL
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PLAN PRODUCTION WARNING THE PLANS HAVE BEEN CREATED ON

ANSI B (11" X 17") SHEETS. REFER TO GRAPHIC SCALE FOR SHEETS OF DIFFERENT SIZES.

**GRAPHIC SCALE (IN FEET)** 



# CITY OF OAKLAND

DEPARTMENT OF TRANSPORTATION 250 FRANK H. OGAWA PLAZA, SUITE 4314 OAKLAND, CA 94612 (510) 238-3437 FAX (510) 238-7227

LAKESHORE AVENUE SEPARATED **BIKE LANES PROJECT** FROM E 18TH STREET TO MACARTHUR BLVD





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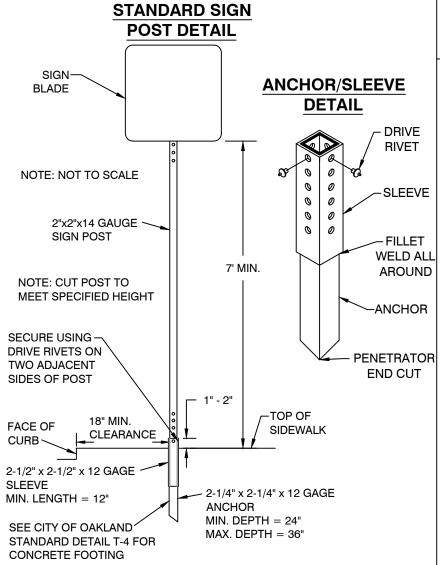
SIGNAGE AND STRIPING PLANS PROJECT NO.


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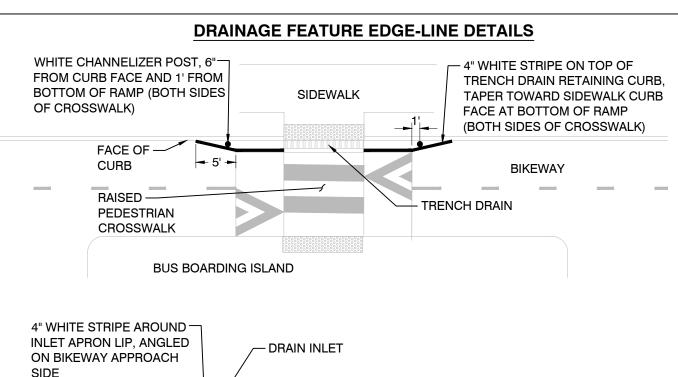
SHEET NO. SS-09 77 of 83





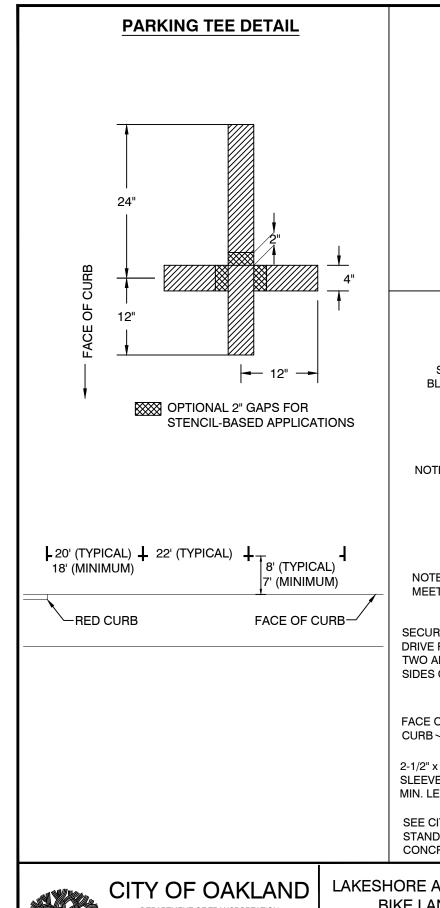

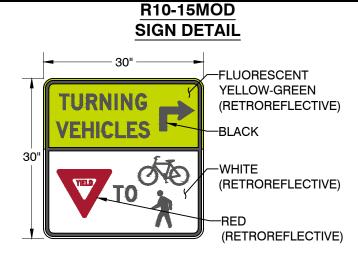

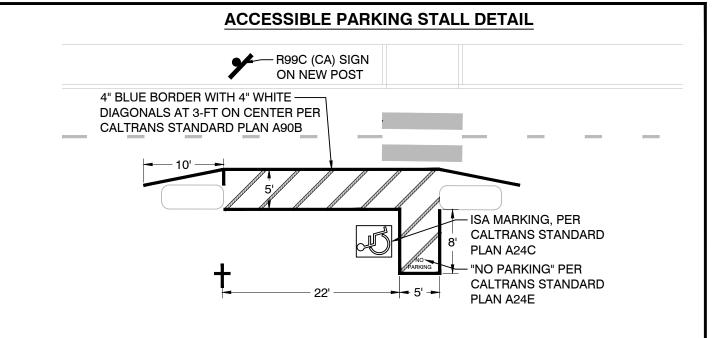



LAKESHORE AVENUE SEPARATED **BIKE LANES PROJECT** FROM E 18TH STREET TO MACARTHUR BLVD



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**BIKEWAY** 

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**CURB** 

SIGNAGE AND STRIPING DETAILS

PROJECT NO. 1007299


PLAN PRODUCTION WARNING

THE PLANS HAVE BEEN CREATED ON

ANSI B (11" X 17") SHEETS. REFER TO GRAPHIC SCALE FOR SHEETS OF

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SHEET NO. SSD-01 78 <sub>OF</sub> 83

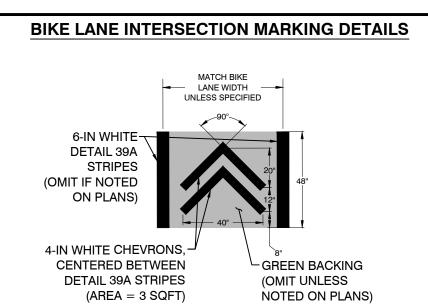


# **GREEN BACKING (OMIT** SHARED ROADWAY **UNLESS NOTED ON BICYCLE MARKING** PLANS) (PER CALTRANS STANDARD PLAN A24C)

**SHARROW SYMBOL DETAIL** 


#### **CONTINENTAL CROSSWALK DETAIL** CURB FACE 2-FT CONTINENTAL -BACK OF PEDESTRIAN CROSSWALK STRIPES. WALKWAY PER CALTRANS STD. PLAN A24F --CROSSWALK EXTENTS ARE TYPICALLY ALIGNED WITH THE CURB FACE AND BACK ALIGN CROSSWALK OF PEDESTRIAN WALKWAY. STRIPES PARALLEL SEE NOTE 2 TO ROADWAY CENTERLINE 10' MIN. SEE NOTE 1 SEE NOTE 2 LANDING 2' CLEAR AREA \ TYP. **DIAGONAL RAMP** LANDINGS DIRECTIONAL (NON-STANDRD) RAMP LANDINGS SEE NOTE 3 **SEE NOTE 3**

# TWO-STAGE TURN BOX DETAIL

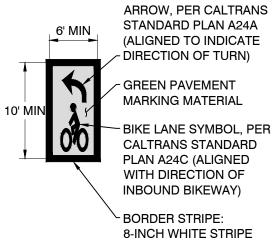

HALF-SIZED TYPE IV TURN

# **BIKE/PED PATH CROSSWALK DETAIL**

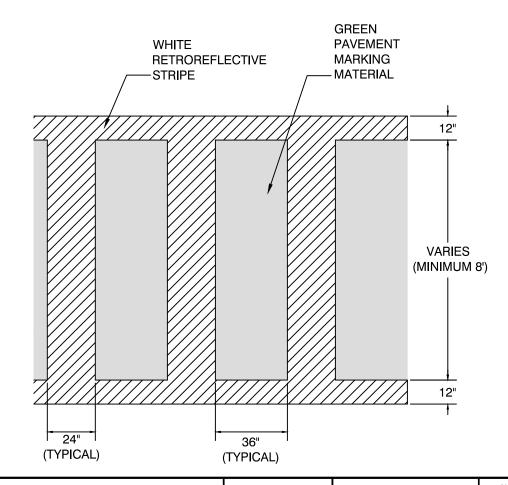

# **NOTES**

- Continental crosswalk stripe spacing is 4 ft, on-center, unless otherwise specified. Align first crosswalk stripe with centerline of roadway and continue pattern toward edge of roadway, maintaining 2 ft clear from face of curb (if present).
- Crosswalks should encompass the pedestrian walkways they connect. Unless otherwise specified, align the front of the crosswalk with the curb face at the corresponding curb returns. Align the back of the crosswalk with the back of the pedestrian walkway but no less than 10 ft back from the front of the crosswalk.
- Crosswalks must encompass the curb ramp landing areas they connect. Directional ramps are the preferred standard, but where a single diagonal ramp serves both crosswalks at a corner, the front of the crosswalks may need to be shifted toward the intersection to encompass the entire 5' landing area at the bottom of the curb ramp.
- See Detail RM-4A for supplemental crosswalk layout guidance.
- At controlled approaches, install advanced limit lines with continental crosswalks, per Marking Detail RM-5.

PLAN PRODUCTION WARNING ANSI B (11" X 17") SHEETS. REFER TO GRAPHIC SCALE FOR SHEETS OF DIFFERENT SIZES.

# CITY OF OAKLAND

DEPARTMENT OF TRANSPORTATION 250 FRANK H. OGAWA PI AZA. SLIITE 4314

LAKESHORE AVENUE SEPARATED **BIKE LANES PROJECT** FROM E 18TH STREET TO MACARTHUR BLVD



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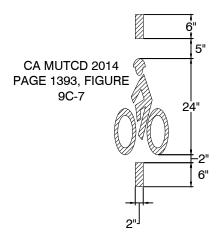
SIGNAGE AND STRIPING DETAILS

PROJECT NO. 1007299

SCALE: NTS


SHEET NO. SSD-02 79 of 83

# **BIKE DETECTOR SYMBOL DETAIL**



INSTALL BIKE DETECTOR MARKING 1 FOOT BACK FROM CROSSWALK AND CENTERED IN LANE, OR AS NOTED

# **ADVANCED YIELD LINE DETAIL**

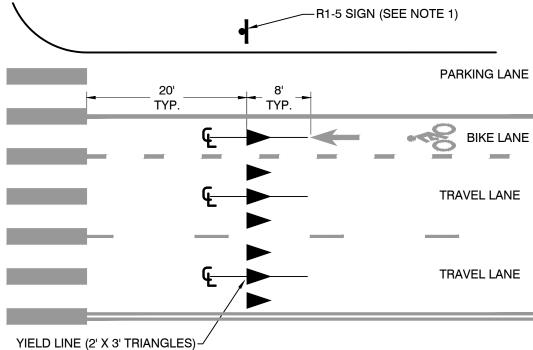

YIELD LINE (2' X 3' TRIANGLES PER CALTRANS STANDARD PLANS A24E, LAYOUT PATTERN AROUND CENTERLINE OF EACH LANE

# NOTES

- 1. INSTALL MUTCD R1-5 SIGN WITH ADVANCED YIELD LINE IF NOTED ON PLANS (AT UNCONTROLLED MULTILANE CROSSWALK APPROACHES)
- 2. ADVANCED YIELD LINES MAY ALSO BE INSTALLED (AS NOTED ON PLANS)
  AT UNCONTROLLED SINGLE LANE CROSSWALK APPROACHES.

PLAN PRODUCTION WARNING
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ANSI B (11" X 17") SHEETS. REFER TO
GRAPHIC SCALE FOR SHEETS OF
DIFFERENT SIZES.



DEPARTMENT OF TRANSPORTATION
250 FRANK H. OGAWA PLAZA, SUITE 4314
OAKLAND, CA 94612
(510) 238-3437
FAX (510) 238-37-227

LAKESHORE AVENUE SEPARATED
BIKE LANES PROJECT
FROM E 18TH STREET TO
MACARTHUR BLVD



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SIGNAGE AND STRIPING DETAILS PROJECT NO. 1007299

SCALE: SS STATE: 11/27/2024 8

SHEET NO. SSD-03 80 of 83

AWING NAME: Z:\Bike-Ped\_

#### **GENERAL NOTES**

- NOT ALL EXISTING EQUIPMENT, CONDUITS, AND PULL BOXES ARE SHOWN ON PLANS. PLANS ONLY SHOW TRAFFIC SIGNAL EQUIPMENT WHEN IMPACTED. EXISTING SIGNAL EQUIPMENT, CONDUITS, AND CONDUCTORS TO REMAIN, UNLESS OTHERWISE NOTED.
- 2. EXISTING SIGNAL PHASING AND SIGNAL CABLE CONDUCTOR PHASE ASSIGNMENTS DEVELOPED USING CITY PROVIDED AS-BUILTS. CONTRACTOR SHALL FIELD VERIFY EXISTING WIRING PRIOR TO
- 3. PROPOSED PULL BOXES SHALL BE CALTRANS NO. 5 UNLESS OTHERWISE NOTED ON PLANS.
- 4. CENTER OF PEDESTRIAN PUSH BUTTONS SHALL BE MOUNTED 3'-6" FROM SIDEWALK GRADE (TO CENTER OF BUTTON). MAXIMUM HORIZONTAL REACH FROM EDGE OF NEAREST SIDEWALK TO PUSH BUTTON SHALL BE 10". INSTALL APS ON EXTENSION BRACKET AS REQUIRED TO MEET 10" REACH REQUIREMENT.

# **CONSTRUCTION NOTES:**

- 1 REMOVE EXISTING Ø2 PPB PEDESTRIAN PUSH BUTTON.
- 2 REPLACE EXISTING WITH NO. 6 PULL BOX.
- 3 REMOVE EXISTING Ø8 PPB.
- REPROGRAM VIDEO DETECTION ZONES FOR NEW BIKE AND VEHICLE LANE CONFIGURATION.
- 5 INSTALL R9-5 SIGN ON POLE.


	CONDUCTOR SCHEDULE												
AWG		NUMBER OF CONDUCTORS											
	CONDUCTOR DESIGNATION	RUN NUMBER											
			/2\	/3\	/4\	/5\	/6\	$\Lambda$	8	᠕	1	/11	
SIGNAL	CABLE 'A'	1	1	1	1		1		(1)		(1)	1	
CABLE	CABLE 'B'	1	1	1	1		1					1	
12C/14TS	CABLE 'C'	1		1	1	1						1	
120/1413	TOTAL SIGNAL CABLE	3	2	3	3	1	2		(1)		(1)	3	
	3C/#14 - Ø2P	2		2	1							2	
PPB	3C/#14 - Ø8P	(1),1	(1)	1	1	1	1	(1)	(1)	(1)	(1)	(1),1	
	TOTAL PPB CABLE		(1)	3	2	1	1	(1)	(1)	(1)	(1)	4	
	ø1 & 6	1	1									1	
	ø2	1		1	1	1						1	
VIDEO	ø8 (BIKE)	(1)	(1)									1	
DETECTION	TOTAL CABLES	3	2	1	1	1						3	
	240V LIGHTING		2	2	2							2	
NO. 8	GROUND		1	1	1	1	1	(1)	(1)	(1)	(1)	1	
	TOTAL NO. 8		3	3	3	1	1	(1)	(1)	(1)	(1)	3	
NO. 10	IISNS(120V)		2	2	2	2							
110. 10	TOTAL NO. 10		2	2	2	2							
NO. 6	FEEDER TO CONTROLLER (120V)	3											
110. 0	TOTAL NO. 6	3											
	PERCENT FILL (%)	10%	17%	25%	23%	9%	12%	5%	8%	5%	3%	149	
	CONDUIT SIZE	2-3"	3"	3"	3"	3"	3"	(2")	(3")	(2")	(3")	3"	

	CONDUCTOR DESIGNATION					RU	JN NU	MRFK				
		/î\	/2\	/3\	/4\	/5\	/6\	矛	8		<i>™</i>	/11
SIGNAL	CABLE 'A'	1	1	1	1		1		(1)		(1)	1
CABLE	CABLE 'B'	1	1	1	1		1					1
12C/14TS	CABLE 'C'	1		1	1	1						1
120/1413	TOTAL SIGNAL CABLE	3	2	3	3	1	2		(1)		(1)	3
	3C/#14 - Ø2P	2		2	1							2
PPB	3C/#14 - Ø8P	(1),1	(1)	1	1	1	1	(1)	(1)	(1)	(1)	(1),1
	TOTAL PPB CABLE	4	(1)	3	2	1	1	(1)	(1)	(1)	(1)	4
	ø1 & 6	1	1									1
	ø2	1		1	1	1						1
VIDEO	ø8 (BIKE)	(1)	(1)									1
DETECTION	TOTAL CABLES	3	2	1	1	1						3
	240V LIGHTING		2	2	2							2
NO. 8	GROUND		1	1	1	1	1	(1)	(1)	(1)	(1)	1
	TOTAL NO. 8		3	3	3	1	1	(1)	(1)	(1)	(1)	3
NO 10	IISNS(120V)		2	2	2	2						
NO. 10	TOTAL NO. 10		2	2	2	2						
NO C	FEEDER TO CONTROLLER (120V)	3										
NO. 6	TOTAL NO. 6	3										
	PERCENT FILL (%)	10%	17%	25%	23%	9%	12%	5%	8%	5%	3%	14%
	CONDUIT SIZE	2-3"	3"	3"	3"	3"	3"	(2")	(3")	(2")	(3")	3"

	POLE AND EQUIPMENT SCHEDULE												
		STANDARD	LED LUM	PED SIGNAL	APS								
LOCATION	CATION TYPE LUMINAIRE MAST A		WATTAGE	MOUNTING	ARROW	SPECIAL REQUIREMENTS							
AE	EX.	EX.	EX.	-	_	-							
В	1-B (7')	_	_	TP-1-T	-	INSTALL NEW TOUCHLESS ACCESSIBLE PEDESTRIAN SIGNAL (APS) WITH R10-3j (CA) SIGN.							
CE	EX.	-	_	_	<b>—</b>	_							
D	TYPE 2 (4'6")	_	-	-	<b>†</b> ‡	INSTALL DOUBLE-SIDED TOUCHLESS ACCESSIBLE PEDESTRIAN SIGNALS (APS) WITH R10-3j (CA) SIGNS FOR USE BY CYCLISTS AND PEDESTRIANS							
E	TYPE 2 (4'6")	-	_	-		INSTALL NEW TOUCHLESS ACCESSIBLE PEDESTRIAN SIGNAL (APS) WITH R10-3j (CA) SIGN.							
F	1-B (7')	_	-	TP-1-T	<b></b>	INSTALL NEW TOUCHLESS ACCESSIBLE PEDESTRIAN SIGNAL (APS) WITH R10-3j (CA) SIGN.							
GE	EX.	EX.	EX.	-	-	REMOVE EXISTING APS FROM POLE G. INSTALL A VIDEO DETECTION CAMERA SIDE-MOUNTED ON POLE.							
Н	TYPE 2 (4'6")	-	_	_	<b>—</b>	INSTALL NEW TOUCHLESS ACCESSIBLE PEDESTRIAN SIGNAL (APS) WITH R10-3j (CA) SIGN.							
lε	EX.	_	-	_	-	REMOVE EXISTING Ø8 APS FROM POLE I. Ø2 APS TO REMAIN.							
J	TYPE 2 (4'6")	_	_	_	+	INSTALL NEW TOUCHLESS ACCESSIBLE PEDESTRIAN SIGNAL (APS) WITH R10-3j (CA) SIGN.							
K <sub>E</sub>	EX.	_	_	_	_	_							

E - DENOTES EXISTING

100% SUBMITTAL NOT FOR BID OR CONSTRUCTION

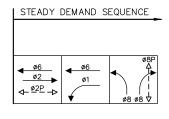

<b>▶</b>	Ø6 Ø1	Ø8P Ø80 Ø80 Ø80 Ø80 Ø80 Ø80 Ø80 Ø80	Ø6 Ø2 ✓ Ø2P →	Ø6 Ø1	Ø8P
				-	

**EXISTING PHASE DIAGRAM** 

| STEADY DEMAND SEQUENCE PROPOSED PHASE DIAGRAM

LAKESHORE AVE  $\triangle$ 0 19+00 \_\_\_\_\_> Ø1+Ø6 

GRAPHIC SCALE IN FEET

DATE

PLAN PRODUCTION WARNING THE PLANS HAVE BEEN CREATED ON ANSI B (11" X 17") SHEETS. REFER TO GRAPHIC SCALE FOR SHEETS OF DIFFERENT SIZES.

REFERENCE

**Kimley** » Horn CHECKED BY RYAN DOLE, P.E. TESSA KEMPER DESIGNED BY PRIYA PALLIVATHUCAL DRAWN BY

sc



PROJECT NO.

1007299

SCALE: AS SHOWN

SHEET NO. E - 0181 OF 83

CITY OF OAKLAND

DEPARTMENT OF TRANSPORTATION 250 FRANK H. OGAWA PLAZA, SUITE 4314 OAKLAND, CA 94612 (510) 238-3437 FAX (510) 238-7227

LAKESHORE AVENUE SEPARATED BIKE LANES PROJECT FROM E 18TH STREET TO MACARTHUR BOULEVARD

	ELECTRICAL PLANS

#### **GENERAL NOTES**

- NOT ALL EXISTING EQUIPMENT, CONDUITS, AND PULL BOXES ARE SHOWN ON PLANS. PLANS ONLY SHOW TRAFFIC SIGNAL EQUIPMENT WHEN IMPACTED. EXISTING SIGNAL EQUIPMENT, CONDUITS, AND CONDUCTORS TO REMAIN, UNLESS OTHERWISE NOTED.
- EXISTING SIGNAL PHASING AND SIGNAL CABLE CONDUCTOR PHASE ASSIGNMENTS DEVELOPED USING CITY PROVIDED AS—BUILTS. CONTRACTOR SHALL FIELD VERIFY EXISTING WIRING PRIOR TO CONSTRUCTION.
- 3. PROPOSED PULL BOXES SHALL BE CALTRANS NO. 5 UNLESS OTHERWISE NOTED ON PLANS.
- 4. CENTER OF PEDESTRIAN PUSH BUTTONS SHALL BE MOUNTED 3'-6" FROM SIDEWALK GRADE (TO CENTER OF BUTTON). MAXIMUM HORIZONTAL REACH FROM EDGE OF NEAREST SIDEWALK TO PUSH BUTTON SHALL BE 10". INSTALL APS ON EXTENSION BRACKET AS REQUIRED TO MEET 10" REACH

#### **CONSTRUCTION NOTES:**


- REPROGRAM VIDEO DETECTION ZONES FOR NEW BIKE AND VEHICLE LANE CONFIGURATION.
- 6 INSTALL APS ON NEW EXTENSION BRACKET SO BUTTON IS LESS THAN 10" FROM EDGE OF CURB RAMP.

	CONDUCTOR SCHEDULE											
AWG		N	IUMBE	R OF	COND	UCTOR	S					
	CONDUCTOR DESIGNATION			RUN N		R						
		/1\	/2\	/3\	/4\	<b>∕</b> 5\	<b>/6</b> \					
0101141	CABLE 'A'	1	1	1	1		_					
SIGNAL	CABLE 'B'	1		1								
CABLE	CABLE 'C'	1										
12C/14TS	TOTAL SIGNAL CABLE	3	1	2	1							
PPB	2C/#14 W/ GROUND - Ø8P	1	1	1	1	(1)	(1)					
PPB	TOTAL 2C/#14 CABLE	1	1	1	1	(1)	(1)					
AUDIBLE	3C/#14 W/ GROUND - AUDIBLE PED. SIGNAL	1	1	1	1							
PED.												
SIGNAL	TOTAL 3C/#14 CABLE	1	1	1	1							
	ø1 & 6	1										
	ø2	1		1	1							
VIDEO	Ø8	1										
DETECTION	TOTAL CABLES	3		1	1							
	240V LIGHTING	2	2	2	2							
NO. 8	GROUND	1	1	1	1	(1)	Έ					
	TOTAL NO. 8	3	3	3	3	(1)	(1)					
	PERCENT FILL (%)	12%	9%	16%	16%	5%	5%					
	CONDUIT SIZE	2-3"	3"	3"	3"	(2")	2					

()- DENOTES NEW

	POLE AND EQUIPMENT SCHEDULE											
		STANDARD		APS								
LOCATION	TYPE	LUMINAIRE MAST ARM	LED LUMINAIRE WATTAGE	ARROW	SPECIAL REQUIREMENTS							
A <sub>E</sub>	A <sub>E</sub> EX. EX.		EX.	+	INSTALL NEW TOUCHLESS ACCESSIBLE PEDESTRIAN SIGNAL (APS) WITH R10-3j (CA) SIGN.							
Bε	EX.	_	_	+	INSTALL NEW TOUCHLESS ACCESSIBLE PEDESTRIAN SIGNAL (APS) WITH R10-3j (CA) SIGN.							
С	TYPE 2 (4'6")		*	INSTALL NEW TOUCHLESS ACCESSIBLE PEDESTRIAN SIGNAL (APS) WITH R10-3j (CA) SIGN.								
D	TYPE 2 (4'6")	_	_	*	INSTALL NEW TOUCHLESS ACCESSIBLE PEDESTRIAN SIGNAL (APS) WITH R10-3j (CA) SIGN.							
Eε	E <sub>E</sub> EX. – –			INSTALL NEW TOUCHLESS ACCESSIBLE PEDESTRIAN SIGNAL (APS) WITH R10-3j (CA) SIGN.								
F€	EX.	EX.	EX.	<b>→</b>	INSTALL NEW TOUCHLESS ACCESSIBLE PEDESTRIAN SIGNAL (APS) WITH R10-3j (CA) SIGN.							

E - DENOTES EXISTING

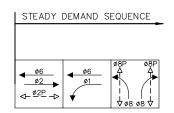

100% SUBMITTAL NOT FOR BID OR CONSTRUCTION

**EXISTING PHASE DIAGRAM (TO REMAIN)** 



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PLAN PRODUCTION WARNING THE PLANS HAVE BEEN CREATED ON ANSI B (11" X 17") SHEETS, REFER TO GRAPHIC SCALE FOR SHEETS OF DIFFERENT SIZES.

**Kimley** »Horn CHECKED BY RYAN DOLE, P.E. TESSA KEMPER DESIGNED BY PRIYA PALLIVATHUCAL DRAWN BY

CB SC

(E)

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34+00



PROJECT NO.

SCALE: AS SHOWN

LAKESHORE AVE

E-02 82 of 83

# CITY OF OAKLAND

DEPARTMENT OF TRANSPORTATION 250 FRANK H. OGAWA PLAZA. SUITE 4314 OAKLAND, CA 94612 (510) 238-3437 FAX (510) 238-7227

LAKESHORE AVENUE SEPARATED BIKE LANES PROJECT FROM E 18TH STREET TO MACARTHUR BOULEVARD

	REFERENCE	BY	DATE	No.
]				
J F				
] [				
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**ELECTRICAL PLANS** 

BROOKL, AVE

#### **GENERAL NOTES**

- NOT ALL EXISTING EQUIPMENT, CONDUITS, AND PULL BOXES ARE SHOWN ON PLANS. PLANS ONLY SHOW TRAFFIC SIGNAL EQUIPMENT WHEN IMPACTED. EXISTING SIGNAL EQUIPMENT, CONDUITS, AND CONDUCTORS TO REMAIN, UNLESS OTHERWISE NOTED.
- 2. EXISTING SIGNAL PHASING AND SIGNAL CABLE CONDUCTOR PHASE ASSIGNMENTS DEVELOPED USING CITY PROVIDED AS—BUILTS. CONTRACTOR SHALL FIELD VERIFY EXISTING WRING PRIOR TO CONSTRUCTION.
- 3. PROPOSED PULL BOXES SHALL BE CALTRANS NO. 5 UNLESS OTHERWISE NOTED ON PLANS.
- 4. CENTER OF PEDESTRIAN PUSH BUTTONS SHALL BE MOUNTED 3'-6" FROM SIDEWALK GRADE (TO CENTER OF FEDERAL POSH BUTTON). MAXIMUM HORIZONTAL REACH FROM EDGE OF NEAREST SIDEWALK TO PUSH BUTTON SHALL BE 10". INSTALL APS ON EXTENSION BRACKET AS REQUIRED TO MEET 10" REACH REQUIREMENT.

#### **CONSTRUCTION NOTES:**

- 4 REPROGRAM VIDEO DETECTION ZONES FOR NEW BIKE AND VEHICLE LANE CONFIGURATION.
- 7 FURNISH AND INSTALL VIDEO DETECTION CAMERA ON EXISTING LUMINAIRE MAST ARM.
- 8 REMOVE AND RELOCATE EXISTING APS ONTO POLE J.
- 9 REMOVE AND RELOCATE EXISTING APS ONTO POLE K.


		ONDU	ICTOR	S SCH	4FDLII	F								
		OUIDO	0101	. 501	ILDUI									
AWG		NUMBER OF CONDUCTORS												
	CONDUCTOR DESIGNATION		RUN NUMBER											
			/2\	/3\	/4\	/5\	/6\	/2\	/8\	/9\	,1ô\			
CIONIAI	CABLE 'A'	/1\	1	1	1	/ 5 \	/ - \	//\	1	/ 3 (	7100			
SIGNAL	CABLE 'B'			1	1				1					
	CABLE 'C'					1	1	1	1	1				
12C/14TS	CABLE 'D'				1			1	1					
	TOTAL SIGNAL CABLE	1	1	2	3	1	1	2	4	1				
	3C/#14 - Ø6P			1	1				1					
PPB	3C/#14 - Ø4P	1	1	1	1	1	1	1	2	1				
	TOTAL PPB CABLE	1	1	2	2	1	1	1	3	1				
	ø2	1	1	1	1			1	1					
	ø4					1	1	1	1					
VIDEO	ø6 & ø1	1	1	1	1				1					
DETECTION				(1)	(1)	1	1	1	3					
	TOTAL CABLES	2	2	3	3	2	2	2	6					
	240V LIGHTING	2	2	2	2			2		2				
NO. 8	GROUND	1	1	1	1	1	1	1	1	1	1			
	TOTAL NO. 8	3	3	3	3	1	1	3	1	3	1			
NO. 10	IISNS(120V)	2	2	2	2			2	2		İ			
110. 10	TOTAL NO. 10	2	2	2	2			2	2		<u> </u>			
NO. 6	FEEDER TO CONTROLLER (120V)										2			
1,0.0	TOTAL NO. 10										2			
											<u> </u>			
	550505 504 (20)	1100		400	400				400		1~			
	PERCENT FILL (%)	11%	11% 3"	19% 3"	18%	8% 3"	9%	14%	12% 2-3"	2% 3"	1% 3"			
	CONDUIT SIZE	3	3	_ 3	3	3	_ 3	_ 3	2-3	_ 3				


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POLE AND EQUIPMENT SCHEDULE									
	STANDARD			APS					
LOCATION	TYPE	LUMINAIRE MAST ARN	LED LUMINAIRE WATTAGE	ARROW	SPECIAL REQUIREMENTS				
AE	EX.	EX.	EX.	-	REMOVE EX. APS FROM EX. POLE AND RELOCATE TO POLE J.				
Bε	EX.	_	_	_	REMOVE EX. APS FROM EX. POLE AND RELOCATE TO POLE K.				
C <sub>E</sub>	EX.	-	-	<b>←</b>	-				
DE	EX.	EX.	EX.	-	INSTALL VIDEO DETECTION CAMERA ON LUMINAIRE MAST ARM.				
Eε	EX.	-	-		-				
Fe	EX.	_	_		_				
GE	EX.	EX.	EX.	-	_				
HE	EX.	_	-	-	_				
l <sub>E</sub>	EX.	EX.	EX.	-	-				
J	TYPE 2 (4'6")	_	_	-	INSTALL RELOCATED EXISTING APS FROM POLE A.				
K	TYPE 2 (4'6")	_	-	-	INSTALL RELOCATED EXISTING APS FROM POLE B.				
F DENOTES	- DENOTES EXISTING								

100% SUBMITTAL NOT FOR BID OR CONSTRUCTION

**EXISTING PHASE DIAGRAM (TO REMAIN)** 



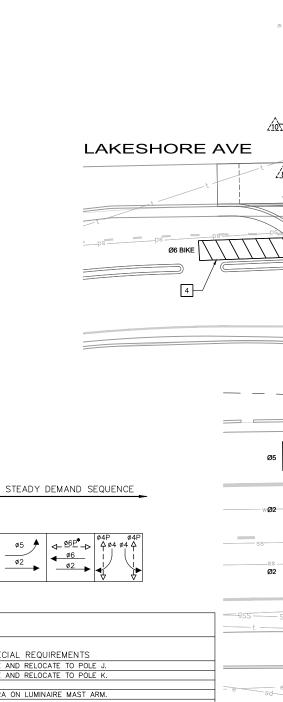

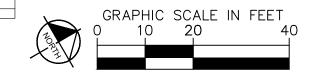Ø4PPB

47+00

# PLAN PRODUCTION WARNING THE PLANS HAVE BEEN CREATED ON ANSI B (11" X 17") SHEETS. REFER TO GRAPHIC SCALE FOR SHEETS OF

# DIFFERENT SIZES.

# **Kimley** »Horn

Ш	CHECKED BY	RYAN DOLE, P.E.
	DESIGNED BY	TESSA KEMPER
	DRAWN BY	PRIYA PALLIVATHUCAL

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PROJECT NO.

1007299

SCALE: AS SHOWN

E - 0383 of 83

# CITY OF OAKLAND

DEPARTMENT OF TRANSPORTATION 250 FRANK H. OGAWA PLAZA. SUITE 4314 OAKLAND, CA 94612 (510) 238-3437 FAX (510) 238-7227

LAKESHORE AVENUE SEPARATED BIKE LANES PROJECT FROM E 18TH STREET TO MACARTHUR BOULEVARD

No.	DATE	BY	REFERENCE	

**ELECTRICAL PLANS**